
# CDBG YEAR 39 RENOVATION OF EXISTING FIRE HOUSE BOROUGH OF WOODLYNNE WOODLYNNE FIRE DEPARTMENT STATION 173 CO. NO. 1


200 COOPER AVENUE WOODLYNNE, NEW JERSEY 08107



304 White Horse Pike Haddon Heights, New Jersey 08035

Tel 856-546-8611 Fax 856-546-8612 www.BachDesignGroup.com

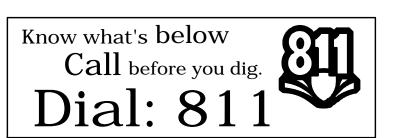

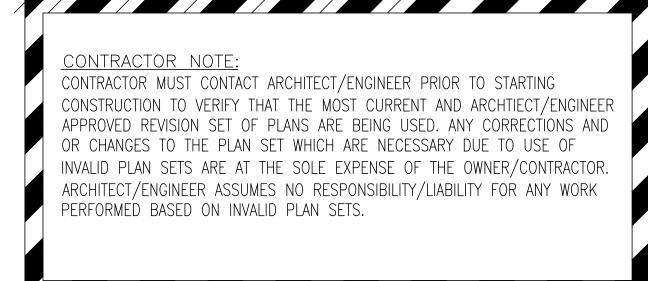

BID PACKAGE" IS INCLUSIVE OF ALL DRAWING SHEETS LISTED ON THIS COVER SUPPLIERS, ETC, WITH COMPLETE BID PACKAGE. FAILURE TO DO SO WILL NOT PRECLUDE RESPONSIBILITY TO PROVIDE ALL WORK DESCRIBED IN THE "BID PACKAGE".

## **Code Review Data:**

APPLICABLE BUILDING CODES & GUIDELINES 2018 INTERNATIONAL BUILDING CODE - NEW JERSEY EDITION 2018 INTERNATIONAL MECHANICAL CODE 2018 INTERNATIONAL FUEL GAS CODE 2018 NATIONAL STANDARD PLUMBING CODE

USE GROUP CLASSIFICATION (304.1) B-BUSINESS

2009 ICC/ANSI A117.1

B-BUSINESS: 6,782 SF

TYPE OF CONSTRUCTION (CHAPTER 6)

HEIGHT LIMITATIONS (TABLE 504.3) STORY LIMITATIONS (TABLE 504.4) B-BUSINESS, 2 STORY (VB CONSTRUCTION, NOT SPRINKLERED) AREA LIMITATIONS (TABLE 506.2) B-BUSINESS, 9,000 SF- (VB CONSTRUCTION, NOT SPRINKLERED) ARFA OF FLOOR PLAN:

## **Index of Drawings:**

**COVER SHEET AND INDEX OF DRAWINGS** 

**DEMOLITION PARTIAL FLOOR PLAN AND ELEVATION** 

**DEMOLITION SECTION D-2** 

**DEMOLITION PARTIAL CEILING PLAN** 

PARTIAL FLOOR PLAN AND ELEVATION

**SECTIONS AND DETAILS A-2 SECTIONS AND DETAILS A-3** 

FLOOR PLAN, ELEVATION, AND DETAILS **S-1** 

BOROUGH

Iaddon Heights, New Jersey 0803 Tel: 856-546-8611 Fax: 856-546-8612

www.BachDesignGroup.com


NOVATION (WOODLYNI

AND EX	PENSES ARISING OUT OF OR RESULTING T	HEREF
REVISIONS		
NO.	DESCRIPTION	DA1

**COVER SHEET AND INDEX OF DRAWINGS** 

DESIGNED BY: WDLYN2020-2 CHECKED BY: S SHOWN AWING NUMBER:

**C-1** 

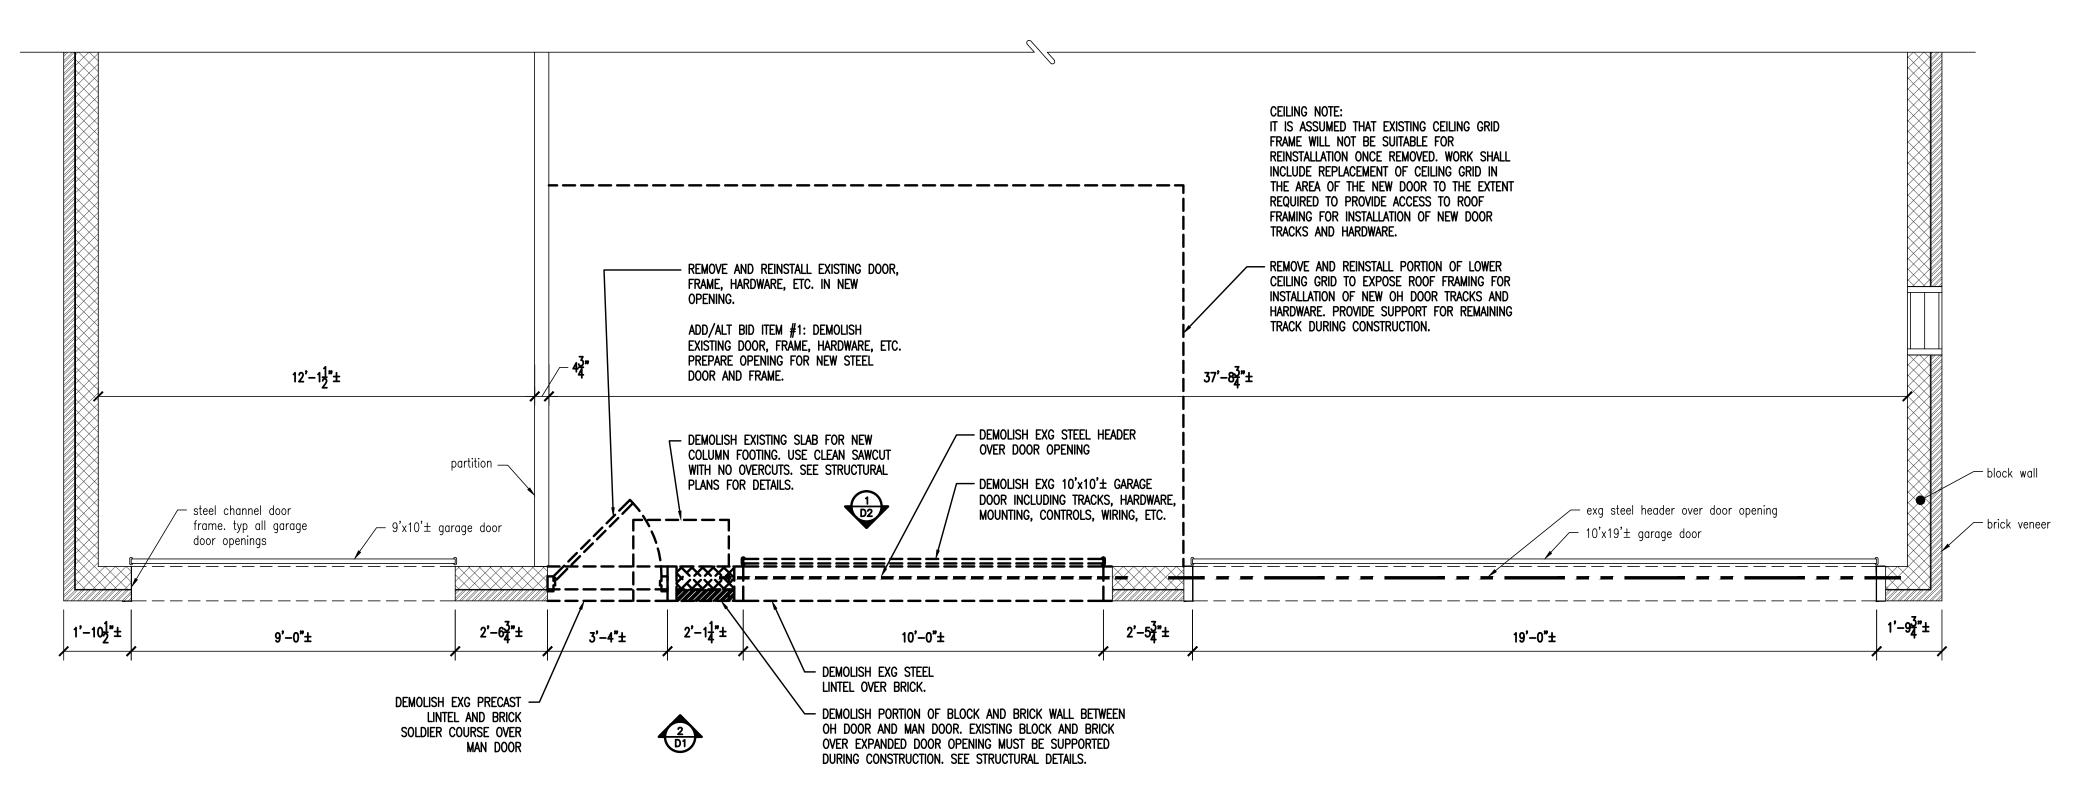

**2 SECTION - EXISTING HEADER** SCALE: 3/4" = 1'-0"

existing block wall existing brick veneer DEMOLISH EXG STEEL HEADER OVER DOOR DEMOLISH EXISTING BRICK VENEER FOR INSTALLATION OF NEW HEADER EXISTING BLOCK AND BRICK OVER EXPANDED DOOR OPENING MUST BE — EXISTING STEEL LINTEL SUPPORTED DURING CONSTRUCTION. SEE - DEMOLISH EXG STEEL STRUCTURAL DETAILS. CHANNEL AROUND DOOR OPENING

STEVEN M. BACH, PE, RA, PP, CME NJ PROFESSIONAL ENGINEER No. GE 4150 NJ REGISTERED ARCHITECT No. AI 14872

BACH Associates, P

ENGINEERS • ARCHITECTS • PLANNERS

304 White Horse Pike

Haddon Heights, New Jersey 08035

Tel: 856-546-8611

Fax: 856-546-8612

www.BachDesignGroup.com

LL DIMENSIONS MUST BE VERIFIED B CONTRACTOR AND OWNER MUST BE NOTIFIED OF ANY DISCREPANCIES BEFORE PROCEEDING

NJ PROFESSIONAL PLANNER No. LI 05557

WITH THE WORK.

ODLYNNE

BOROUGH OF
CDBG Y
RENOVATION OF EXI
WOODLYNNE FIR

ALL DOCUMENTS PREPARED BY BACH ASSOCIATES, PC ARE INSTRUMENTS OF SERVICE IN RESPECT OF THE PROJECT. THEY ARE NOT INTENDED OR REPRESENTED TO BE SUITABLE FOR REUSE BY OWNER OR OTHERS ON EXTENSIONS OF THE PROJECT OR ON ANY OTHER PROJECT. ANY REUSE WITHOUT WRITTEN VERIFICATION OR ADAPTATION BY BACH ASSOCIATES, PC FOR THE SPECIFIC PURPOSE INTENDED WILL BE AT OWNERS SOLE RISK AND WITHOUT LABILITY OR LEGAL EXPOSURE TO DRACH ASSOCIATES. PC: AND OWNER SHALL INDEPANIEY AND HOLD BACH ASSOCIATES, PC; AND OWNER SHALL INDEMNIFY AND HOLE HARMLESS BACH ASSOCIATES, PC FROM ALL CLAIMS, DAMAGES, LOSSES AND EXPENSES ARISING OUT OF OR RESULTING THEREFROM

DESCRIPTION


**DEMOLITION PARTIAL FLOOR PLAN AND ELEVATION** 

DESIGNED BY: WDLYN2020-2 DRAWN BY: 2-8-21 CHECKED BY: AS SHOWN DM3 DRAWING NUMBER:

**D-1** 

PARTIAL DEMOLITION FLOOR PLAN

SCALE: 3/8" = 1'-0"

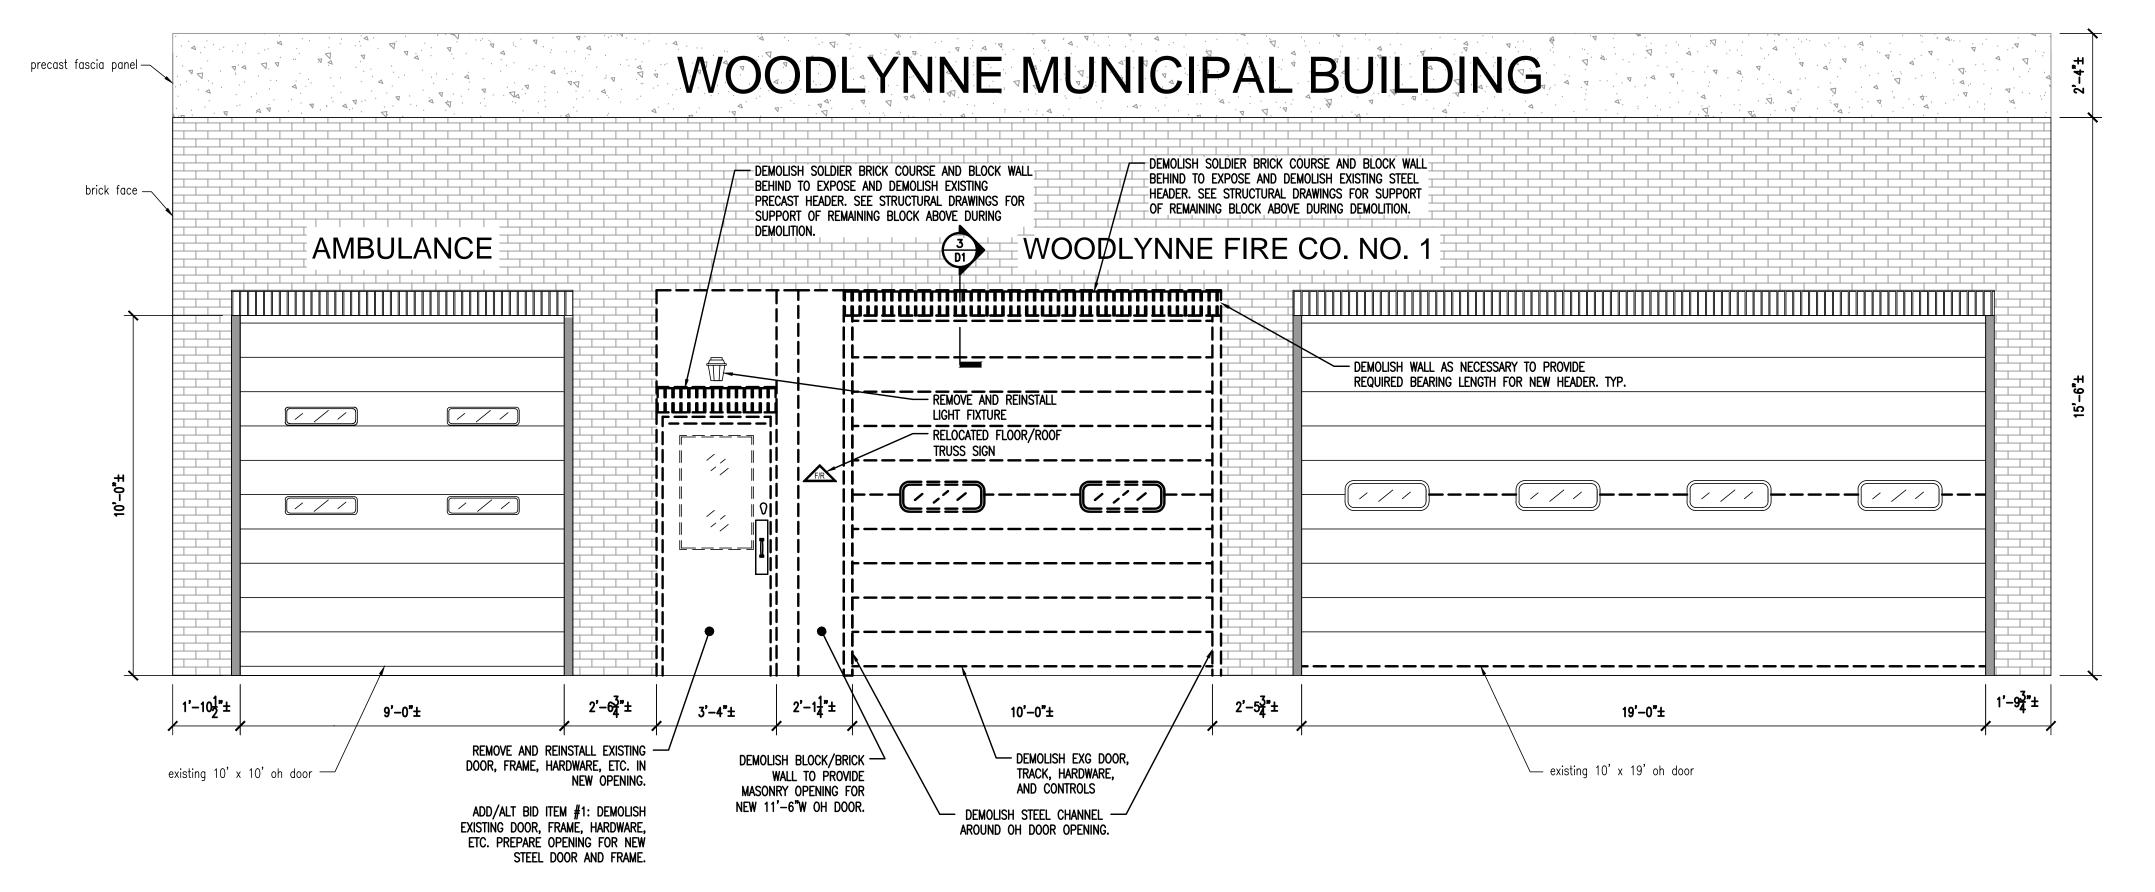


o DEMOLITION FRONT ELEVATION SCALE: 3/8" = 1'-0"

COPYRIGHT © 2020 ALL RIGHTS RESERVED BY BACH ASSOCIATES, PC. NOT TO BE COPIED OR REPRODUCED WITHOUT WRITTEN PERMISSION.

ALL EXISTING ELECTRICAL CONDUIT AND OTHER INFRASTRUCTURE DISTURBED BY EXPANSION OF GARAGE DOOR OPENING IS TO BE REROUTED AROUND NEW OPENING AND, IF NECESSARY DUE TO LONGER RUNS, DEVICES ARE TO BE REFED

IN NEW CONDUITS.

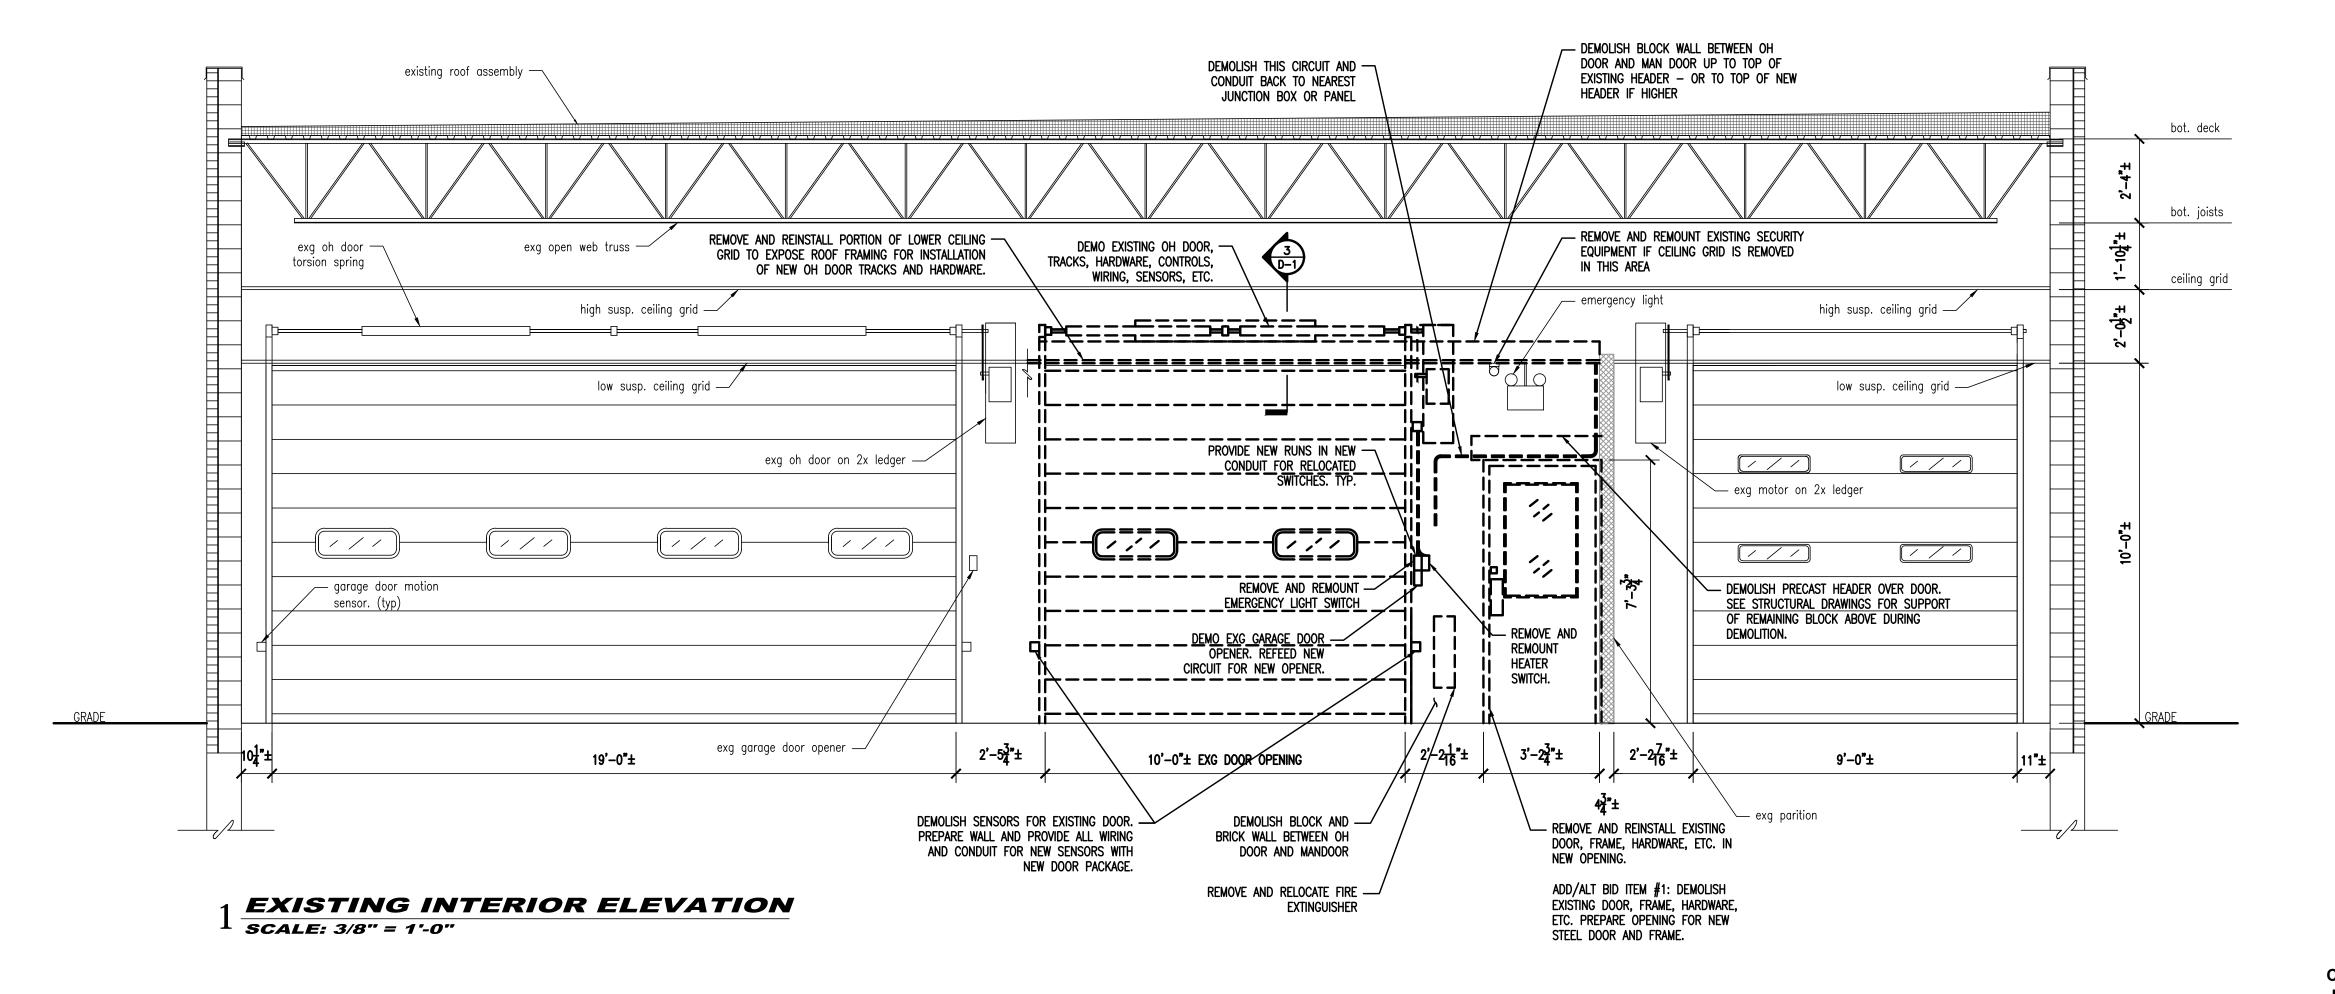

ALL EXISTING ELECTRICAL CONDUIT AND OTHER INFRASTRUCTURE DISTURBED BY EXPANSION OF GARAGE DOOR OPENING IS TO BE REROUTED AROUND NEW OPENING AND IF NECESSARY DUE TO LONGER RUNS, DEVICES ARE TO BE REFED IN NEW CONDUITS.

BACH Associates, PC ENGINEERS • ARCHITECTS • PLANNERS

304 White Horse Pike Haddon Heights, New Jersey 08035 Tel: 856-546-8611

Fax: 856-546-8612 www.BachDesignGroup.com

STEVEN M. BACH, PE, RA, PP, CME

NJ PROFESSIONAL ENGINEER No. GE 41507 NJ REGISTERED ARCHITECT No. AI 14872 NJ PROFESSIONAL PLANNER No. LI 05557

ALL DIMENSIONS MUST BE VERIFIED BY CONTRACTOR AND OWNER MUST BE NOTIFIED OF ANY DISCREPANCIES BEFORE PROCEEDING WITH THE WORK.

**WOODLYNNE** 


BOROUGH OF CDBG YI CDBG YI CDOVATION OF EXI WOODLYNNE FIRE STATION 173

ALL DOCUMENTS PREPARED BY BACH ASSOCIATES, PC ARE INSTRUMENTS OF SERVICE IN RESPECT OF THE PROJECT. THEY ARE NOT INTENDED OR REPRESENTED TO BE SUITABLE FOR REUSE BY OWNER OR OTHERS ON EXTENSIONS OF THE PROJECT OR ON ANY OTHER PROJECT. ANY REUSE WITHOUT WRITTEN VERIFICATION OR ADAPTATION BY BACH ASSOCIATES, PC FOR THE SPECIFIC PURPOSE INTENDED WILL BE AT OWNERS SOLE RISK AND WITHOUT LIABILITY OR LEGAL EXPOSURE TO BACH ASSOCIATES, PC; AND OWNER SHALL INDEMNIFY AND HOLD HARMLESS BACH ASSOCIATES, PC FROM ALL CLAIMS, DAMAGES, LOSSES AND EXPENSES ARISING OUT OF OR RESULTING THEREFROM.

DESCRIPTION

**DEMOLITION SECTION** 

DESIGNED BY: WDLYN2020-2 DRAWN BY: CHECKED BY: AS SHOWN DRAWING NUMBER:

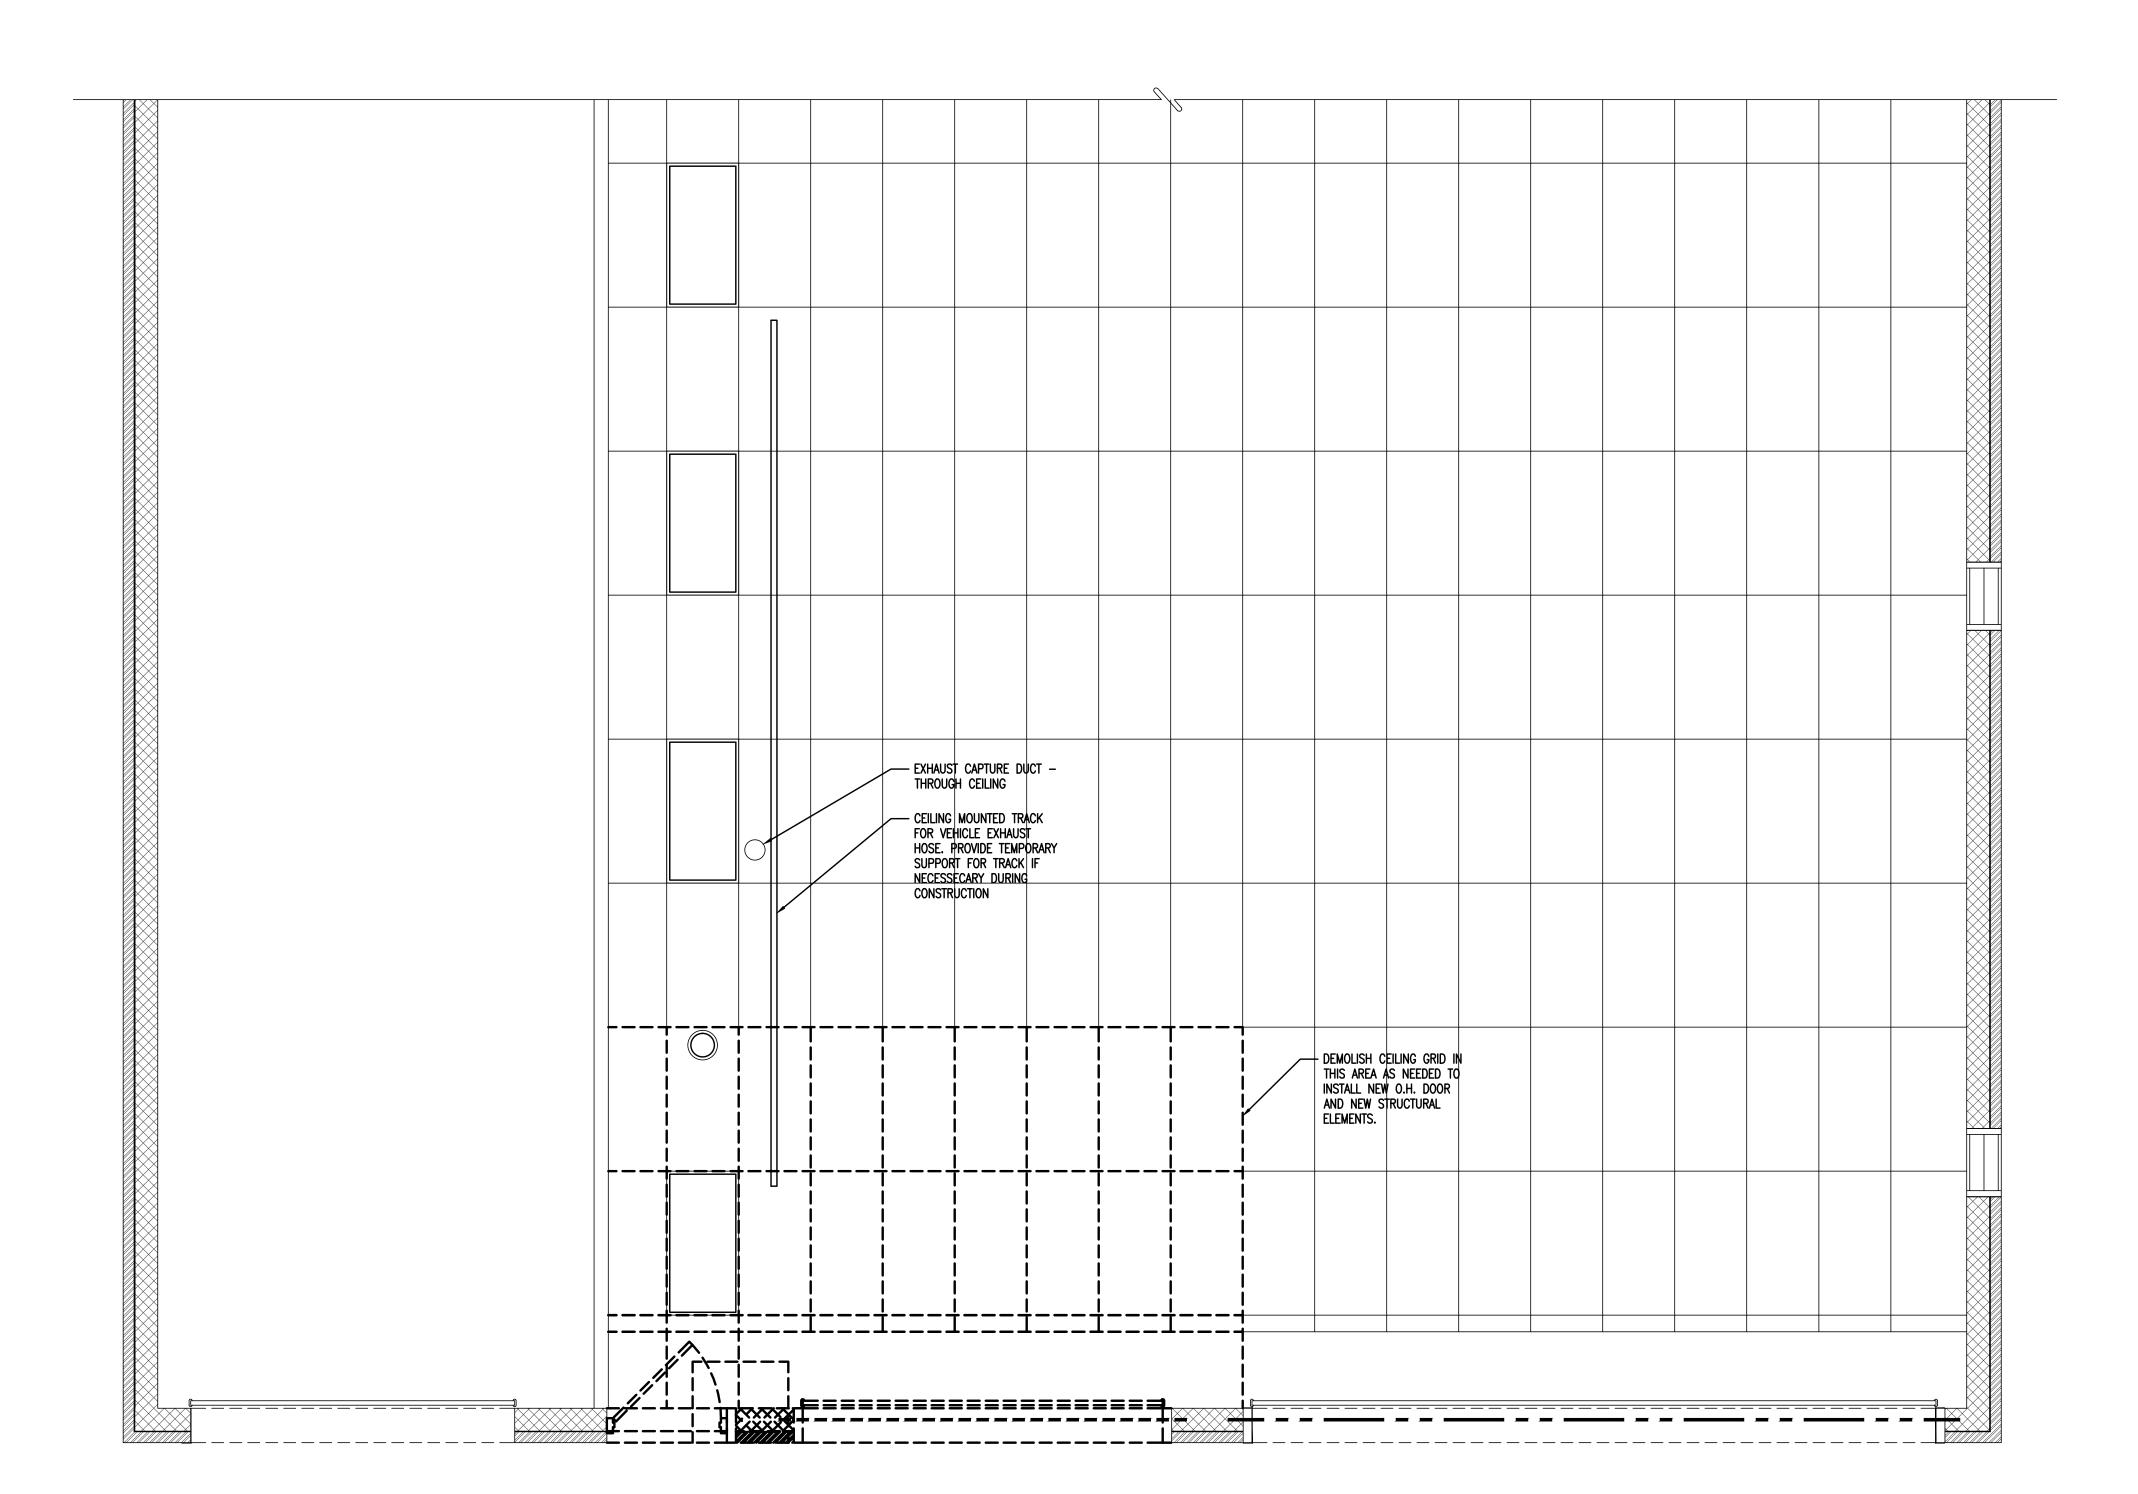

BACH Associates, PC ENGINEERS • ARCHITECTS • PLANNERS

304 White Horse Pike Haddon Heights, New Jersey 08035 Tel: 856-546-8611 Fax: 856-546-8612

www.BachDesignGroup.com

STEVEN M. BACH, PE, RA, PP, CME

NJ PROFESSIONAL ENGINEER No. GE 41507 NJ REGISTERED ARCHITECT No. AI 14872 NJ PROFESSIONAL PLANNER No. LI 05557

ALL DIMENSIONS MUST BE VERIFIED BY CONTRACTOR AND OWNER MUST BE NOTIFIED OF ANY DISCREPANCIES BEFORE PROCEEDING WITH THE WORK.

# BOROUGH OF WOODLYNNE CDBG YEAR 39 RENOVATION OF EXISTING FIRE HOUSE WOODLYNNE FIRE DEPARTMENT STATION 173 CO. NO. 1


ALL DOCUMENTS PREPARED BY BACH ASSOCIATES, PC ARE INSTRUMENTS OF SERVICE IN RESPECT OF THE PROJECT. THEY ARE NOT INTENDED OR REPRESENTED TO BE SUITABLE FOR REUSE BY OWNER OR OTHERS ON EXTENSIONS OF THE PROJECT OR ON ANY OTHER PROJECT. ANY REUSE WITHOUT WRITTEN VERIFICATION OR ADAPTATION BY BACH ASSOCIATES, PC FOR THE SPECIFIC PURPOSE INTENDED WILL BE AT OWNERS SOLE RISK AND WITHOUT LIABILITY OR LEGAL EXPOSURE TO BACH ASSOCIATES, PC; AND OWNER SHALL INDEMNIFY AND HOLD HARMLESS BACH ASSOCIATES, PC FROM ALL CLAIMS, DAMAGES, LOSSES AND EXPENSES ARISING OUT OF OR RESULTING THEREFROM.


DESCRIPTION

**DEMOLITION PARTIAL CEILING PLAN** 

DESIGNED BY: WDLYN2020-2 DRAWN BY: CHECKED BY: AS SHOWN DRAWING NUMBER:

**D-3** 

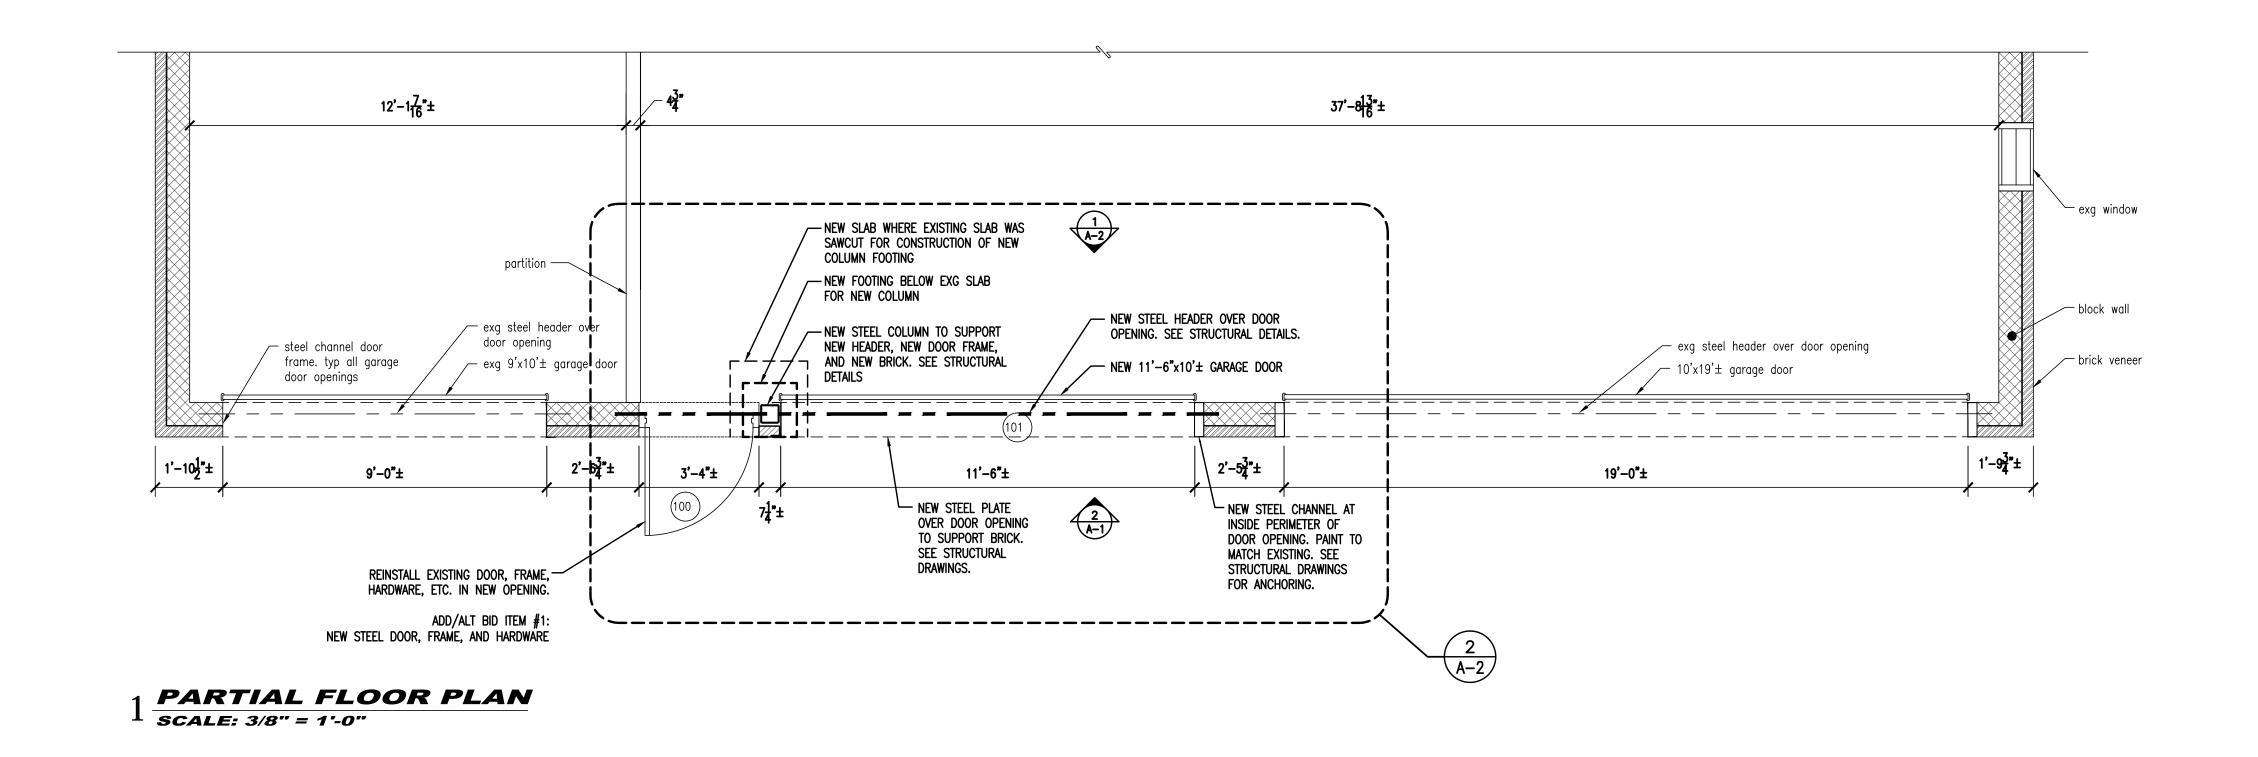

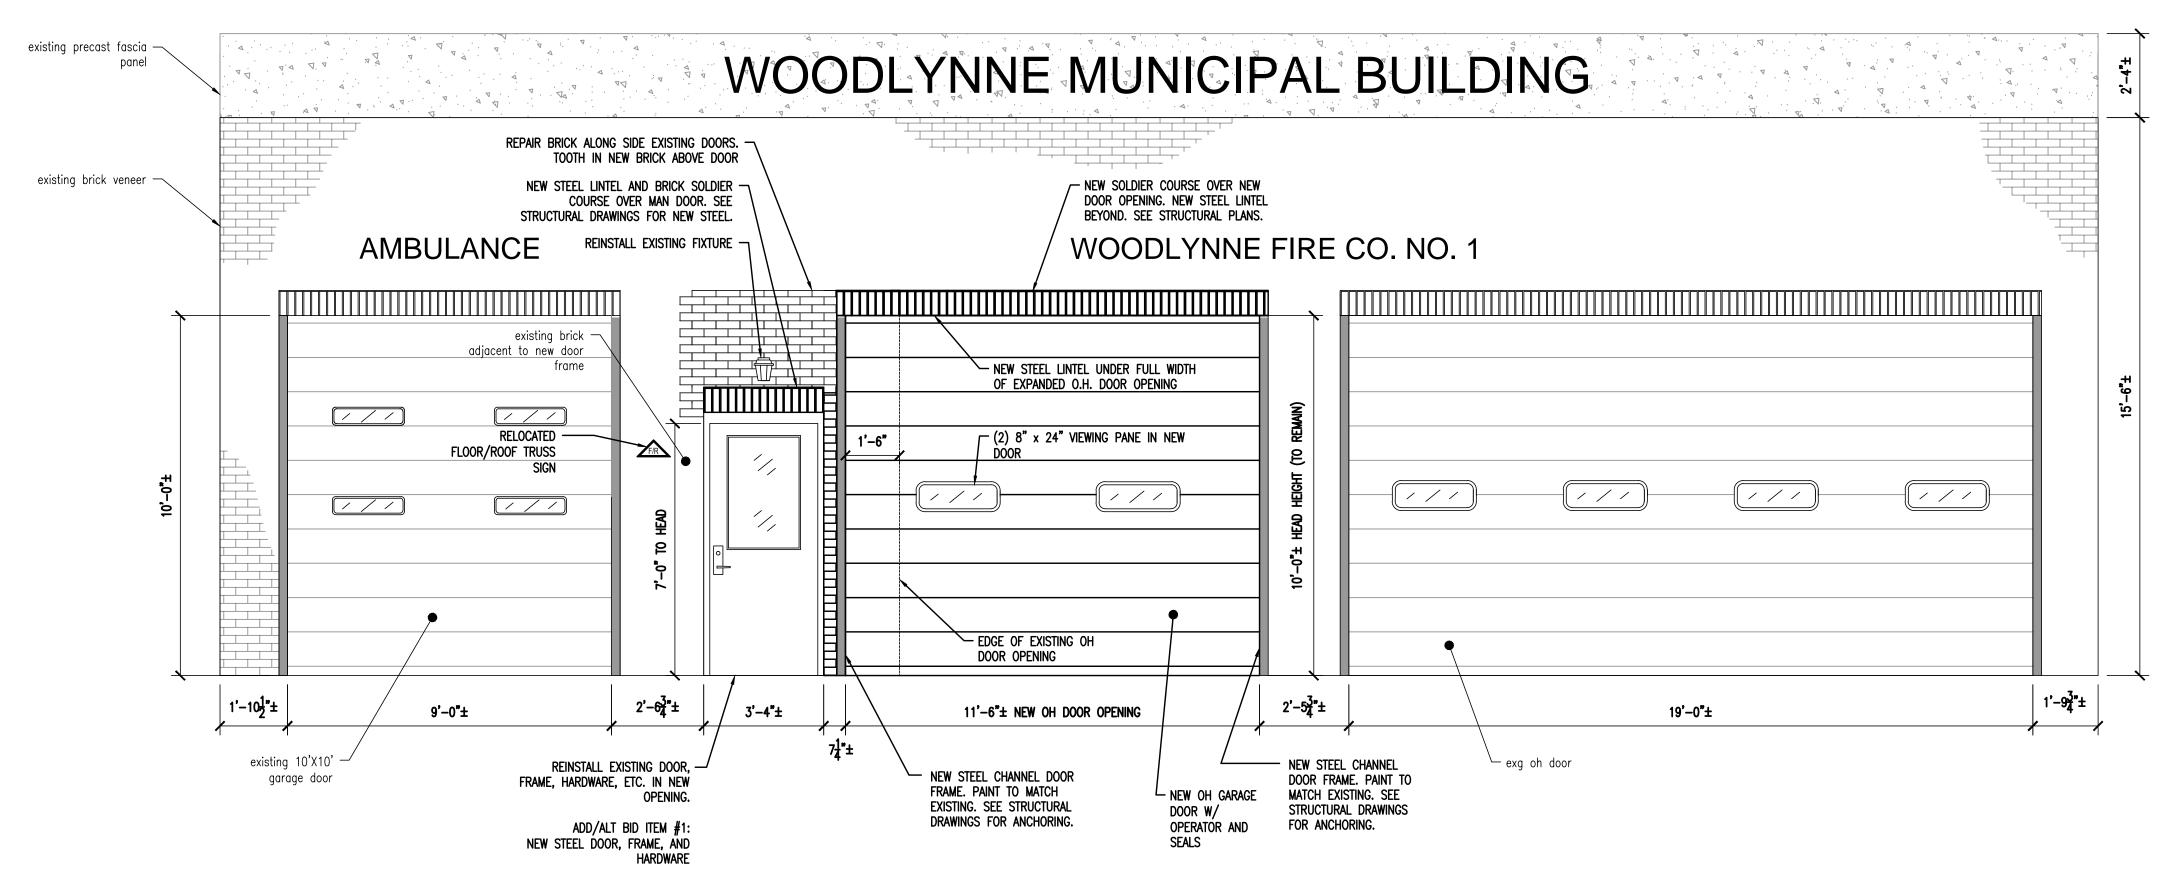

2 FRONT ELEVATION SCALE: 3/8" = 1'-0"

ALL EXISTING ELECTRICAL CONDUIT AND OTHER INFRASTRUCTURE DISTURBED BY EXPANSION OF GARAGE DOOR OPENING IS TO BE REROUTED AROUND NEW OPENING AND IF NECESSARY DUE TO LONGER RUNS, DEVICES ARE TO BE REFED IN NEW CONDUITS.

BA

BACH Associates, PC ENGINEERS • ARCHITECTS • PLANNERS

304 White Horse Pike Haddon Heights, New Jersey 08035 Tel: 856-546-8611 Fax: 856-546-8612

www.BachDesignGroup.com

0511.0

STEVEN M. BACH, PE, RA, PP, CME

NJ PROFESSIONAL ENGINEER No. GE 41507 NJ REGISTERED ARCHITECT No. AI 14872 NJ PROFESSIONAL PLANNER No. LI 05557

ALL DIMENSIONS MUST BE VERIFIED BY CONTRACTOR AND OWNER MUST BE NOTIFIED OF ANY DISCREPANCIES BEFORE PROCEEDING WITH THE WORK

173 CO. NO. 1
OPER AVE.
NEW JERSEY 08107
NITY NEW IERSEY

BOROUGH OF W
CDBG YEA
RENOVATION OF EXIS
WOODLYNNE FIRE
STATION 173 (
STATION 173 (
WOODLYNNE, NEW J

ALL DOCUMENTS PREPARED BY BACH ASSOCIATES, PC ARE INSTRUMENTS OF SERVICE IN RESPECT OF THE PROJECT. THEY ARE NOT INTENDED OR REPRESENTED TO BE SUITABLE FOR REUSE BY OWNER OR OTHERS ON EXTENSIONS OF THE PROJECT OR ON ANY OTHER PROJECT. ANY REUSE WITHOUT WRITTEN VERIFICATION OR ADAPTATION BY BACH ASSOCIATES, PC FOR THE SPECIFIC PURPOSE INTENDED WILL BE AT OWNERS SOLE RISK AND WITHOUT LIABILITY OR LEGAL EXPOSURE TO BACH ASSOCIATES, PC; AND OWNER SHALL INDEMNIFY AND HOLD HARMLESS BACH ASSOCIATES, PC FROM ALL CLAIMS, DAMAGES, LOSSES AND EXPENSES ARISING OUT OF OR RESULTING THEREFROM.


NO. DESCRIPTION DA

PARTIAL FLOOR PLAN AND ELEVATION


JOB NO:
WDLYN2020-2
DATE:
2-8-21
DCHECKED BY:
AAW

CHECKED BY:
AS SHOWN
DRAWING NUMBER:

**A-1** 

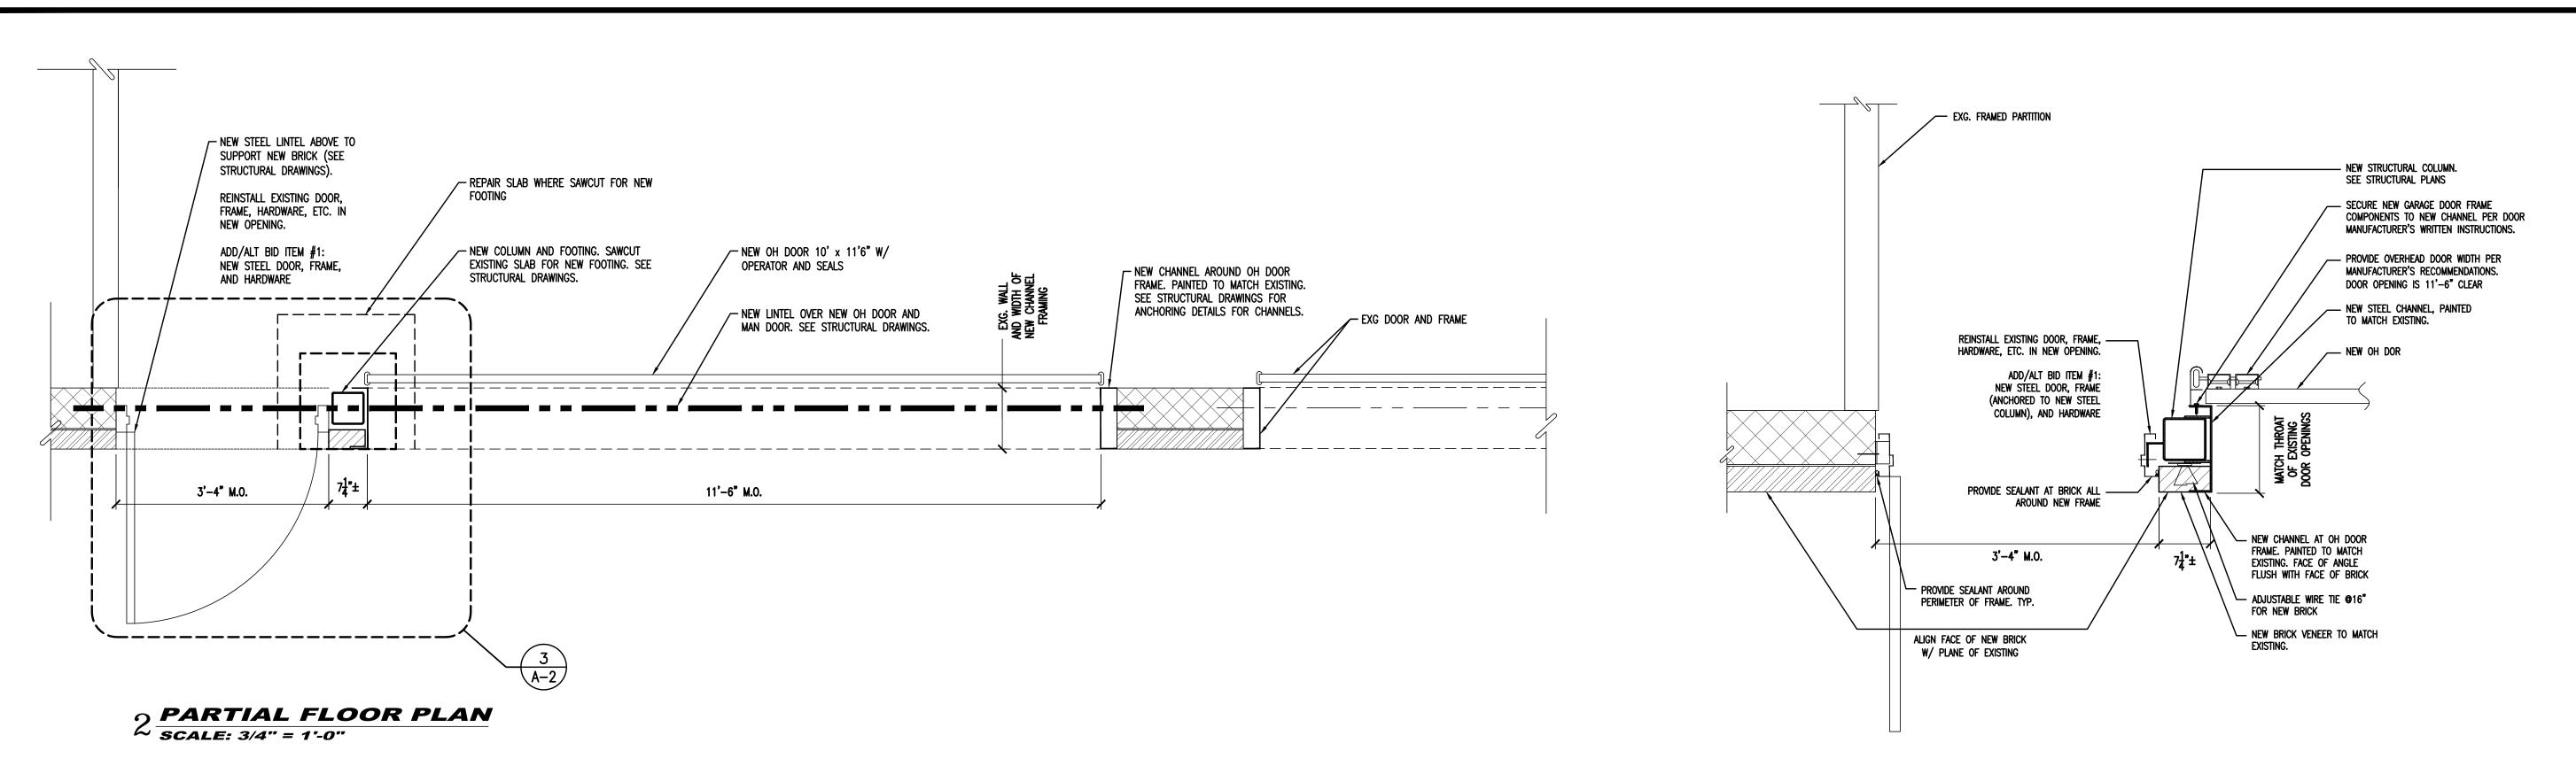

3 DETAIL = NEW COLUMN
SCALE: 1" = 1'-0"

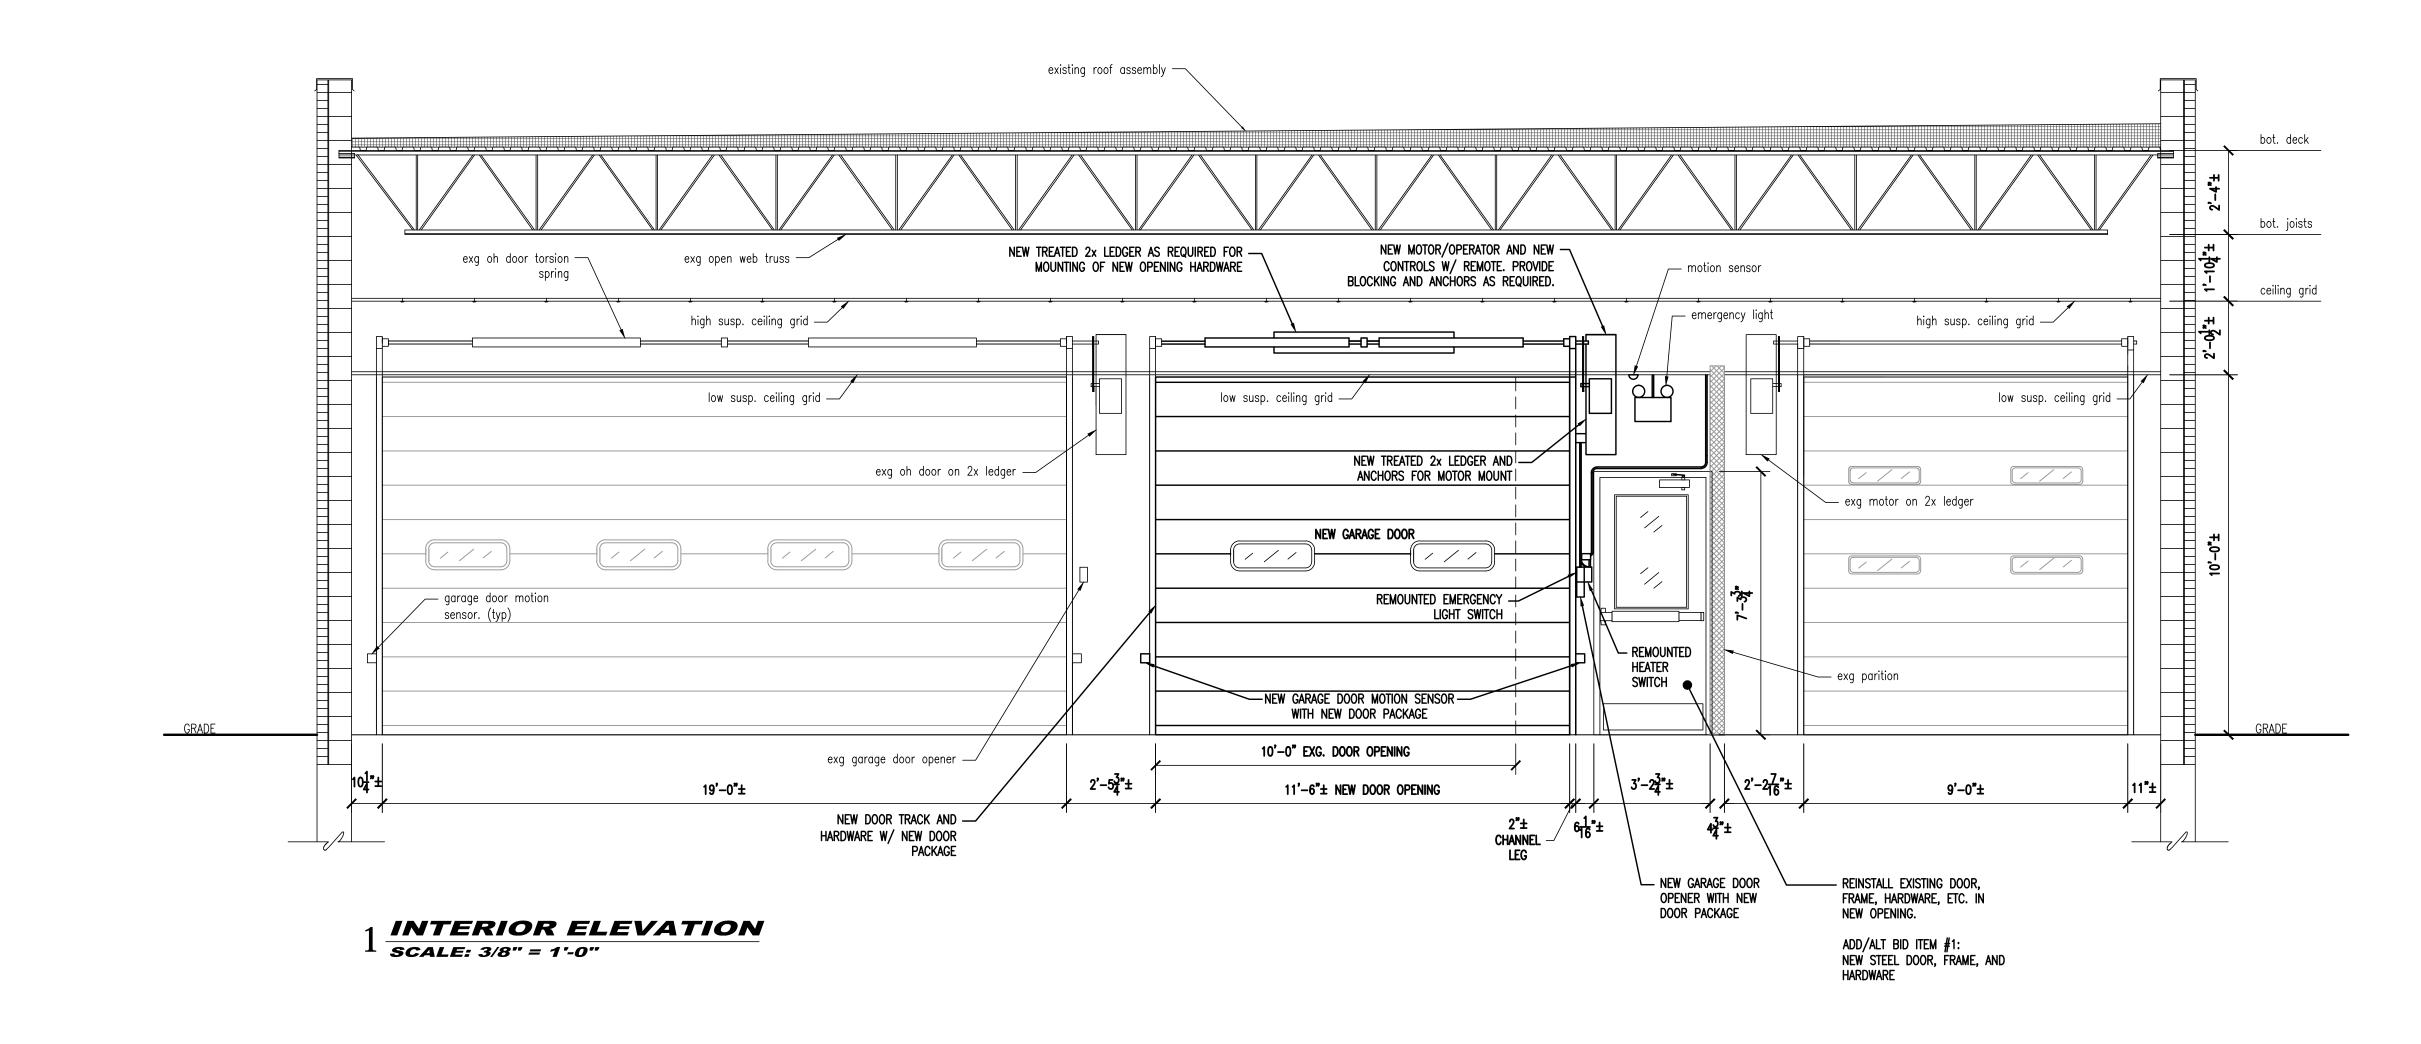

COPYRIGHT © 2020 ALL RIGHTS RESERVED BY BACH ASSOCIATES, PC. NOT TO BE COPIED OR REPRODUCED WITHOUT WRITTEN PERMISSION.



BACH Associates, PC ENGINEERS • ARCHITECTS • PLANNERS

304 White Horse Pike Haddon Heights, New Jersey 08035 Tel: 856-546-8611 Fax: 856-546-8612

www.BachDesignGroup.com

STEVEN M. BACH, PE, RA, PP, CME

NJ PROFESSIONAL ENGINEER No. GE 41507 NJ REGISTERED ARCHITECT No. AI 14872 NJ PROFESSIONAL PLANNER No. LI 05557

ALL DIMENSIONS MUST BE VERIFIED BY CONTRACTOR AND OWNER MUST BE NOTIFIED OF ANY DISCREPANCIES BEFORE PROCEEDING WITH THE WORK.

ODLYNNE


BOROUGH O
CDBG
RENOVATION OF E
WOODLYNNE F
STATION

ALL DOCUMENTS PREPARED BY BACH ASSOCIATES, PC ARE INSTRUMENTS OF SERVICE IN RESPECT OF THE PROJECT. THEY ARE NOT INTENDED OR REPRESENTED TO BE SUITABLE FOR REUSE BY OWNER OR OTHERS ON EXTENSIONS OF THE PROJECT OR ON ANY OTHER PROJECT. ANY REUSE WITHOUT WRITTEN VERIFICATION OR ADAPTATION BY BACH ASSOCIATES, PC FOR THE SPECIFIC PURPOSE INTENDED WILL BE AT OWNERS SOLE RISK AND WITHOUT LIABILITY OR LEGAL EXPOSURE TO BACH ASSOCIATES, PC; AND OWNER SHALL INDEMNIFY AND HOLD HARMLESS BACH ASSOCIATES, PC FROM ALL CLAIMS, DAMAGES, LOSSES AND EXPENSES ARISING OUT OF OR RESULTING THEREFROM.

REVISIONS				
NO.	DESCRIPTION	DATE		
DAWING TITLE:				


**SECTIONS AND DETAILS** 

JOB NO: WDLYN2020-2	DESIGNED BY: AAW
DATE: 2-8-21	DRAWN BY: AAW
SCALE: AS SHOWN	CHECKED BY: DM3
DRAWING NUMBER:	

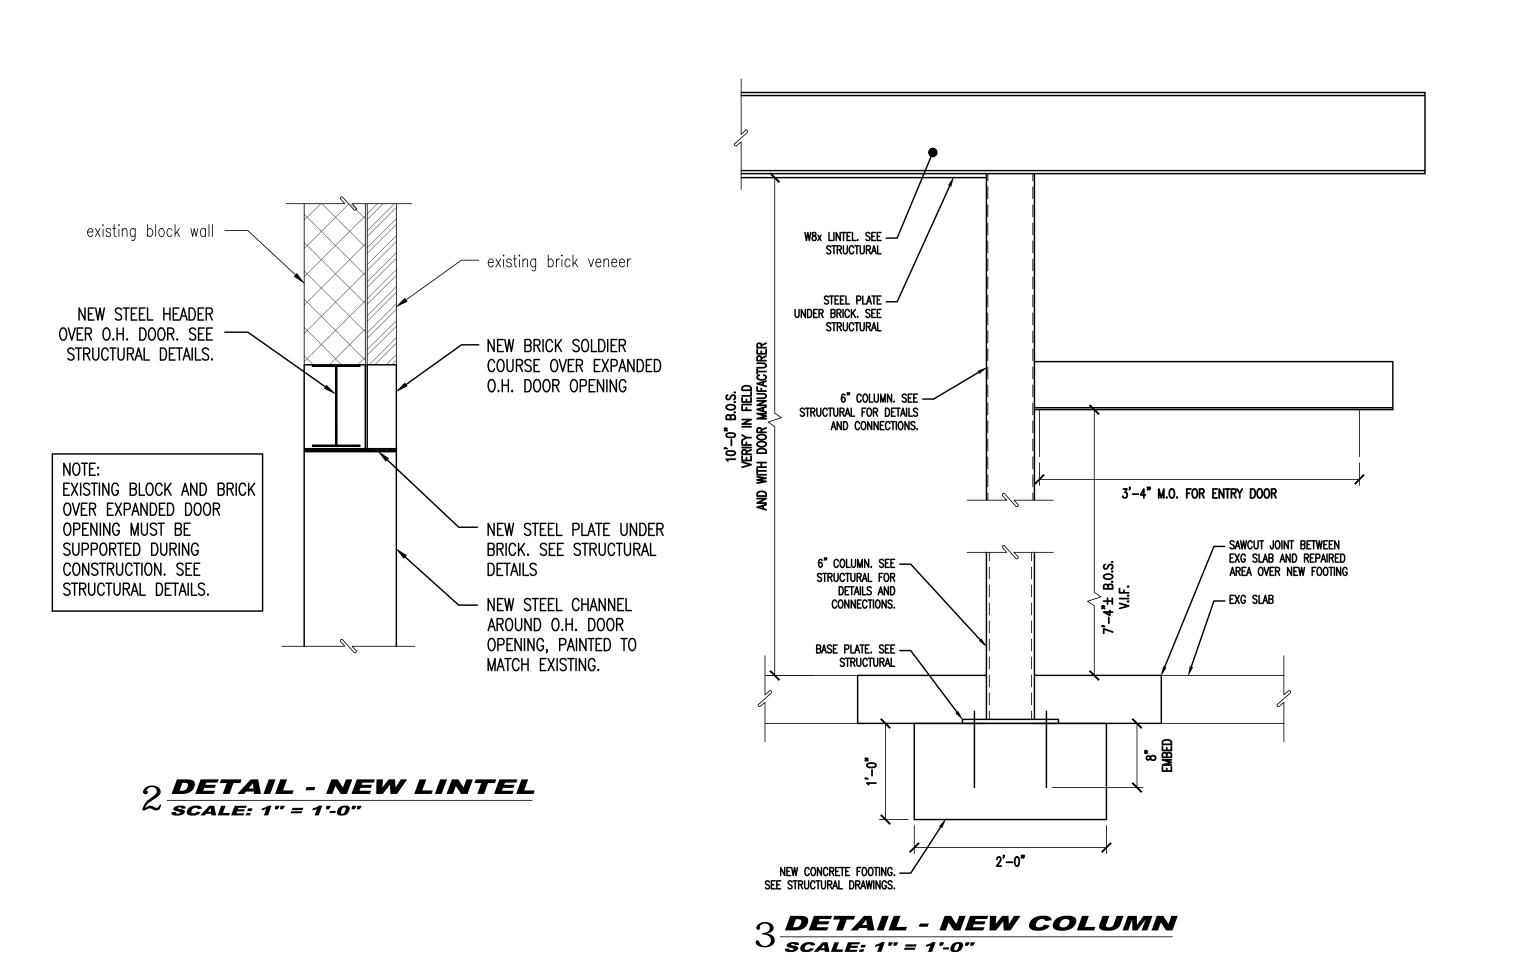

NEW O.H. DOOR TRACK -WEB OF CHANNEL AND TO FACE OF TUBE COLUMN. NEW 6" STEEL -COLUMN NEW (OR EXISTING) DOOR FRAME 1" ANGLE - FULL HEIGHT, TRIMMED TO SUIT GAP BETWEEN FRAME AND COLUMN. WELD TO COLUMN. JAM SCREWED TO ADJUSTABLE WIRE TIE FACE OF CHANNEL FLUSH WITH FACE OF **NEW BRICK** 

4 DETAIL - CONNECTIONS @ NEW COLUMN SCALE: 3" = 1'-0"

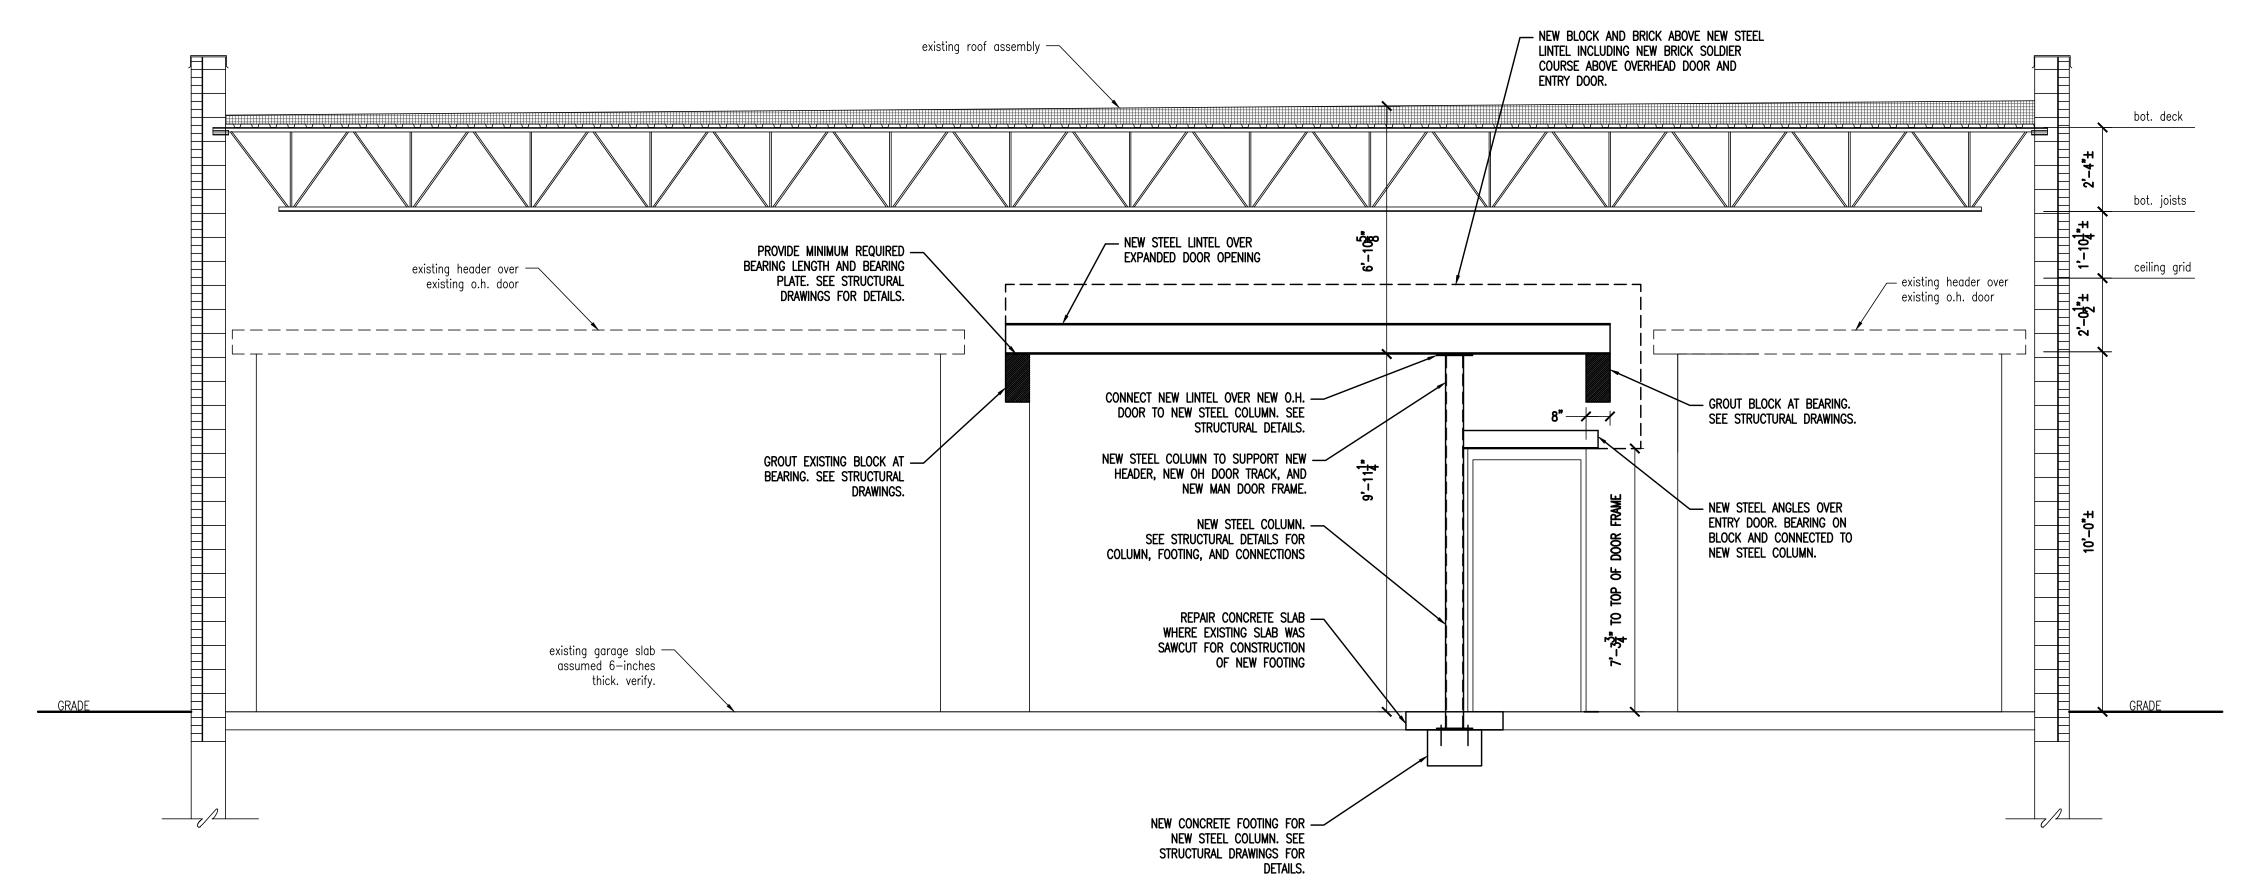

FRAMING ELEVATION SCALE: 3/8" = 1'-0"

> COPYRIGHT © 2020 ALL RIGHTS RESERVED BY BACH ASSOCIATES, PC. NOT TO BE COPIED OR REPRODUCED WITHOUT WRITTEN PERMISSION.

BACH Associates, PC ENGINEERS • ARCHITECTS • PLANNERS

304 White Horse Pike Haddon Heights, New Jersey 08035 Tel: 856-546-8611 Fax: 856-546-8612

www.BachDesignGroup.com

STEVEN M. BACH, PE, RA, PP, CME

NJ PROFESSIONAL ENGINEER No. GE 41507 NJ REGISTERED ARCHITECT No. AI 14872 NJ PROFESSIONAL PLANNER No. LI 05557

ALL DIMENSIONS MUST BE VERIFIED BY CONTRACTOR AND OWNER MUST BE NOTIFIED OF ANY DISCREPANCIES BEFORE PROCEEDING WITH THE WORK.

OF WOODLYNNE

3G YEAR 39
F EXISTING FIRE HOUS
FIRE DEPARTMENT
N 173 CO. NO. 1

BOROUGH OF
CDBG Y
CENOVATION OF EXI
WOODLYNNE FIR ENOV,


ALL DOCUMENTS PREPARED BY BACH ASSOCIATES, PC ARE INSTRUMENTS OF SERVICE IN RESPECT OF THE PROJECT. THEY ARE NOT INTENDED OR REPRESENTED TO BE SUITABLE FOR REUSE BY OWNER OR OTHERS ON EXTENSIONS OF THE PROJECT OR ON ANY OTHER PROJECT. ANY REUSE WITHOUT WRITTEN VERIFICATION OR ADAPTATION BY BACH ASSOCIATES, PC FOR THE SPECIFIC PURPOSE INTENDED WILL BE AT OWNERS SOLE RISK AND WITHOUT LIABILITY OR LEGAL EXPOSURE TO BACH ASSOCIATES, PC; AND OWNER SHALL INDEMNIFY AND HOLD HARMLESS BACH ASSOCIATES, PC FROM ALL CLAIMS, DAMAGES, LOSSES AND EXPENSES ARISING OUT OF OR RESULTING THEREFROM.


	REVISIONS	
NO.	DESCRIPTION	DATE


**SECTIONS AND DETAILS** 


JOB NO: WDLYN2020-2	DESIGNED BY: AAW
DATE: 2-8-21	DRAWN BY: AAW
SCALE: AS SHOWN	CHECKED BY: DM3
DRAWING NUMBER:	


**A-3** 

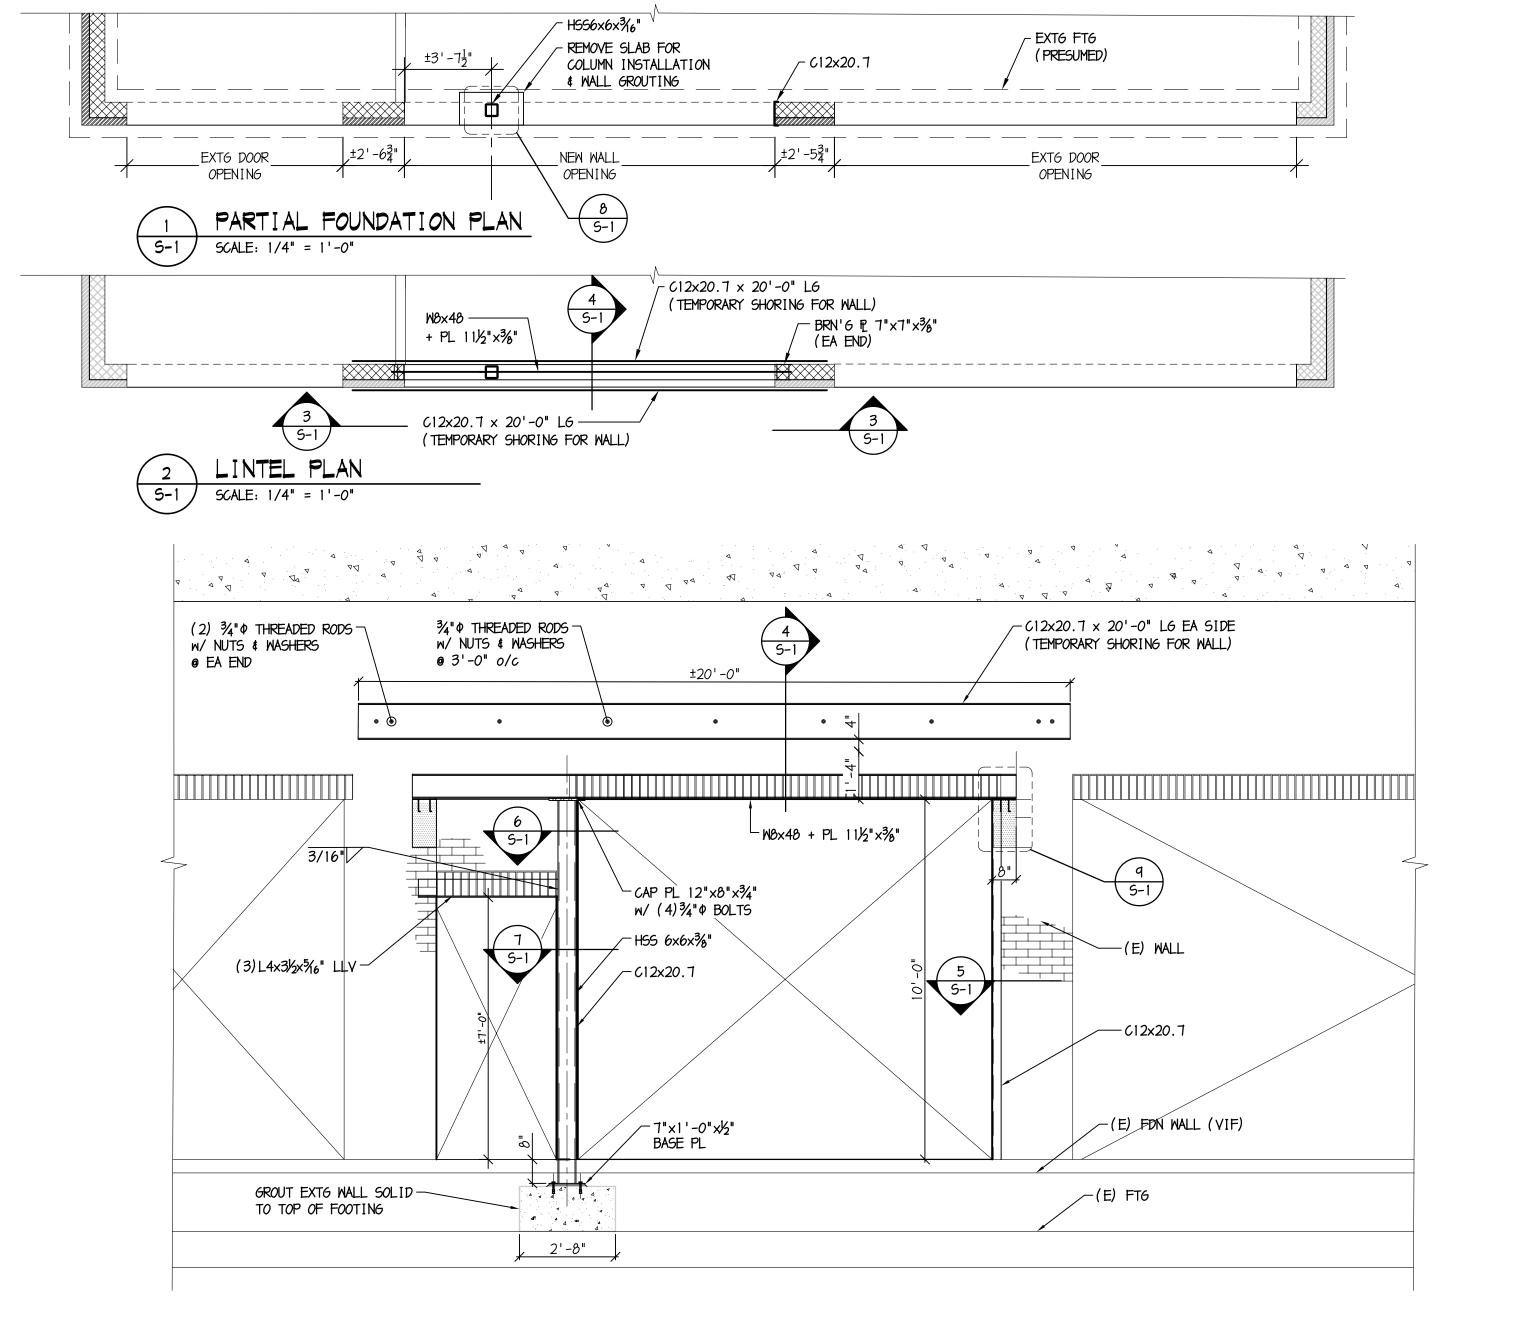


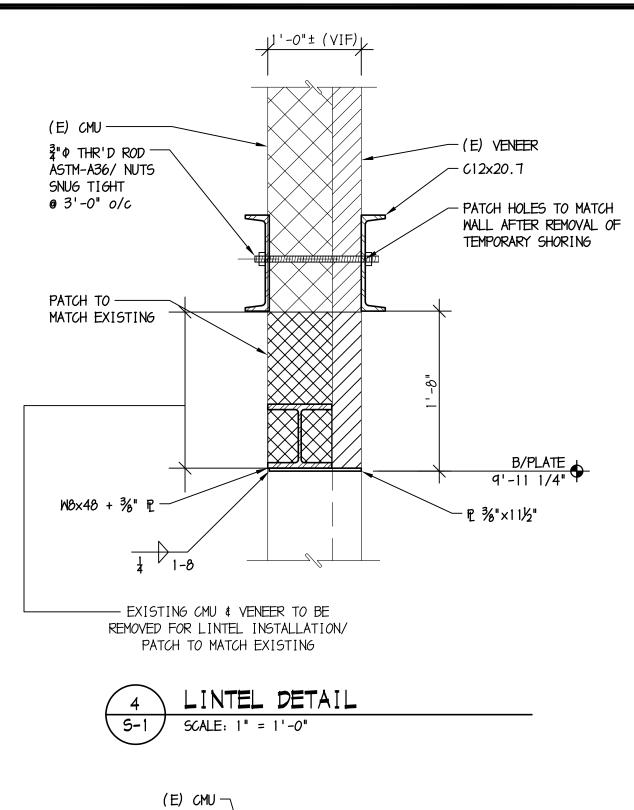


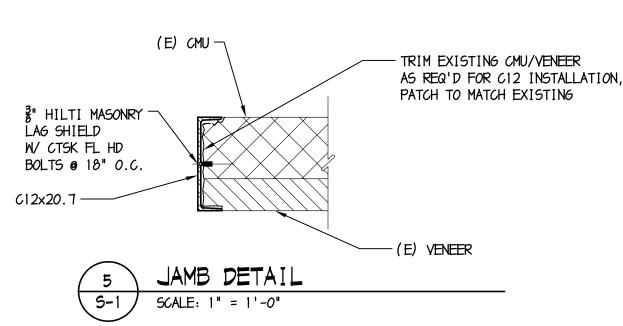


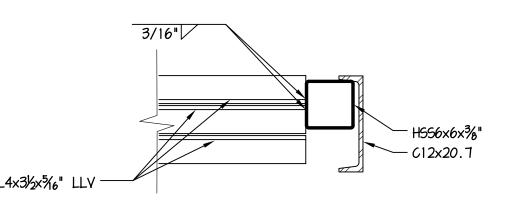

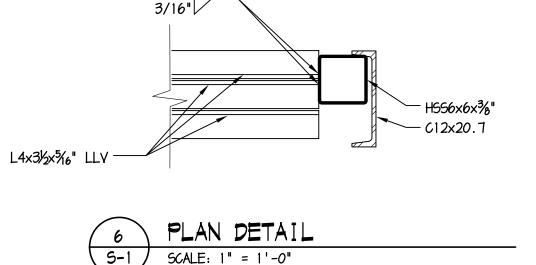

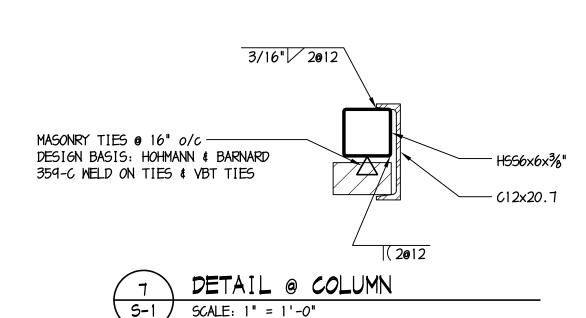

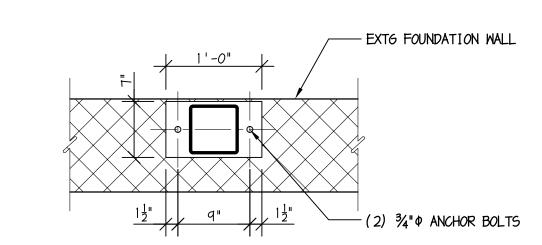

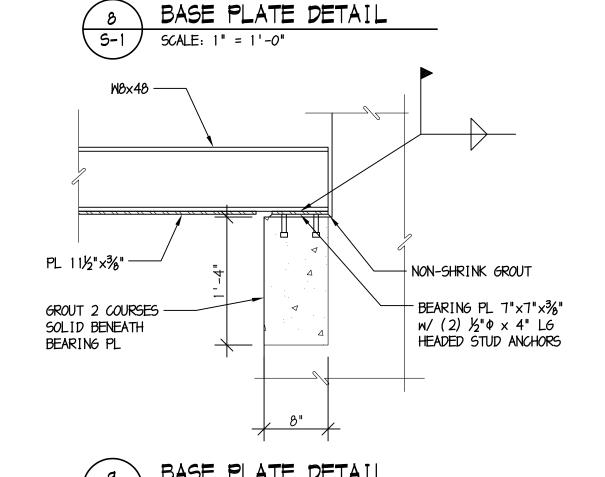

BACH Associates, PC **ENGINEERS • ARCHITECTS • PLANNERS** 

304 White Horse Pike Haddon Heights, New Jersey 08035 Tel: 856-546-8611 Fax: 856-546-8612

www.BachDesignGroup.com

STEVEN M. BACH, PE, RA, PP, CMI NJ PROFESSIONAL ENGINEER No. GE 41507

NJ REGISTERED ARCHITECT No. AI 14872 NJ PROFESSIONAL PLANNER No. LI 05557

ALL DIMENSIONS MUST BE VERIFIED BY CONTRACTOR AND OWNER MUST BE NOTIFIED OF ANY DISCREPANCIES BEFORE PROCEEDING WITH THE WORK.

SODLYNNE
R 39
ING FIRE HOUS
DEPARTMENT
O. NO. 1

BOROUGH O
CDBG
SENOVATION OF I
WOODLYNNE I
STATION

RENOV,

OF SERVICE IN RESPECT OF THE PROJECT. THEY ARE NOT INTENDED OR REPRESENTED TO BE SUITABLE FOR REUSE BY OWNER OR OTHERS ON EXTENSIONS OF THE PROJECT OR ON ANY OTHER PROJECT. ANY REUSE WITHOUT WRITTEN VERIFICATION OR ADAPTATION BY BACH ASSOCIATES, PC FOR THE SPECIFIC PURPOSE INTENDED WILL BE AT OWNERS SOLE RISK AND WITHOUT LIABILITY OR LEGAL EXPOSURE TO BACH ASSOCIATES, PC, AND OWNER SHALL INDEMNIFY AND HOLD HARMLESS BACH ASSOCIATES, PC FROM ALL CLAIMS, DAMAGES, LOSSES AND EXPENSES ARISING OUT OF OR RESULTING THEREFROM. REVISIONS

DESCRIPTION

FLOOR PLAN **ELEVATION, & DETAILS** 

DESIGNED BY: H12891-20 DRAWN BY: 2-8-21 CHECKED BY: AS SHOWN



- BEFORE PROCEEDING WITH ANY WORK WITHIN THE EXISTING FACILITY, THE CONTRACTOR SHALL FAMILIARIZE HIMSELF WITH THE EXISTING STRUCTURAL AND OTHER CONDITIONS. THE CONTRACTOR SHALL BE RESPONSIBLE TO PROVIDE ALL NECESSARY BRACING, SHORING AND OTHER SAFEGUARDS TO MAINTAIN ALL PARTS OF THE EXISTING WORK IN A SAFE CONDITION DURING THE PROCESS OF DEMOLITION AND CONSTRUCTION, AND TO PROTECT FROM DAMAGE THOSE PORTIONS
- OF THE EXISTING WORK WHICH ARE TO REMAIN. 2. THE CONTRACTOR SHALL FIELD VERIFY THE DIMENSIONS, ELEVATIONS, AND CONDITIONS NECESSARY FOR THE PROPER CONSTRUCTION AND ALIGNMENT OF THE NEW PORTIONS OF THE WORK. THE CONTRACTOR SHALL MAKE ALL MEASUREMENTS NECESSARY FOR FABRICATION AND ERECTION OF STRUCTURAL MEMBERS. ANY DISCREPANCY SHALL BE IMMEDIATELY BROUGHT TO THE ATTENTION OF THE
- ENGINEER. INFORMATION OBTAINED REGARDING EXISTING BUILDING WAS OBTAINED FROM LIMITED VISUAL FIELD SURVEYS AND MAY NOT ACCURATELY REFLECT ALL CONDITIONS.

## CONCRETE MASONRY

FRONT WALL ELEVATION

WITH THE AFFECTED PORTION OF THE WORK.

STRUCTURAL CONSTRUCTION DOCUMENTS SHALL BE USED WITH ARCHITECTURAL,

DEPRESSIONS, ETC., NOT INDICATED ON THE STRUCTURAL DOCUMENTS. ALL

2. THE STRUCTURE IS DESIGNED TO BE SELF SUPPORTING AFTER THE BUILDING IS

PROCEDURES AND SEQUENCE TO ENSURE STABILITY AND SAFETY DURING

3. SECTIONS AND DETAILS SHOWN ON ANY STRUCTURAL DOCUMENTS SHALL BE

5. IN THE ABSENCE OF SPECIFIC INSTRUCTIONS TO THE CONTRARY IN THE

INCLUDING THE FEDERAL DEPARTMENT OF LABOR OSHA.

OF STANDARD PRACTICE SHALL GOVERN.

DIMENSIONS AND CONDITIONS, EXISTING AND NEW, SHALL BE FIELD VERIFIED.

COMPLETE. IT IS THE CONTRACTOR'S RESPONSIBILITY TO DETERMINE ERECTION

CONSIDERED TYPICAL FOR SIMILAR CONDITIONS THAT DO NOT HAVE A SPECIFIC

SECTION INDICATED, AND SHALL BE PROVIDED AT NO ADDITIONAL COST TO THE

CONTRACT DOCUMENTS, THE TRADE PRACTICES THAT ARE DEFINED IN ANY CODE

4. APPLICABLE FEDERAL, STATE AND MUNICIPAL REGULATIONS SHALL BE FOLLOWED,

THE ENGINEER SHALL BE NOTIFIED OF DISCREPANCIES PRIOR TO PROCEEDING

DOCUMENTS. COORDINATE WITH THESE DOCUMENTS FOR LOCATIONS AND

DIMENSIONS OF OPENINGS, CHASES, INSERTS, REGLETS, SLEEVES,

SCALE: 3/8" = 1'-0"

CONSTRUCTION.

S-1

- CONCRETE MASONRY CONSTRUCTION SHALL CONFORM TO "BUILDING CODE REQUIREMENTS FOR MASONRY STRUCTURES", TMS 402-16, AND "SPECIFICATIONS FOR MASONRY STRUCTURES", TMS 602-16.
- MINIMUM COMPRESSIVE STRENGTH OF CONCRETE MASONRY, F'M, SHALL BE 1500 PSI. (MIN NET AREA COMPRESSIVE STRENGTH OF UNIT = 1900 PSI.)
- CONCRETE MASONRY SHALL CONFORM TO ASTM C90. GROUT SHALL CONFORM TO ASTM C476, AND SHALL HAVE A MINIMUM COMPRESSIVE STRENGTH OF 3000 PSI. PROVIDE FINE AND COARSE GROUTS APPROPRIATE FOR SIZE OF VOID BEING FILLED. GROUT SHALL HAVE A MINIMUM SLUMP OF 8 INCHES PROVIDED BY SUFFICIENT WATER CONTENT. WATER-REDUCING ADMIXTURES ARE NOT PERMITTED.
- MORTAR SHALL CONFORM TO ASTM C270, TYPE S, PCL OR MORTAR CEMENT. MASONRY CEMENT NOT PERMITTED.
- REINFORCED VOIDS, AND NON-REINFORCED VOIDS SPECIFIED TO BE GROUTED, IN CONCRETE MASONRY SHALL BE FILLED SOLID WITH GROUT IN 5 FT. MAXIMUM LIFTS. STOP POURS 1-1/2 INCHES BELOW THE BED JOINT TO FORM A KEY AT POUR JOINTS.
- CONCRETE MASONRY SHALL BE LAID IN RUNNING BOND, UNO. LOAD BEARING CMU SHALL HAVE FULL MORTAR BED JOINTS.

### STRUCTURAL STEEL

- STRUCTURAL STEEL FABRICATION, ERECTION AND CONNECTION DESIGN SHALL CONFORM TO AISC'S "SPECIFICATION FOR STRUCTURAL STEEL BUILDINGS, 13TH
- STRUCTURAL STEEL WE SHAPES ASTM 992 ASTM 36, UNO OTHER STRUCTURAL STEEL SHAPES STEEL BARS, ANGLES AND PLATES ASTM A36, UNO SQUARE AND RECTANGULAR TUBING ASTM A500, GRADE C

STRUCTURAL STEEL SHALL CONFORM TO THE FOLLOWING DESIGNATIONS

- BOLTS SHALL BE MINIMUM 3/4 IN. DIA. AND SHALL CONFORM TO THE FOLLOWING DESIGNATIONS, UNO: HIGH STRENGTH BOLTS ASTM A325
- ASTM F1554, GRADE 36 ANCHOR BOLTS 4. BOLTED CONNECTIONS SHALL CONFORM TO RCSC'S SPECIFICATIONS FOR

STRUCTURAL JOINTS USING ASTM A325 OR A490 BOLTS.

- WELDING, WELDING ELECTRODES, AND FLUXES SHALL CONFORM TO AWS D1.1-04 "STRUCTURAL WELDING CODE - STEEL." ELECTRODES SHALL HAVE A MINIMUM TENSILE STRENGTH OF 70 KSI.
- GROUT UNDER STEEL COLUMN OR POST BASE PLATES SHALL BE NONMETALLIC, SHRINKAGE-RESISTANT GROUT CONFORMING TO ASTM C827 HAVING A MINIMUM DESIGN COMPRESSIVE STRENGTH OF 5000 PSI. GROUT UNDER STEEL BEAM BEARING PLATES SHALL HAVE A MINIMUM DESIGN COMPRESSIVE STRENGTH OF 3000 PSI, AND SHALL CONFORM TO ASTM C476.
- HIGH STRENGTH BOLTED CONNECTIONS SHALL BE TIGHTENED TO THE SNUG-TIGHT CONDITION, UNO.
- PROVIDE COLUMN CAP PLATE AS FOLLOWS, UNO: FOR BEAM BEARING: 3/4" THICK, MIN.
  - PROVIDE COLUMN CAP PLATES AT ALL SQUARE, RECTANGULAR AND ROUND HSS
- 9. ALL STEEL SHALL BE HOT-DIPPED GALVANIZED AND PAINTED. FIELD WELDS SHALL BE TOUCHED-UP WITH 2 COATS OF ZINC-RICH PAINT



TWO WHITE HORSE PIKE HADDON HEIGHTS, NJ 08035 (856) 310-1491 fax: (856) 310-1829 NJ CERT. OF AUTHORIZATION #24GA28010400

Brian D. McGlade, PE New Jersey PE #34227