101 VERA KING FARRIG DR. ATLANTIC COUNTY

APPLICABLE CODES AND STANDARDS

INTERNATIONAL BUILDING CODE / 2018 (NEW JERSEY EDITION) INTERNATIONAL RESIDENTIAL CODE / 2018 (NEW JERSEY EDITION)

NEW JERSEY REHABILITATION SUBCODE 5:23-6

INTERNATIONAL MECHANICAL CODE / 2018 INTERNATIONAL FUEL GAS CODE / 2018 ASHRAE 90.1 - 2016 (COMMERCIAL)

NATIONAL STANDARD PLUMBING CODE / 2018

NATIONAL ELECTRIC CODE / 2017

ANSI A117.1-2009

SUBCODES AND AMENDMENTS (N.J. REHAB SUB CODE, SUBCHAPTER 6)

UNIFORM CONSTRUCTION CODE STATE OF NEW JERSEY, LATEST EDITION AND ALL OF ITS

INTERNATIONAL ENERGY CONSERVATION CODE / 2018 (NEW JERSEY EDITION) (RESIDENTIAL)

WFCM (WOOD FRAMED CONSTRUCTION) HIGH WIND AREAS FOR ONE & TWO FAMILY DWELLINGS

PROPOSED RENOVATIONS TO: STOCKTON UNIVERSITY - TOWNSEND RESIDENTIAL LIFE CENTER

GALLOWAY NEW JERSEY

PLAN REVIEW DATA

STANDARD ABBREVIATIONS

| | ABOVE FINISH FLOOR ACOUSTICAL CEILING TILE AIR CONDITIONING ALTERNATE ALUMINUM APPROVED AT |
|----------------------|---|
| | BLOCK BLOCKING BOARD BUILDING |
| | CARPET CEILING CENTERLINE CERAMIC CERAMIC TILE COATS COLD WATER COLUMN CONCRETE CONCRETE CONCRETE MASONRY UNIT CONTINUOUS/CONTINUE CONTRACTOR CONTROL JOINT CLEAN OUT |
| | DEAD LOAD DEMOLISH, DEMOLITION DIAMETER DIFFUSER DIMENSION DOWN DITTO |
| | EQUAL EQUIPMENT EXISTING EXTERIOR |
| | FLOOR CLEAN OUT FEET, FOOT FINISH FINISH FLOOR NOTE: THIS LIST REPRESENT |
| O CHANGE | SYMBOL KEY |
| EXISTING - NO CHANGE | X-X DETA SHEET NU |
| | SECT. NUM |
| | - SHEET NU - EXT. ELEV |
| | |
| | SHEET NU |
| | XX X-X XX INTE |
| | |

NOTES

- I. DO NOT SCALE DRAWINGS

- CODE, LATEST EDITION.
- EXPENSE.
- BUILDING DURING CONSTRUCTION.
- RUBBLE FROM THE SITE.
- SURROUNDING CONDITIONS.
- DRAWINGS.

| OCCUPANCY CLASSIFICATION USE GROUP B - EXISTING - NO CHANGE OCCUPANT LOAD EXISTING - NO CHANGE CONSTRUCTION CLASSIFICATION PER TABLE (604.3 & 604.4) SECTION (606.2) TYPE 2B - EXISTING - NO CHANGE ALLOWANCE AREA 23,000 SQ. FT EXISTING - NO CHANGE ALLOWANCE HEIGHT 56'-0" / 3 STORIES - EXISTING - NO CHANGE PER TABLE (601) SECTION (602) FIRE RESISTANCE RATINGS PER TABLE (601) SECTION (602) FIRE RESISTANCE RATINGS | | | |
|--|--|--|--|
| USE GROUP | B - EXISTING - NO CHANGE | | |
| OCCUPANT LOAD | EXISTING - NO CHANGE | | |
| CONSTRUCTION CLASS | IFICATION | | |
| PER TABLE (504.3 & 504.4) SECTION (506.2 |) | | |
| TYPE | 2B - EXISTING - NO CHANGE | | |
| ALLOWANCE AREA | 23,000 SQ. FT EXISTING - NO CHANGE | | |
| ALLOWANCE HEIGHT | ALLOWANCE HEIGHT 55'-0" / 3 STORIES - EXISTING - NO CHANGE | | |
| BUILDING ELEMENT | FIRE RESISTANCE RATINGS | | |
| PER TABLE (601) SECTION (602) | | | |
| • STRUCTURAL FRAME (3) (INCLUDING COLUMNS, GIRDERS, " | (RUSSES) | | |
| • BEARING WALLS EXTERIOR (†) INTERIOR | 0 HOURS 0 HOURS | | |
| • NON BEARING WALLS & PARTITIONS (EXTERIOR | (TABLE 602) 0 HOURS | | |

| • EXIT ACCESS CORRIDORS (1020.1) |
|----------------------------------|
| |

(INCLUDING SUPPORTING BEAMS AND JOISTS)

(INCLUDING SUPPORTING BEAMS AND JOISTS)

BUILDING CHARACTERISTICS

INTERIOR (e)

FLOOR CONSTRUCTION

ROOF CONSTRUCTION

• FIRE WALLS (706.4)

• SHAFTS (713.4)

• FIRE BARRIERS (707.3.10)

• FIRE PARTITIONS (708.3)

| NUMBER OF STORIES | EXISTING - NO CHANGE |
|---------------------|----------------------|
| HEIGHT OF STRUCTURE | EXISTING - NO CHANGE |
| AREA OF RENOVATION | +/- 1,587 SQ. FT. |
| | |

0 HOURS

0 HOURS

0 HOURS

3 HOURS

2 HOURS

I HOUR

I HOUR

I HOUR

BUILDING DESIGN LOADS

PER CHAPTER 16

| FLOORS | IOO PSF LL (LOBBIES & CORRIDORS) 50 PSF LL (OFFICES) | TING ANGE |
|-------------------|---|--------------|
| ROOF | 20 PSF LL MIN | CHA CHA |
| GROUND SNOW LOADS | 30 PSF | |
| BASIC WIND SPEED | 130 MPH | Z |

AUTOMATIC SPRINKLER SYSTEMS

PER SECTION 003

THE AREA OF WORK IS NOT EQUIPPED WITH AN EXISTING AUTOMATIC SPRINKLER SYSTEM. NO AUTOMATIC SPRINKLER SYSTEM WORK IS ANTICIPATED AS PART OF THIS PROJECT.

INTERIOR FINISH NOTES

INT. FINISHES SHALL COMPLY W/ SECTION (803.11) & SHALL HAVE A FLAME SPREAD RATING AS OUTLINED BELOW:

- REQ^ID VERT. EXITS AND PASSAGEWAYS EXIT ACCESS CORRIDORS ROOMS AND ENCLOSED SPACES
 - ALL INTERIOR FINISHES AT BATHROOMS SHALL BE MOISTURE RESISTANT & WASHABLE
- A FLAME SPREAD 0-25
- B FLAME SPREAD 26-75 C FLAME SPREAD 76-200
- SMOKE DEVELOPES 0-450 SMOKE DEVELOPES 0-450

SMOKE DEVELOPES 0-450

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| | A.F.F. | FIRE EXTINGUISHER | F.E. | MASONRY | 144.0 | SAFETY | SFTY. |
|----|----------------|--------------------------|-----------------|------------------------------|--------------|---------------------------|--------------|
| = | A.C.T. | FLOOR | | MASONRY OPENING | MAS. | SCHEDULE | SCHED. |
| - | A.C. | FLOOR FLOOR DRAIN | FL./FLR. | MASONRT OF ENING MAXIMUM | M. <i>O.</i> | SECTION | SECT. |
| | | | F.D. | | MAX. | | |
| | ALT. | FLOOR SINK | F.S. | MECHANICAL | MECH. | SOLID CORE | S.C. |
| | ALUM. | FLUORESCENT | FLUOR. | MEMBRANE | MEMB. | SHEET | SHT. |
| | APPD./APPV'D | FOOTING | FTG. | MINIMUM/MINUTE | MIN. | SIMILAR | SIM. |
| | @ | FURNISH | FURN. | MISCELLANEOUS | MISC. | SPECIFICATIONS | SPEC. |
| | | FURRING | FURR. | | | SQUARE | SQ. |
| | BLK. | | | NORTH | N | SQUARE FOOT | S.F. |
| | BLKG. | GAUGE | GA. | NOMINAL | NOM. | STAINLESS STEEL | 5.5. |
| | BD. | GALVANIZED | GALV. | NOT IN CONTRACT | N.I.C. | STEEL | STL. |
| | BLDG. | GENERAL, GENERATOR | GEN. | NOT TO SCALE | N.T.S. | STORAGE | STOR. |
| | | GENERAL CONTRACTOR(OR) | G.C. | NUMBER | N <i>O.</i> | STORAGE CLOSET | ST. CL. |
| | CPT. | GLASS, GLAZING | GL. | | | | |
| | CLG. | GRADE | GR. | OFFICE | OFF. | TOTAL LOAD | T.L. |
| | Ę | GYPSUM WALLBOARD | G.W.B./GYP. BD. | ON CENTER | 0.C. | TOP OF DECK | T.O.D. |
| | CER. | GROUND FAULT INTERRUPTER | G.F.I. | OPENING | OPNG. | TOP OF FOOTING | T.O.F. |
| | C.T. | | | OUTSIDE DIAMETER (DIMENSION) | 0.D. | TOP OF MASONRY | Т.О.М. |
| | CTS. | HARDWARE | HDW./HDW'R. | OVERHEAD | 0.H. | TOP OF PIER | T.O.P. |
| | C.W. | HARDWOOD | HWD. | | | TOP OF SLAB | T.O.S. |
| | COL. | HEATING/VENTILATING/AIR | | PAINT | PT. | TOP OF STEEL | T.O.STL. |
| | CONC. | CONDITIONING | | PAINTED | PTD. | TOP OF WALL | T.O.W. |
| IT | C.M.U. | HEIGHT | H.V.A.C. | PARTITION | PART'N. | TYPICAL | TYP. |
| •• | CONT. | HIGH POINT | HT. | PARALLEL STRAND LUMBER | P.S.L. | TREAD | T |
| | CONTR. | | H.P. | PLASTER | | | • |
| | C.J. | HOLLOW CORE | H.C. | | PLAS. | UNDERWRITERS LABORATORIES | U.L. |
| | C.O. | HOLLOW METAL | H.M. | PLASTIC LAMINATE | P.LAM. | UNFINISHED | UNF. |
| | 0.0. | HOLLOW METAL FRAME | H.M.F | PLATE | PL. | UNIFORM BUILDING CODE | U.B.C. |
| | | HOSE BIB | H.B. | PLUMBING | PLBG. | | 0.0.0. |
| | D.L. | HOT WATER | H.W. | POLYVINYL CHLORIDE | P.V.C. | VINYL COMPOSITION TILE | V.C.T. |
| | DEMO. | HOUR | HR. | POUNDS PER CUBIC FOOT | P.C.F. | | |
| | DIA./Ø | | | POUNDS PER LINEAL FOOT | P.L.F. | VINYL WALL COVERING | V.W.C. |
| | DIFF. | INGULATION | INSUL. | POUNDS PER SQUARE FOOT | P.S.F. | VERTICAL | VERT. |
| | DIM. | INTERIOR | INT. | POUNDS PER SQUARE INCH | P.S.I. | VESTIBULE | VEST. |
| | DN. | INVERT | INV. | PREFABRICATED | PREFAB. | VERIFY IN FIELD | V.I.F. |
| | "do" | | | | | WATER CLOSET | W. <i>C.</i> |
| | | JOINT | JT. | QUARRY TILE | Q.T. | | |
| | EQ. | | | | | WATERPROOF, WEATHERPROOF | W.P. |
| | EQUIP. | LAMINATE(D) | LAM. | RADIUS | RAD. | WELDED WIRE FABRIC | W.W.F. |
| | EXIST./EXIST'G | LAMINATED VENEER LUMBER | L.V.L. | REFERENCE | REF. | WELDED WIRE MESH | W.W.M. |
| | EXT. | LAVATORY | LAV. | REINFORCE, REINFORCING | REINF. | WIRE GLASS | W.GL. |
| | | LIVE LOAD | L.L. | REQUIRED | REQ./REQ'D. | WITH | W/ |
| | F.C.O. | LOUVER | LVR./LOUV. | RISER | R | WITHOUT | W/0 |
| | FT. | | | ROOF DRAIN | R.D. | WOOD | WD. |
| | FIN. | MAINTENANCE/MAINTAIN | MAINT. | ROOF SCUPPER | R.G. | | |
| | F.F. | MANUFACTURER | MFR./MANUF. | ROUGH OPENING | R.O. | | |
| | | | | | | | |

ITS ABBREVIATIONS THAT MAY OR MAY NOT APPEAR IN THESE DOCUMENTS. CONTACT YEZZI ASSOCIATES FOR ANY CLARIFICATIONS REGARDING THE ABBREVIATIONS

| IUMBER | | | | |
|--------------------------|---------------------|-------------------------|--------------|--------------------------|
| TAIL CALLOUT | ROOM NAME 100 | ROOM IDENTIFICATION | × | COLUMN MARK |
| IUMBER | | | | |
| JMBER | - 00 | OR NUMBER | E | EXIST'G ENTITY TO REMAIN |
| CTION CALLOUT | XX XXX | DOOR CALLOUT | \wedge | |
| IUMBER | RC | OM NUMBER | < <u>x</u> > | WALL TYPE KEY |
| V. NUMBER | EX | TERIOR | | |
| TERIOR ELEVATION CALLOUT | EXX | EXTERIOR WINDOW CALLOUT | . — | ELEVATION MARK |
| IUMBER | - WI | NDOW NUMBER | | |
| /. NUMBER | - INT | ERIOR | N | |
| ERIOR ELEVATION CALLOUT | | INTERIOR WINDOW CALLOUT | | NORTH ARROW |
| IUMBER | - WI | NDOW NUMBER | | |
| | | SCOPE OF V | VADY | |
| | | JUUTE UT V | VURN | |

2. FIELD CHECK ALL DIMENSIONS PRIOR TO THE START OF CONSTRUCTION. 3. WHERE THERE MAY BE A CONFLICT BETWEEN THE DRAWINGS AND THE ACTUAL FIELD CONDITIONS THE CONTRACTOR SHALL NOTIFY THE ARCHITECTS WHO WILL MAKE THE NECESSARY REVISIONS. 4. PLANS TO CONFORM WITH THE STRUCTURE REQUIREMENTS OF THE INTERNATIONAL BUILDING

5. ALL EXISTING WORK TO REMAIN MUST BE PROTECTED. ANY SUCH WORK DAMAGED IN THE COURSE OF CONSTRUCTION WILL BE REPAIRED OR REPLACED BY THE CONTRACTOR AT HIS

6. ALL ITEMS TO BE REMOVED AND REUSED THAT ARE DAMAGED AND NOT REUSABLE SHALL BE REPLACED BY THE CONTRACTOR AT HIS OWN EXPENSE. 7. THE CONTRACTOR SHALL MAINTAIN THE THERMAL AND ACOUSTICAL PROPERTIES OF THE

8. AT THE END OF EACH WORKING DAY THE CONTRACTOR SHALL REMOVE ALL CONSTRUCTION

9. ALL ITEMS MARKED ON THE DRAWINGS TO BE REMOVED SHALL ALSO MEAN PATCH TO MATCH

10. ALL TRADES TO COORDINATE THEIR WORK SO THERE WILL BE NO DUPLICATION OF WORK. II. ALL TRADES TO DO THEIR OWN CUTTING AND PATCHING UNLESS OTHERWISE NOTED ON THE

12. THE CONTRACTOR SHALL EXAMINE ALL EXISTING CONDITIONS PRIOR TO BIDDING AND STARTING CONSTRUCTION & TAKE PHOTOGRAPHS OF ALL EXISTING CONDITIONS. ANY ALTERATIONS TO EXISTING STRUCTURE REQUIRED FOR PROPER INSTALLATION OF NEW WORK SHALL BE DONE BY THE CONTRACTOR AT HIS OWN EXPENSE, BUT ONLY AS APPROVED BY THE ARCHITECT. 13. THE GENERAL CONTRACTOR SHOULD EXAMINE THE M.E.P. DRAWINGS TO SEE THE EXTENT OF THE ENGINEERING CHANGES TO BE MADE TO THE BUILDING.

14. THE CONTRACTOR SHALL PROTECT THE EXISTING BUILDING FROM ANY POSSIBLE WATER DAMAGE. ANY REPAIRS AS A RESULT OF DAMAGE WILL BE PAID BY THE CONTRACTOR. 15. ALL EXISTING UTILITIES IN CONFLICT WITH THE WORK SHALL BE TURNED OFF BY THE CONTRACTOR / UTILITY COMPANIES PRIOR TO START OF DEMOLITION / CONSTRUCTION.

FINISHES, RESTROOMS ETC.

SCOPE OF WORK

AT THE GALLOWAY CAMPUS TOWNSEND RESIDENTIAL LIFE CENTER THE UNIVERSITY IS PROPOSING TO RENOVATE THE EXISTING MAIN ENTRANCES, KITCHEN, RESTROOMS, AND CONVERSION OF EXISTING MEETING ROOM INTO OFFICES.


THE WORK TO BE PERFORMED UNDER THIS PROJECT INCLUDES, BUT IS NOT LIMITED TO; BUILDING - THE REMOVAL AND REPLACEMENT OF THE EXISTING WALLS, CEILINGS, FINISHES. ETC. ALONG WITH THE INSTALLATION OF NEW WALLS, DOORS, FRAMES, CONCRETE SLABS,

ELECTRICAL - THE REMOVAL, RELOCATION, AND/OR MODIFICATION OF EXISTING, AND THE INSTALLATION OF PROPOSED RECEPTACLES, SWITCHES, LIGHTING, ETC. TO SUIT THE NEW LAYOUT.

FIRE - THE REMOVAL, RELOCATION, AND/OR MODIFICATION OF EXISTING, AND THE INSTALLATION OF PROPOSED FIRE ALARM DEVICES, SPRINKLER HEADS, ETC. TO SUIT THE NEW LAYOUT.

MECHANICAL - THE REMOVAL & REPLACEMENT OF EXISTING HVAC UNITS AS INDICATED, ALL WIT THE REMOVAL, RELOCATION, AND MODIFICATION OF EXISTING, AND THE INSTALLATION OF PROPOSED DUCTWORK, DIFFUSERS, THERMOSTATS, ETC. TO SUIT THE NEW LAYOUT.

PLUMBING - THE REMOVAL OF EXISTING PLUMBING FIXTURES. ALONG WITH THE INSTALLATION OF A NEW WATER CLOSET, LAVATORY, SINK, AND RELATED ITEMS. TIED TO EXITING WATER, SANITARY, AND VENT PIPING. THE HEIGHTS OF ALL FIXTURES WILL BE MODIFIED AS REQUIRED TO COMPILE WITH THE CURRENT ADA REQUIREMENTS.

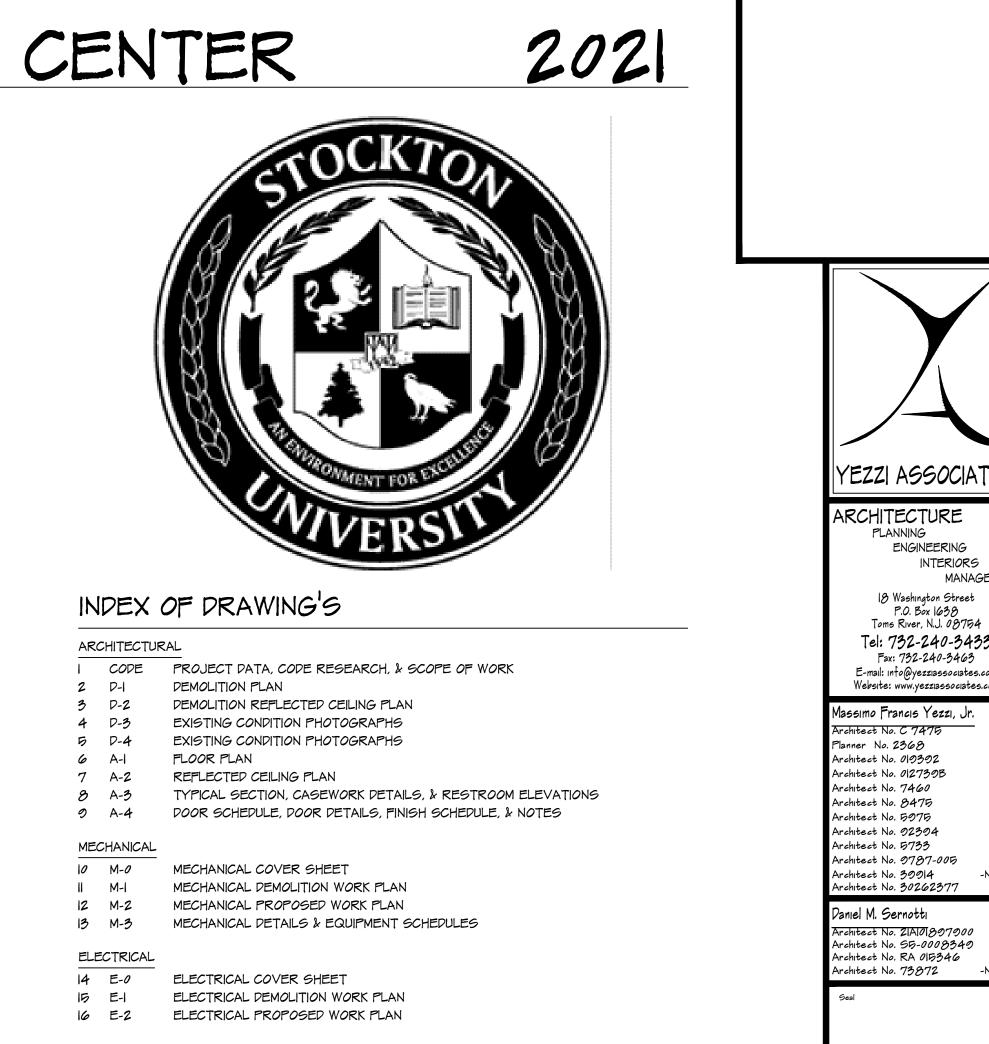

PLUMBING

- 17 P-0 PLUMBING COVER SHEET 18 P-1
- PLUMBING DEMOLITION WORK PLAN 19 P-2 PLUMBING PROPOSED WORK PLAN
- 20 P-3 PLUMBING COMBINATION RISER DIAGRAMS
- PLUMBING DETAIL SHEET

AERIAL PHOTOGRAPH




ALTERNATES

ALTERNATES

ALTERNATE #1 - ADDITIONAL DOOR AND HARDWARE REPLACEMENT:

STATE THE AMOUNT, ON THE BID PROPOSAL FORM, TO BE ADDED TO THE BASE BID IF ALL WORK ASSOCIATED WITH ADDITIONAL DOOR AND HARDWARE REPLACEMENT, AS INDICATED ON THE DRAWINGS, IS ADDED TO THE PROJECTS SCOPE OF WORK.

REFER TO BID PROPOSAL FOR FOR ADDITIONAL INFORMATION.

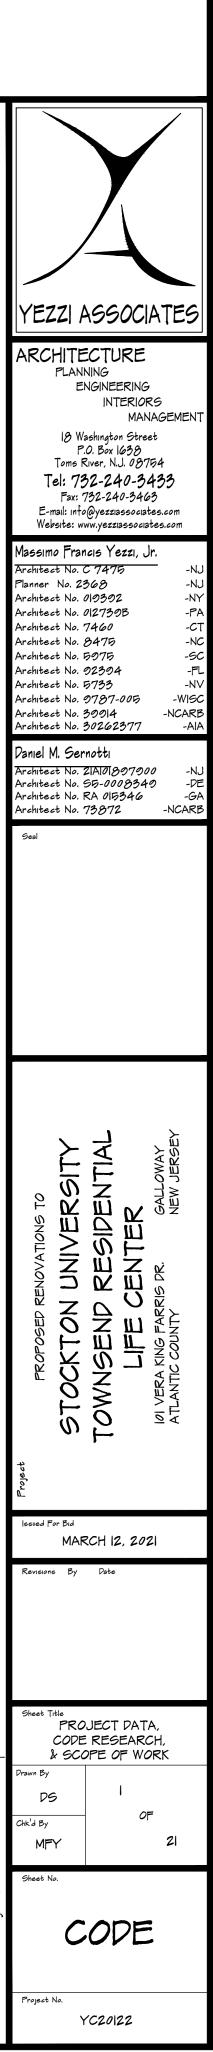

ARAL ECENT

| SYMBOL LE | GEND |
|--------------|--|
| | EXISTING TO REMAIN |
| | EXISTING TO BE REMOVED |
| ····· | NOT IN CONTRACT |
| × | EXISTING PHOTO LOCATION & DIRECTION CALLOUT |
| E | EXISTING STOREFRONT, DOOR & WINDOW TO REMAIN, NO CHANGE |
| | EXISTING POWER RECEPTACLE (TYP.) |
| F | EXISTING FIRE ALARM MANUAL PULL STATION (TYP.) |
| A/V | EXISTING FIRE ALARM AUDIO / VISUAL DEVICE (TYP.) |
| T | EXISTING THERMOSTAT (TYP.) |
| \mathbf{V} | EXISTING DATA RECEPTACLE (TYP.) |
| | EXISTING ELECTRICAL PANEL (TYP.) |
| Т | EXISTING HOSE BID (TYP.) |
| РВ | EXISTING REMOTE ACTUATOR (TYP.) |
| | |

EXISTING O.H. DOOR OPERATOR (TYP.) ${ \llcorner _ _ _ _ _ _ _ _$

NOTE

THE PHOTOGRAPHS AND DEMOLITION PLAN INDICATED ON THIS DRAWING ARE FOR REFERENCE ONLY TO INDICATE THE EXISTING BUILDING CONDITIONS AT THE TIME OF OUR FIELD INSPECTION. ALL DEMOLITION REQUIRED TO SUCCESSFULLY COMPLETE THIS PROJECT SHALL BE INCLUDED IN THE GENERAL CONTRACTORS SCOPE OF WORK.

GENERAL SELECTIVE DEMOLITION NOTES PREPARATION:

- PROVIDE, ERECT, AND MAINTAIN TEMPORARY BARRIERS AT DOORWAYS WITH CODE REQUIRED SECURITY DEVICES.
- NOTIFY OWNER OF WORK WHICH MAY AFFECT THEIR PROPERTY, POTENTIAL NOISE, UTILITY OUTAGE, OR DISRUPTION. COORDINATE
- ALL WORK WITH OWNER. PREVENT MOVEMENT OR SETTLEMENT OF ADJACENT STRUCTURES. PROVIDE BRACING AND SHORING AS REQUIRED.
- ERECT AND MAINTAIN TEMPORARY PARTITIONS TO PREVENT SPREAD OF DUST, ODORS AND NOISE TO PERMIT CONTINUED OWNER OCCUPANCY.

PROTECT EXISTING ITEMS INDICATED TO REMAIN.

- DEMOLITION REQUIREMENTS: CONDUCT DEMOLITION TO MINIMIZE INTERFERENCE TO ADJACENT AREAS.
- CONDUCT OPERATIONS WITH MINIMUM INTERFERENCE TO ADJACENT
- ACCESSES. MAINTAIN PROTECTED EGRESS AND ACCESS AT ALL TIMES. CEASE OPERATIONS IMMEDIATELY WHEN ADJACENT STRUCTURAL COMPONENTS APPEAR TO BE IN DANGER. NOTIFY AUTHORITY HAVING JURISPICTION AND A/E.

SELECTIVE DEMOLITION:


- DEMOLISH AND REMOVE COMPONENTS IN ORDERLY AND CAREFUL MANNER, IN SEQUENCE OUTLINED IN SUBMITTED AND APPROVED SCHEDULE.
- 2. PROTECT EXISTING SUPPORTING STRUCTURAL MEMBERS.
- CLEAN UP: REMOVE DEMOLISHED MATERIALS FROM SITE AS WORK
- PROGRESSES.
- 2. LEAVE AREAS OF WORK IN CLEAN CONDITION. DISPOSE OF ALL DEBRIS IN ACCORDANCE WITH ALL STATE AND MUNICIPAL REQUIREMENTS. PROVIDE LOAD TICKETS WHERE APPLICABLE.


TAGGED DEMOLITION NOTES


-) PORTION OF EXISTING WALL TO BE REMOVED TO ALLOW FOR INSTALLATION OF NEW WORK AS INDICATED ON THE DRAWINGS, PATCH TO MATCH SURROUNDING FINISHES (TYP.)
- (2) EXISTING TOILET PARTITIONS TO BE REMOVED IN THEIR ENTIRETY (TYP.)
- (3) EXISTING TOILET ACCESSORIES & ALL RELATED ITEMS TO BE REMOVED (TYP.)
- (4) EXISTING PLUMBING FIXTURES TO BE REMOVED, REFER TO MEP DRAWINGS FOR ADDITIONAL INFORMATION (TYP.)
- (5) EXISTING COUNTER, BACKSPLASH, CABINETS, & ALL RELATED ITEMS TO BE REMOVED (TYP.)
- (6) EXISTING DOOR & HARDWARE TO BE REMOVED, EXISTING FRAME TO REMAIN, HARDWARE TO BE TURNED OVER TO THE OWNER. ACTUATORS AND CARD READERS TO BE RELOCATED AS INIDCATED
- (TYP.) () EXISTING APPLIANCE & ALL RELATED ITEMS TO BE REMOVED (TYP.)
- $(\boldsymbol{\vartheta})$ EXISTING RAILING TO BE REMOVED (TYP.)
- (9) EXISTING COMPONENTS TO BE REMOVED BY OWNER PRIOR TO CONSTRUCTION (TYP.)
- (10) EXISTING RECEPTACLES / FIRE ALARM DEVICE TO BE REMOVED / RELOCATED, REFER TO ELECTRICAL DRAWINGS FOR ADDITIONAL INFO. (TYP.)
-) EXISTING FLOOR FINISH & BASE MOLDING TO BE REMOVED, EXISTING CONCRETE TO BE PREPPED FOR NEW FLOOR FINISH (TYP.)
- 2) EXISTING WALL FINISH, WALL BOARD, & INSULATION TO BE REMOVED DOWN TO EXISTING STUDS & REPLACED WITH NEW AS INDICATED ON THE DRAWINGS (TYP.)

UPON DEMOLITION OF EXISTING WALL BOARD & INSULATION, THE G.C. IS TO CONTACT THE ARCHITECT & OWNER SO A SITE VISIT CAN BE SCHEDULED TO PERFORM A VISUAL INSPECTION OF ALL EXISTING PLUMBING LINES TO DETERMINE IF ADDITIONAL REPAIRS ARE REQUIRED PRIOR TO CLOSING UP THE WALLS (TYP.)


- 7) EXISTING CONCRETE TO BE REMOVED & REPLACED, TO MATCH EXISTING, TO ALLOW FOR PROPOSED PLUMBING WORK. COORDINATE EXTENT OF WORK WITH PLUMBING DRAWINGS (TYP.)
- (19) EXISTING WALL FINISH, WALL BOARD TO BE REMOVED DOWN TO EXISTING STUDS & REPLACED WITH NEW AS REQUIRED FOR PLUMBING WORK, REFER TO PLUMBING DRAWINGS FOR ADDITIONAL INFORMATION (TYP.)

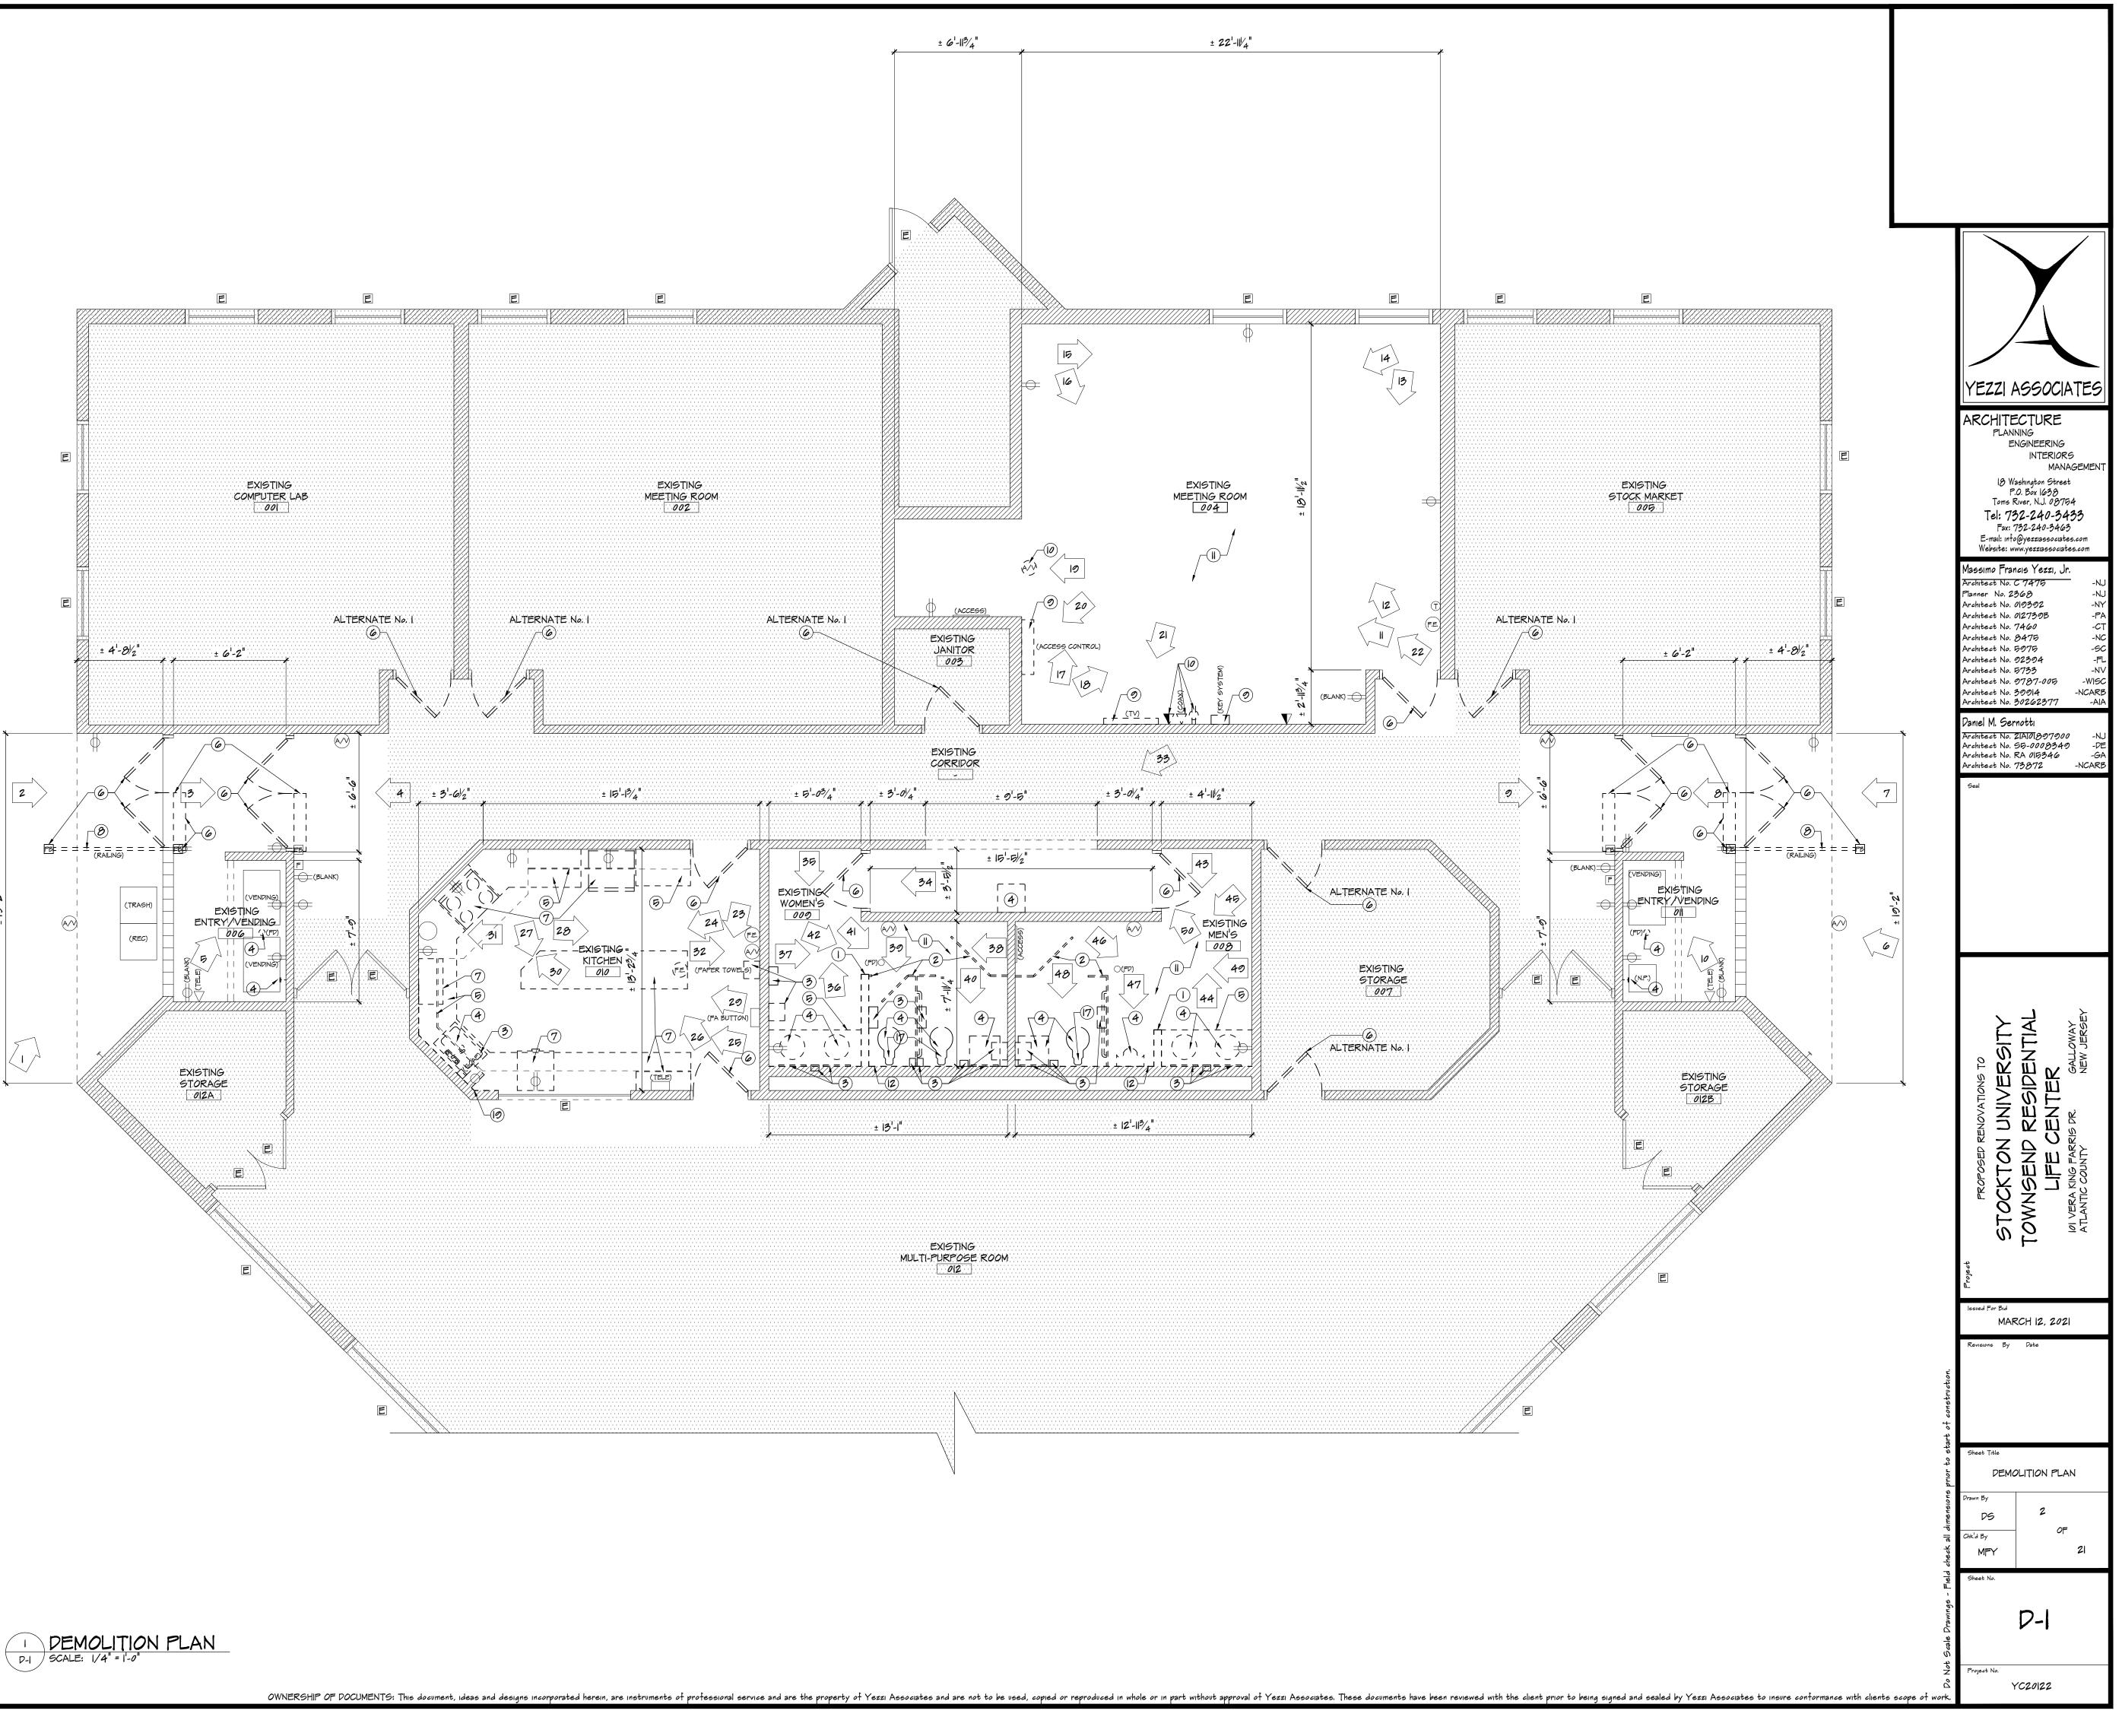


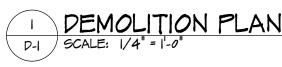

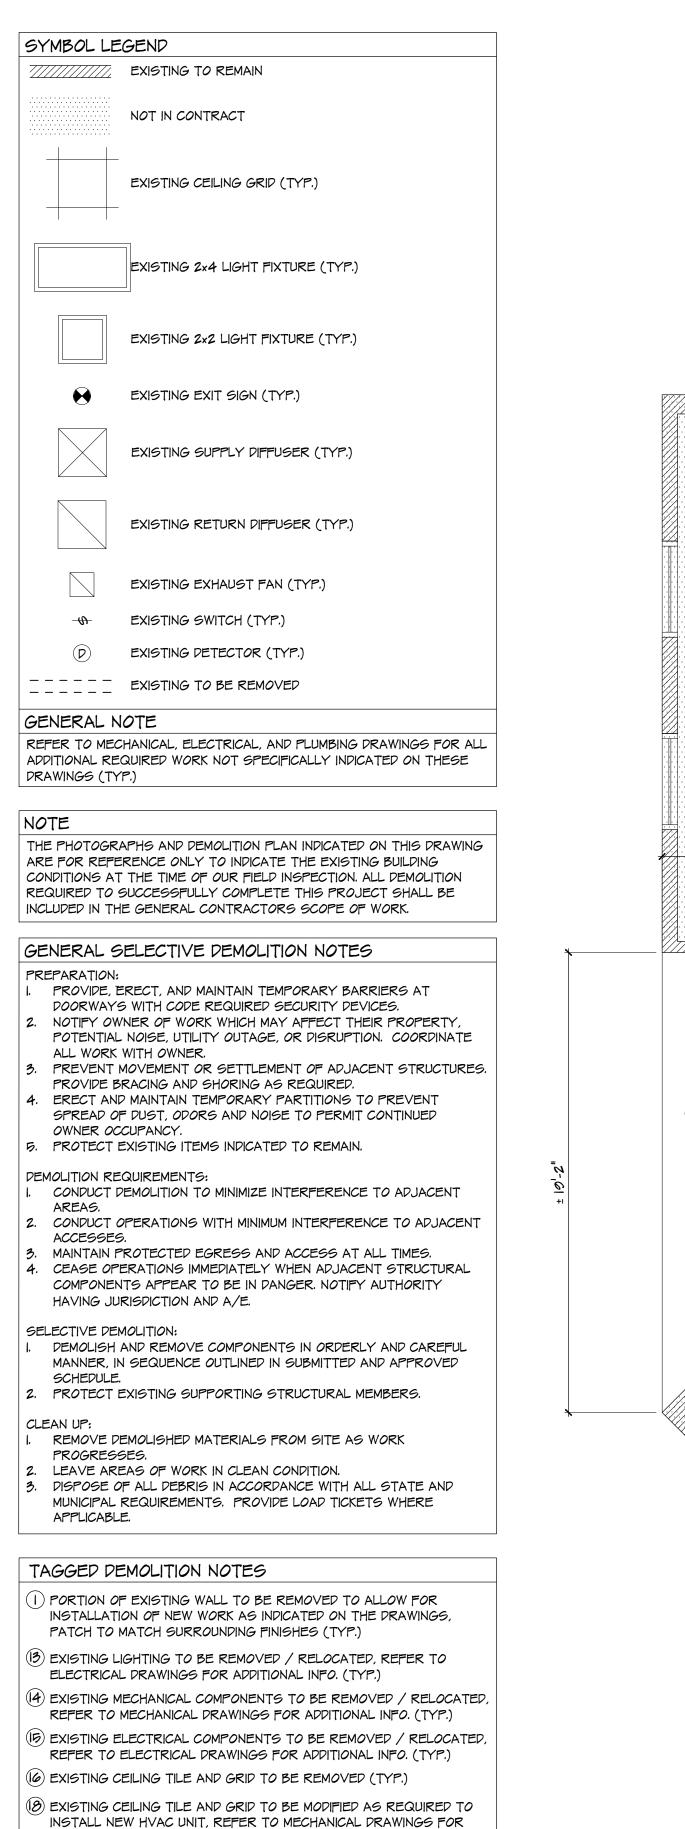

ADDITIONAL INFORMATION (TYP.)

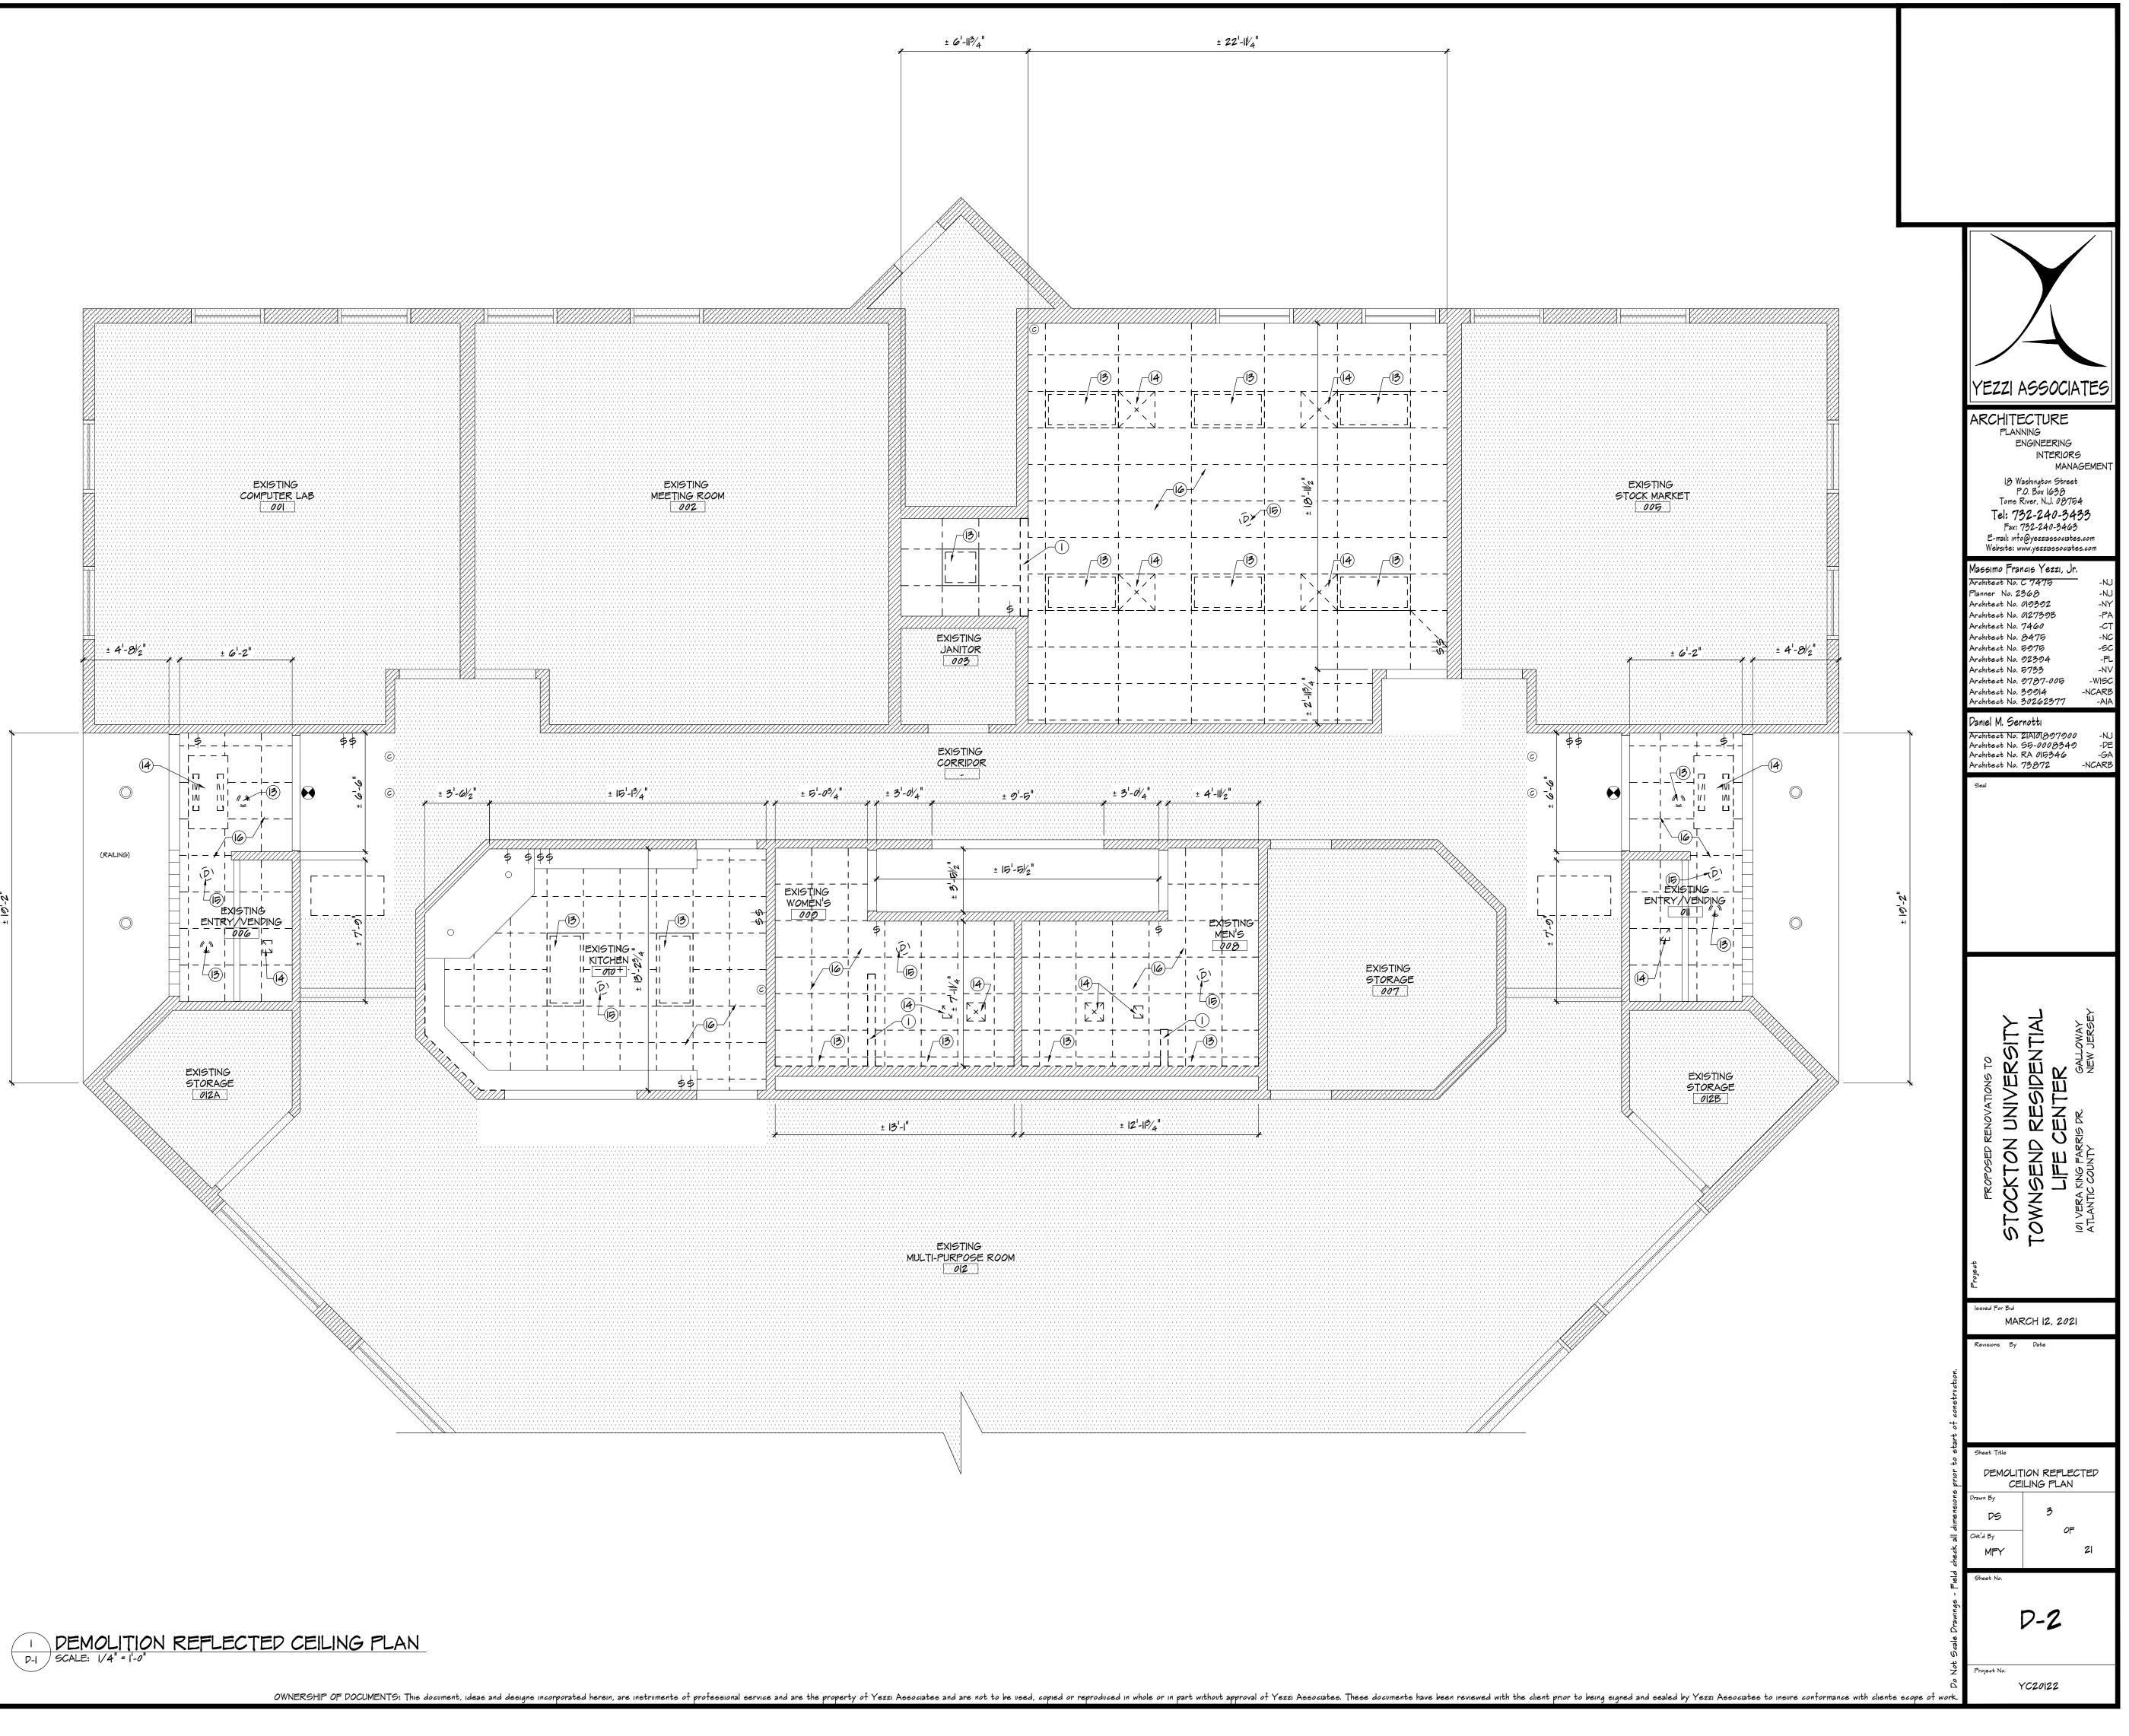


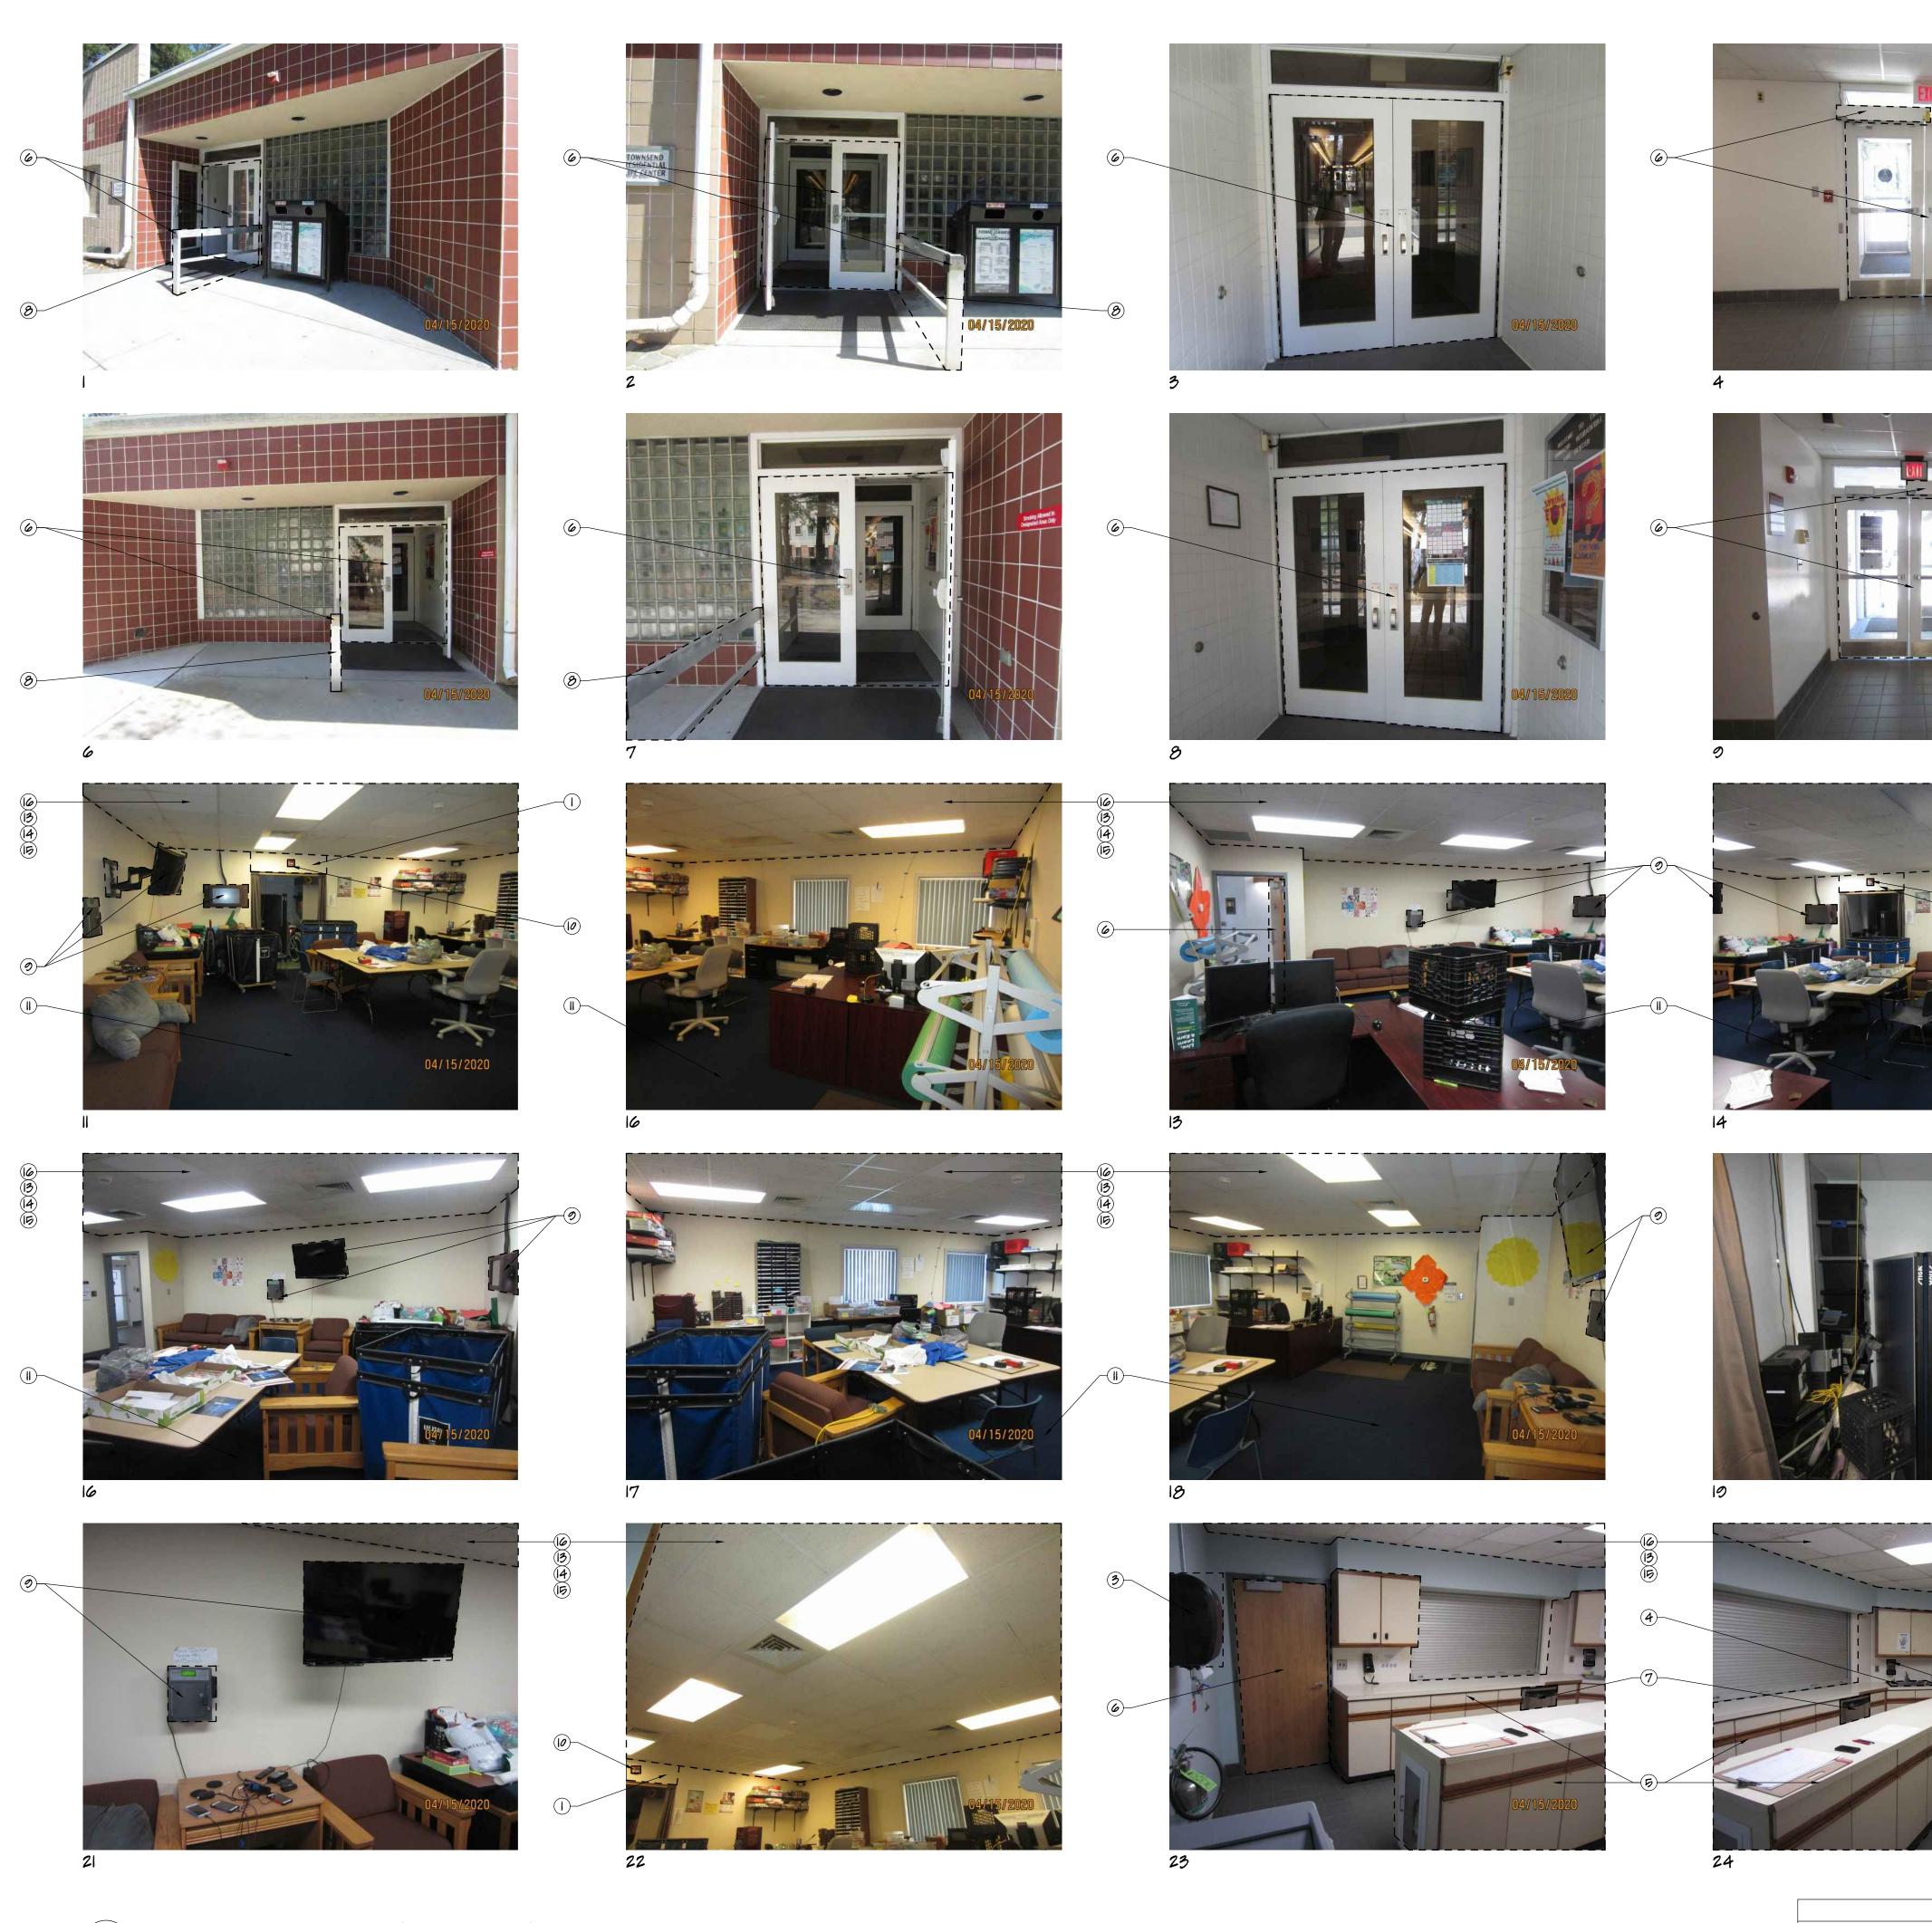

I EXISTING CONDITION PHOTOGRAPHS D-3 SCALE: N.T.S.





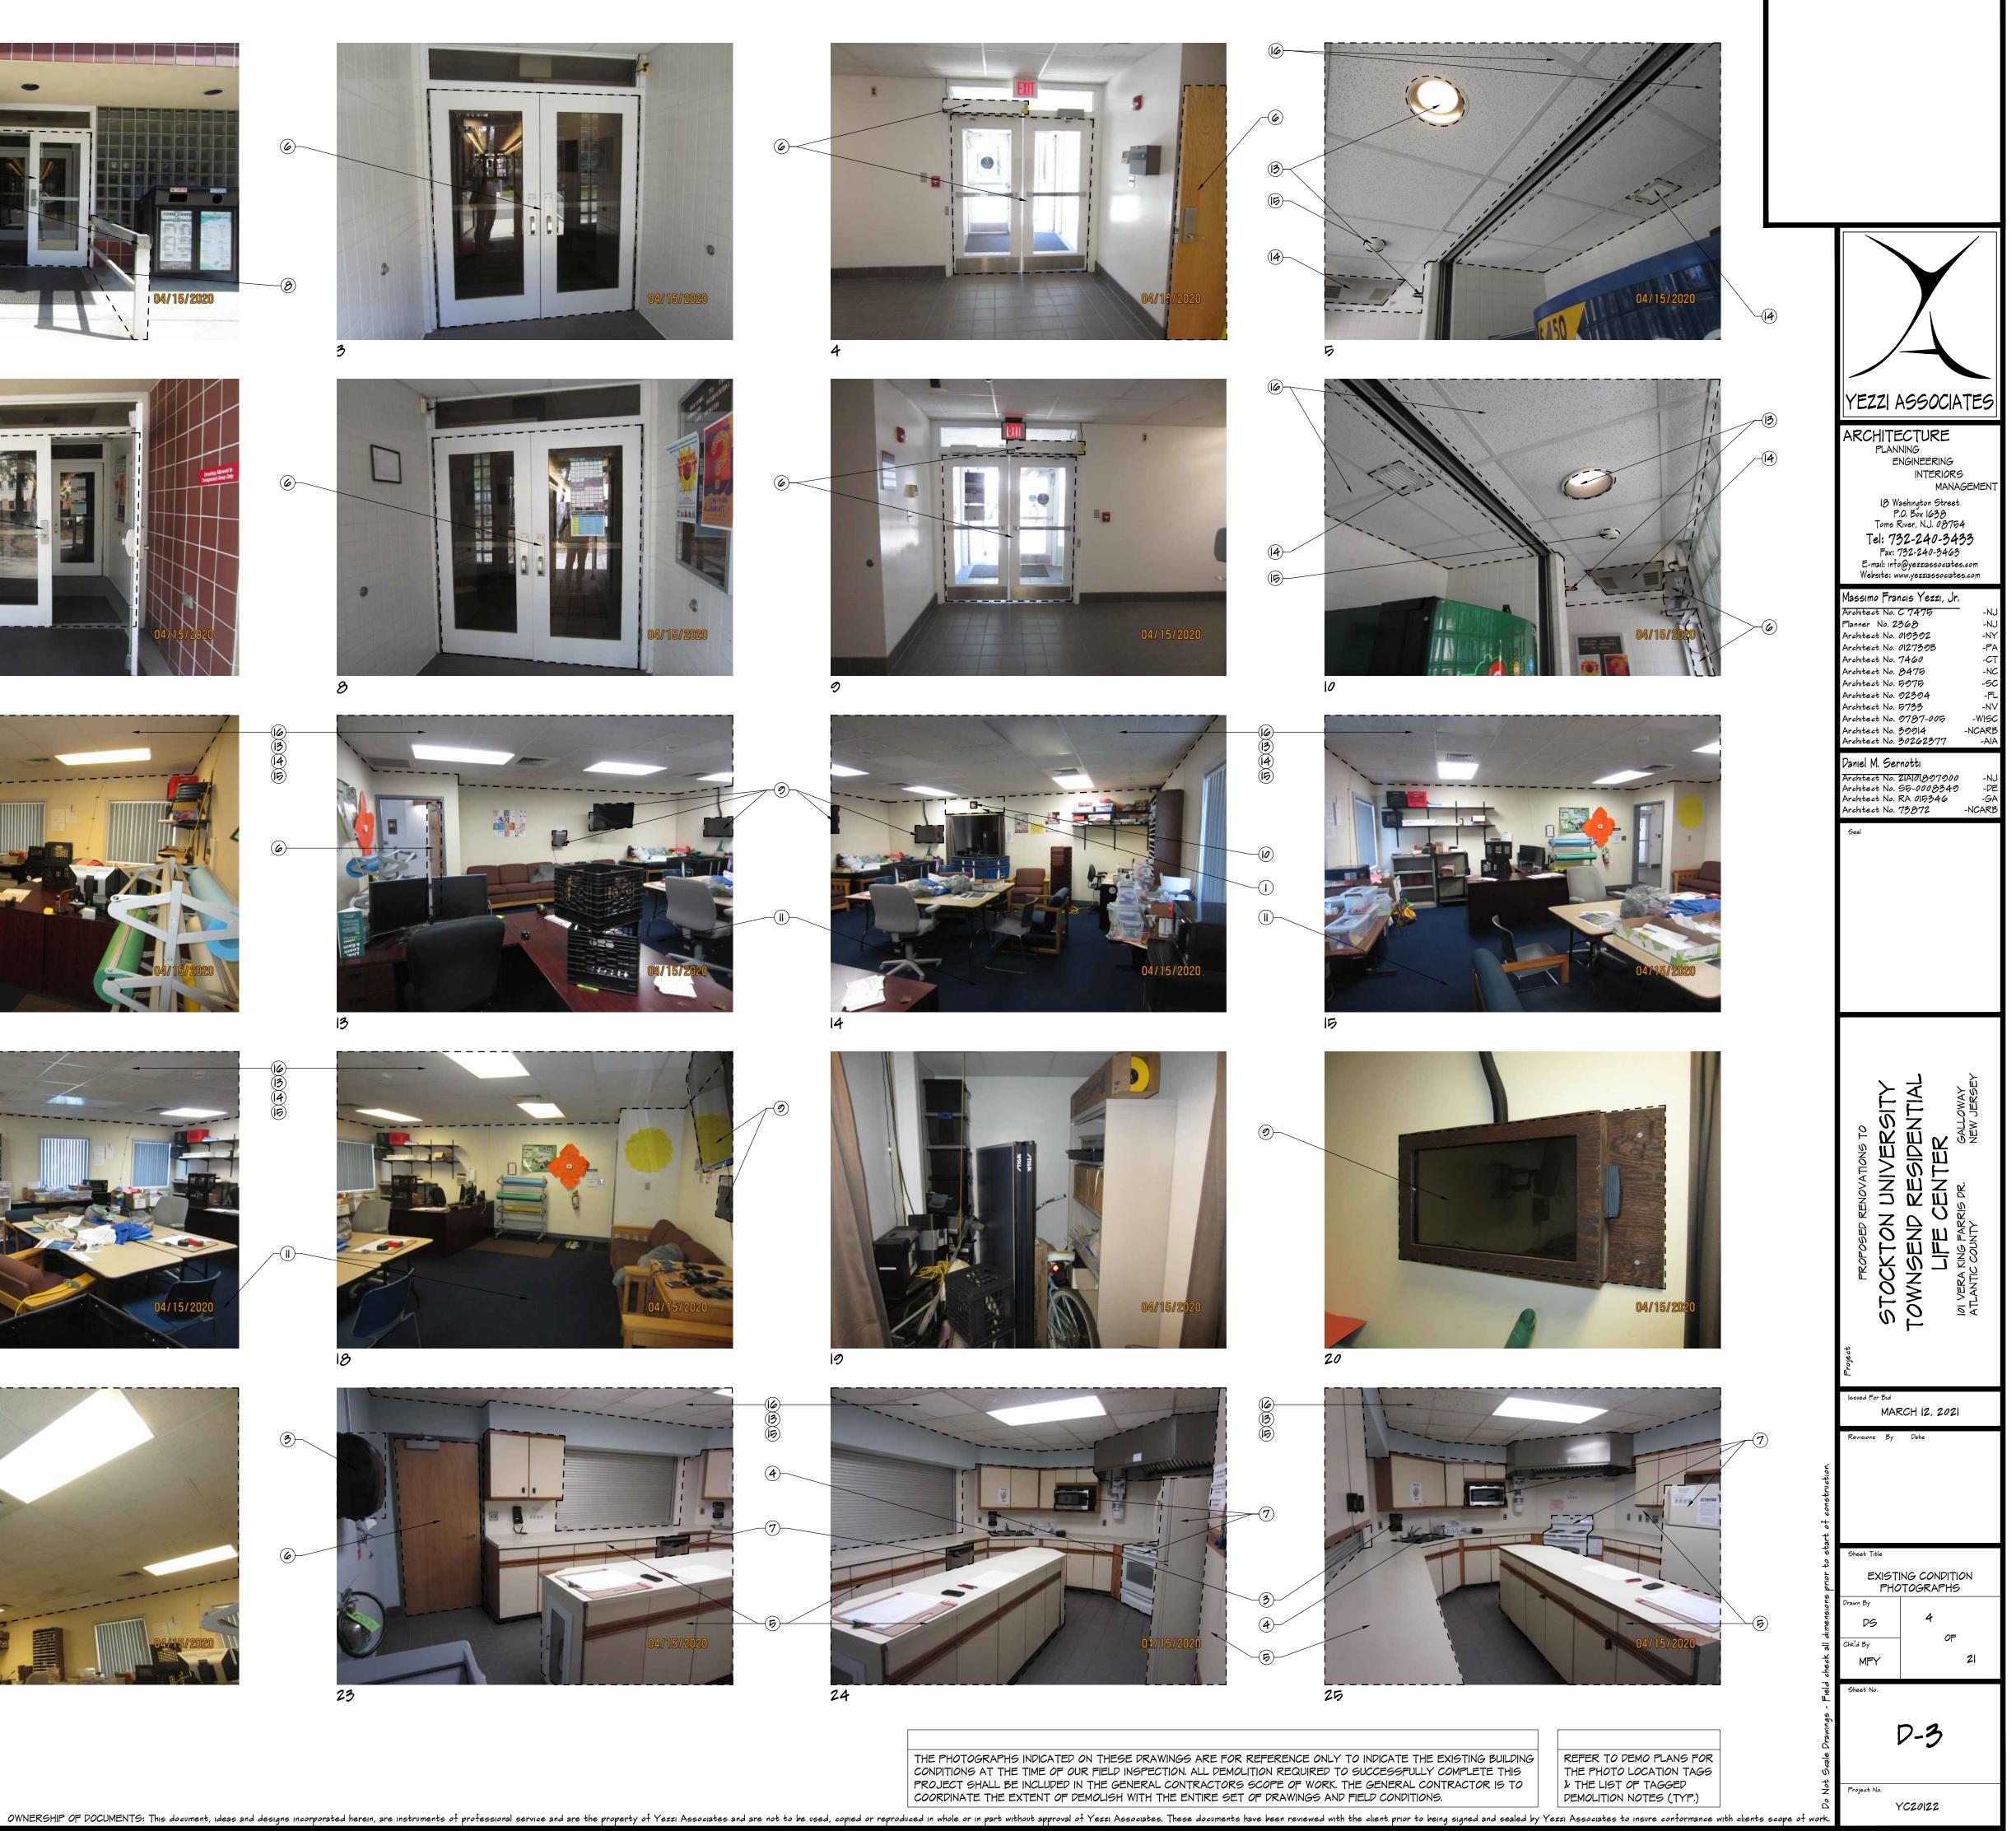











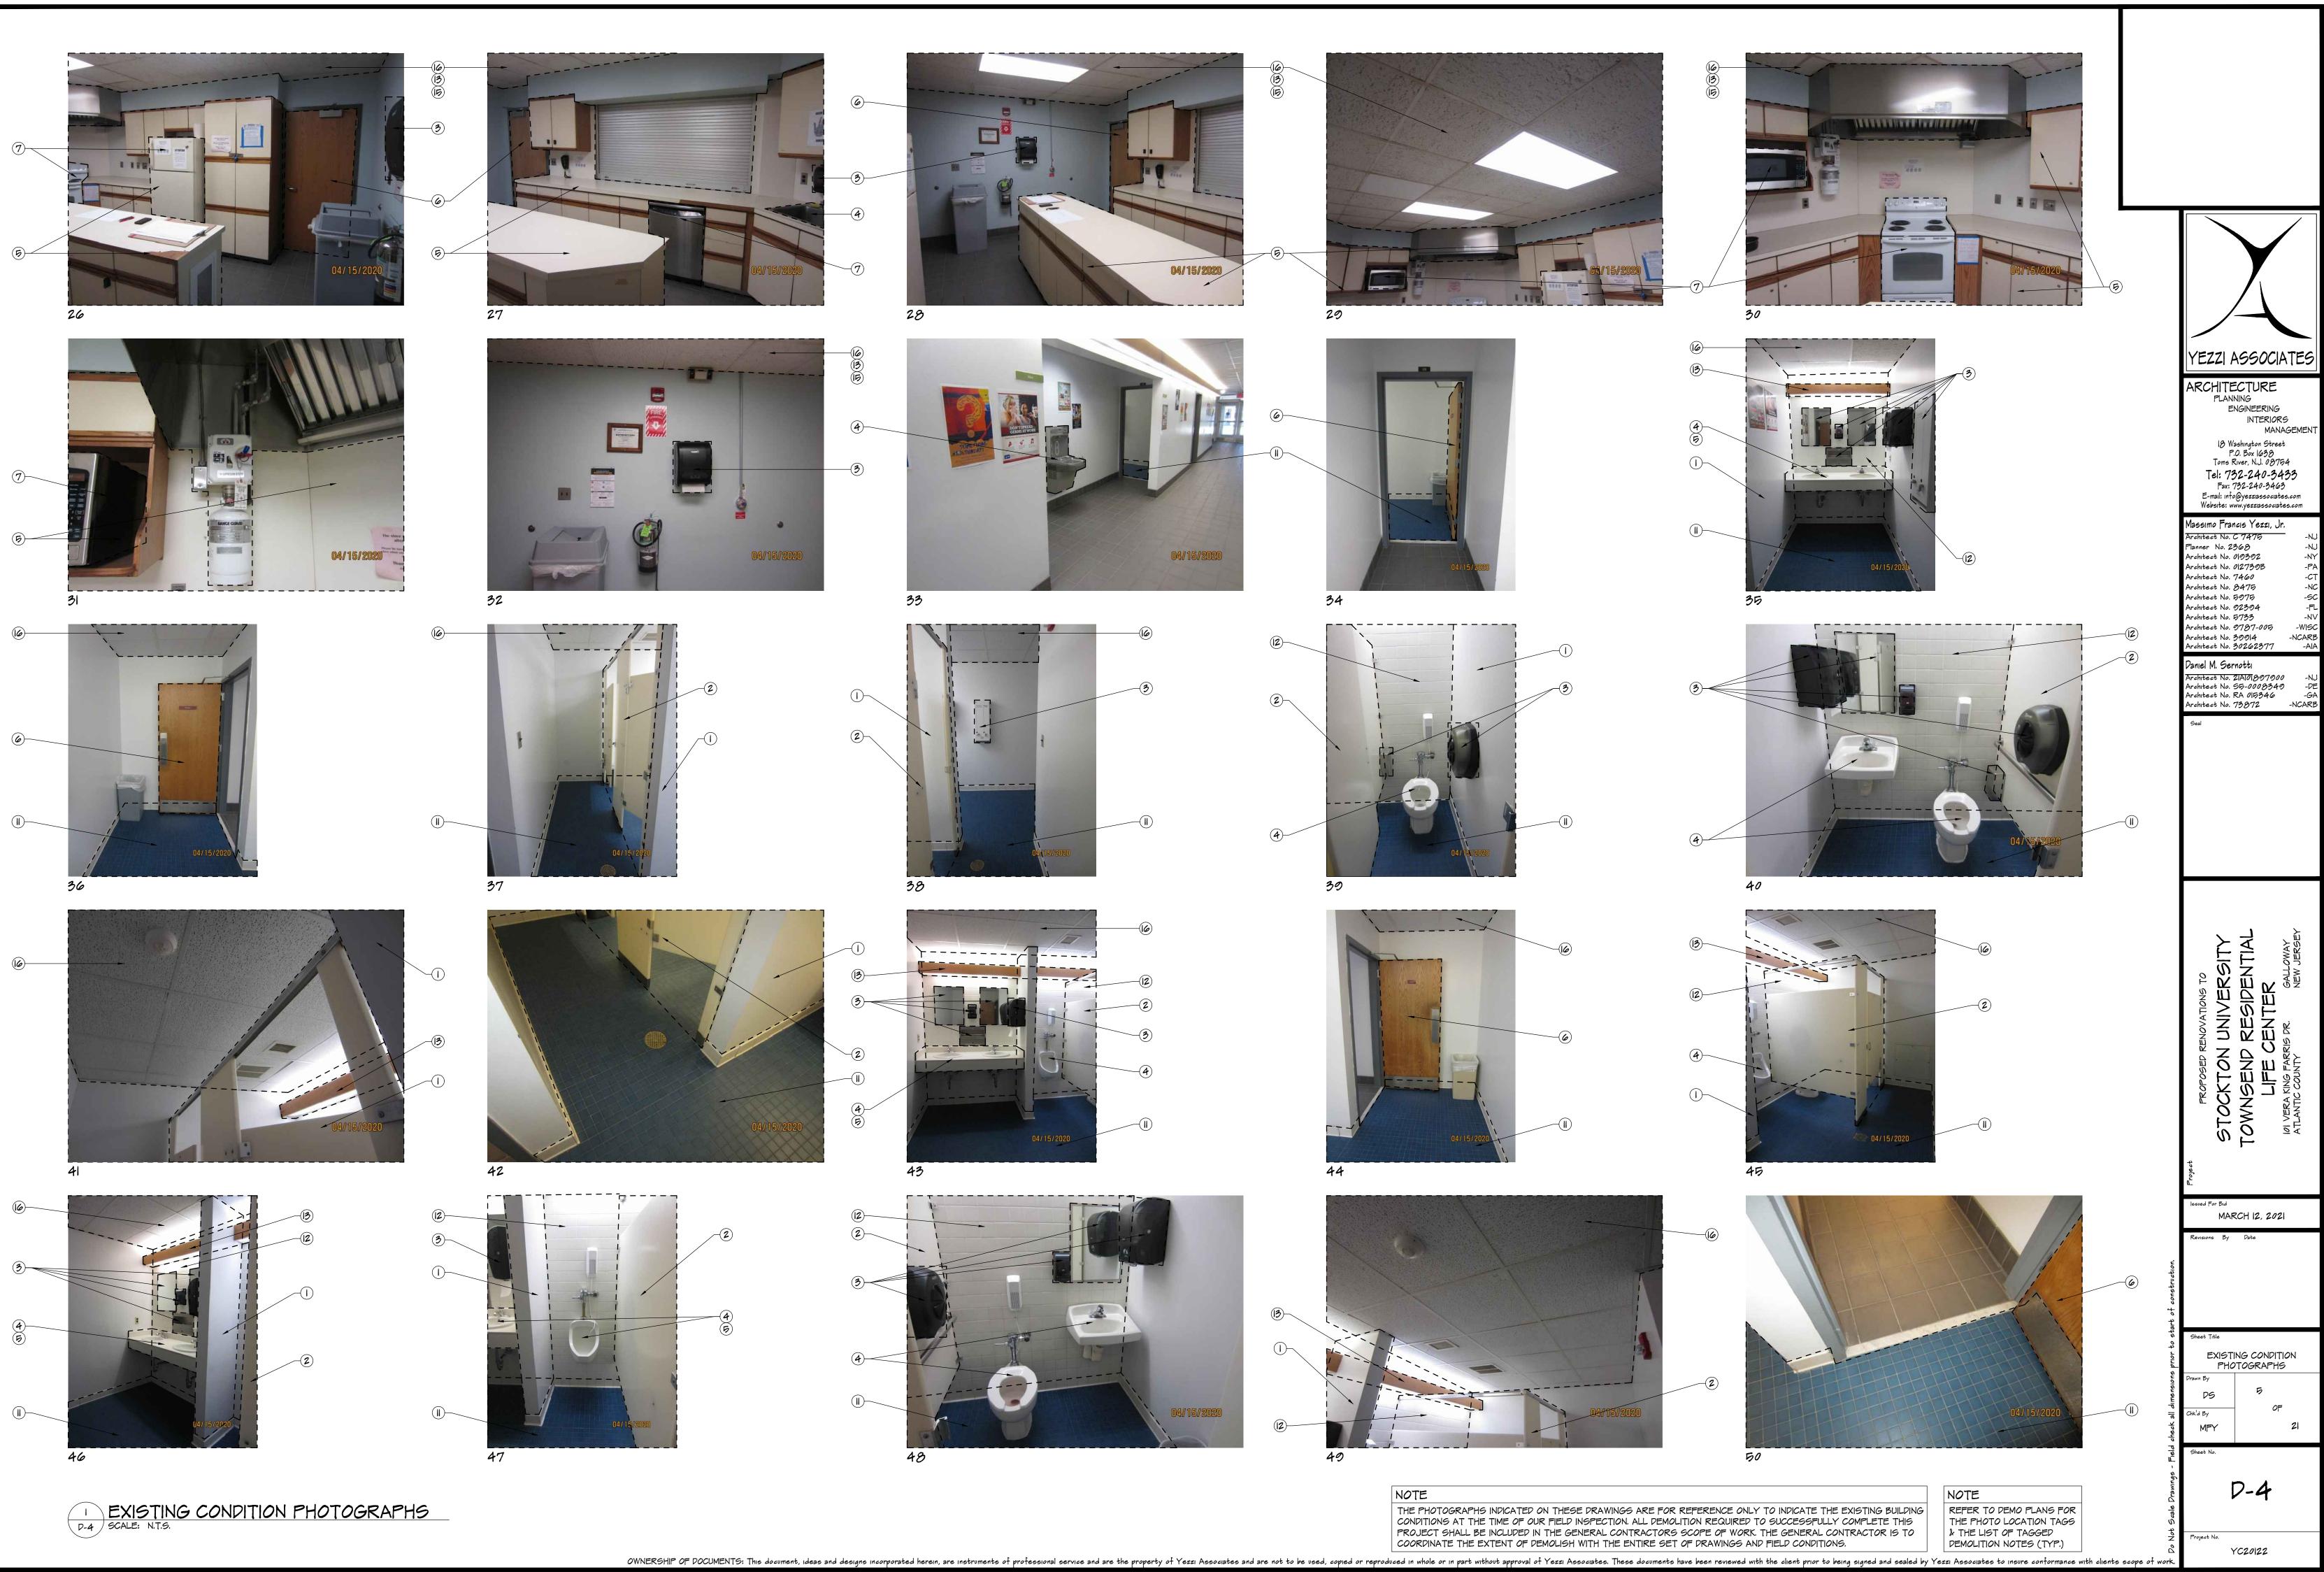



SYMBOL LEGEND

| SYMBOL LE | GENV |
|-----------|---|
| | EXISTING TO REMAIN |
| | NEW METAL STUD WALL, REFER TO WALL SECTIONS FOR ADDITIONAL INFO. |
| | NOT IN CONTRACT |
| E | EXISTING STOREFRONT, DOOR & WINDOW TO REMAIN, NO CHANGE |
| | EXISTING POWER RECEPTACLE (TYP.) |
| F | EXISTING FIRE ALARM MANUAL PULL STATION (TYP.) |
| | EXISTING FIRE ALARM AUDIO / VISUAL DEVICE (TYP.) |
| T | EXISTING THERMOSTAT (TYP.) |
| V | EXISTING DATA RECEPTACLE (TYP.) |
| | EXISTING ELECTRICAL PANEL (TYP.) |
| T | EXISTING HOSE BID (TYP.) |
| РВ | EXISTING REMOTE ACTUATOR (TYP.) |
| | EXISTING O.H. DOOR OPERATOR (TYP.) |
| РВ | PROPOSED/RELOCATED REMOTE ACTUATOR (TYP.) |
| РВ | PROPOSED/RELOCATED REMOTE ACTUATOR (TYP.) |
| | PROPOSED DATA BOX & PULL STRING TO ABOVE CEILING (TYP.) |

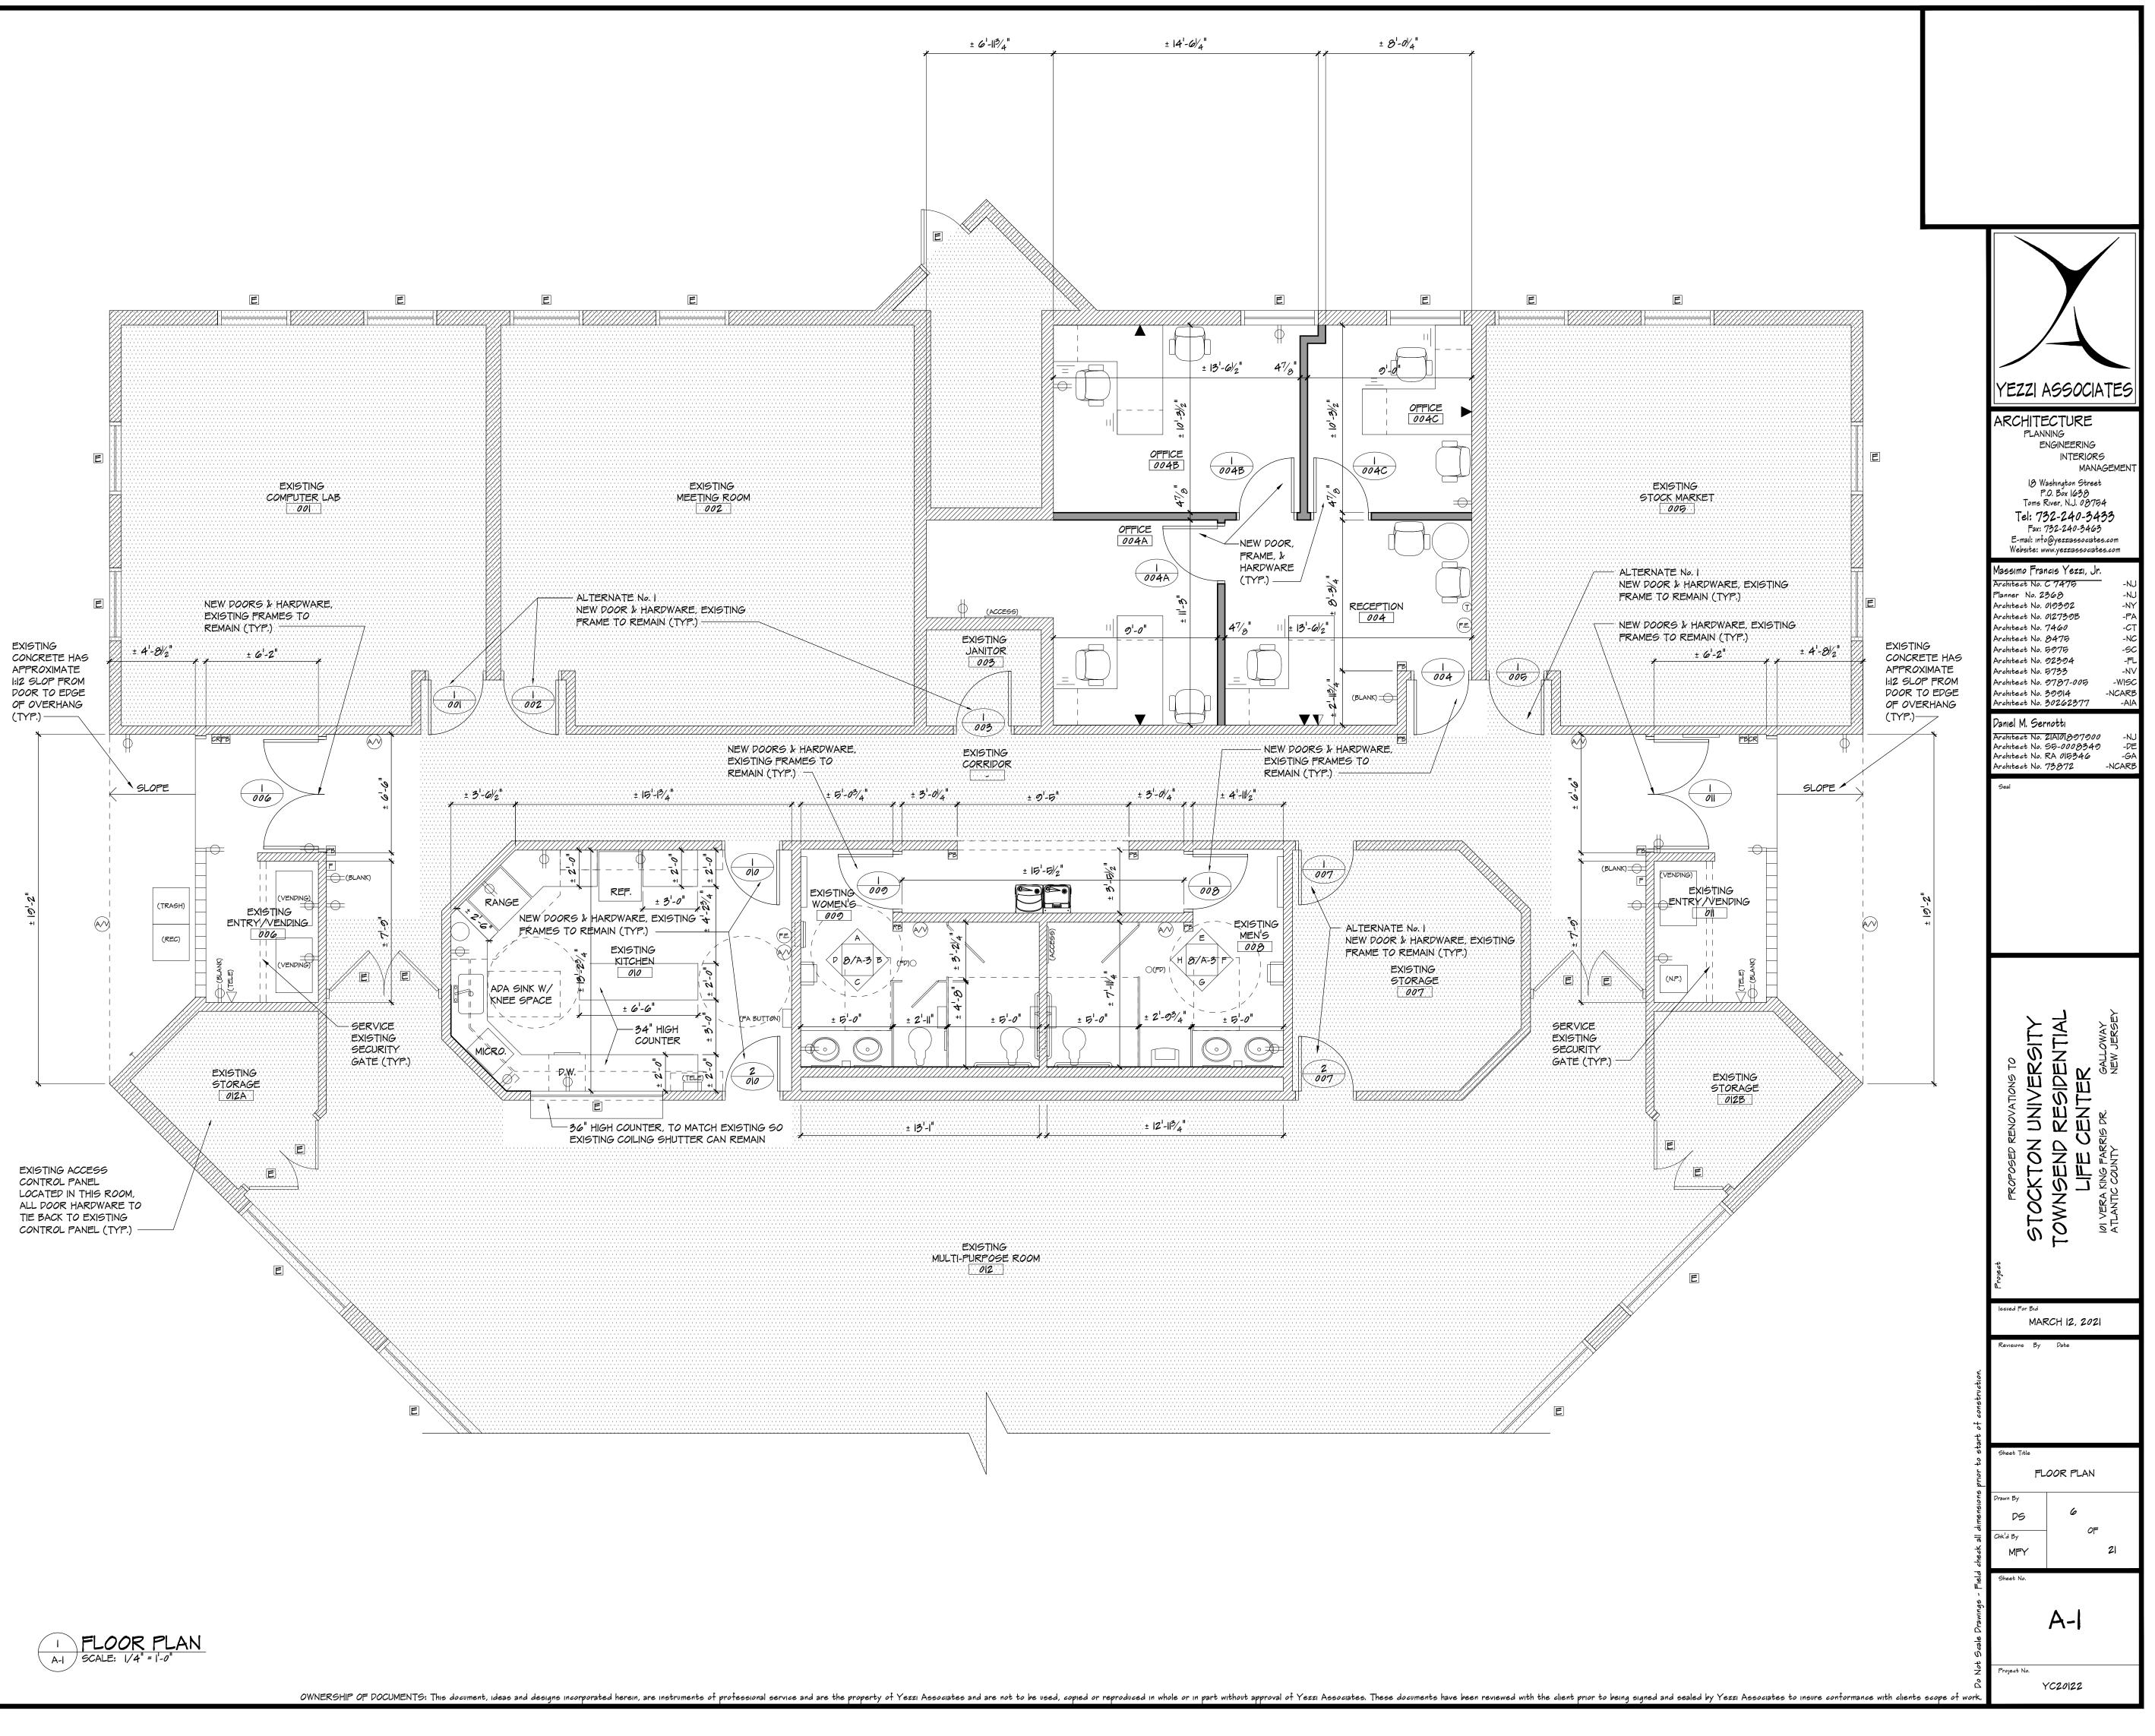




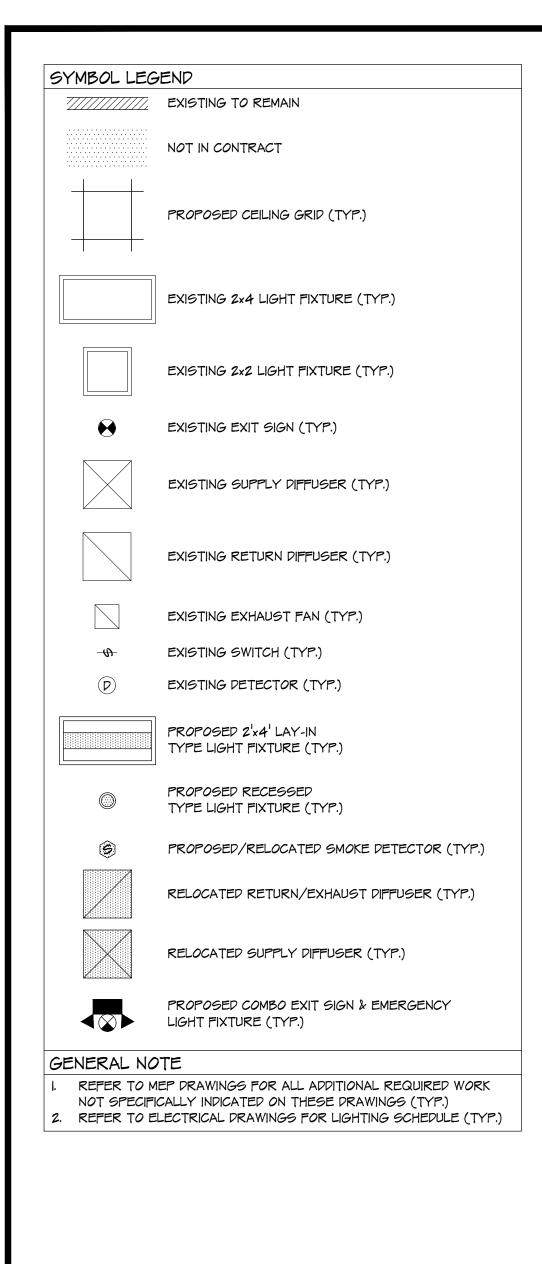


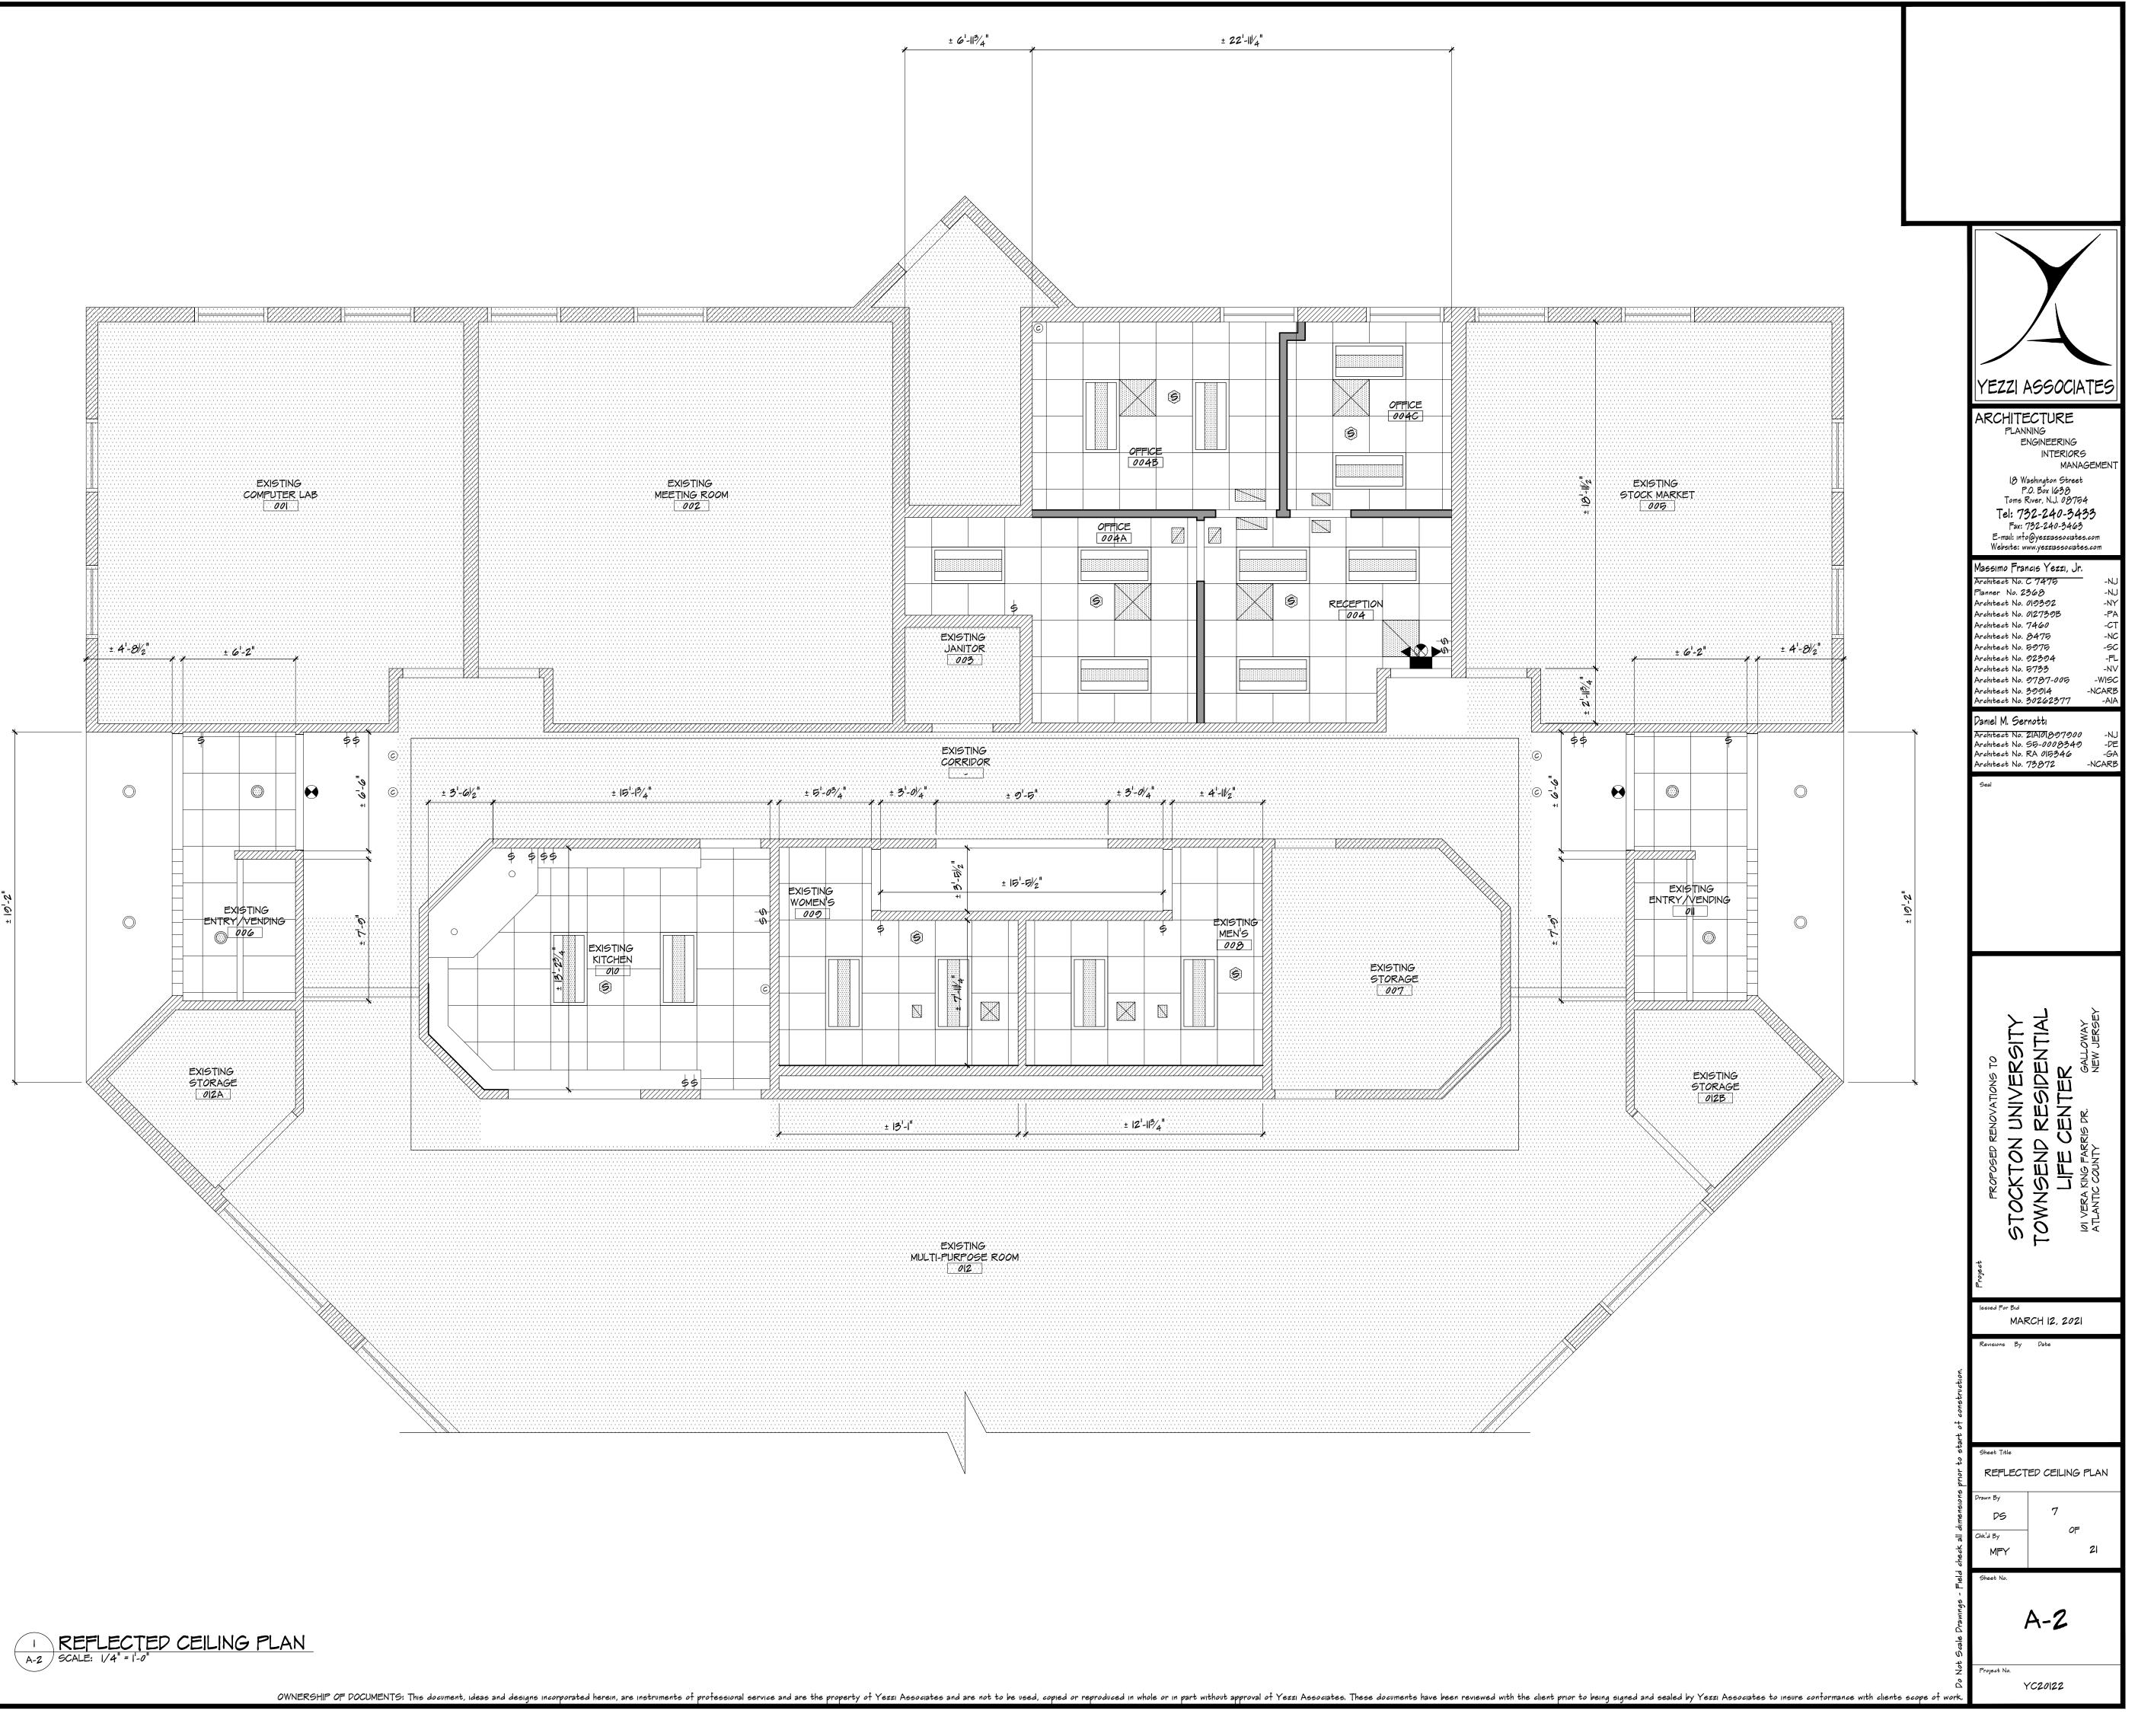




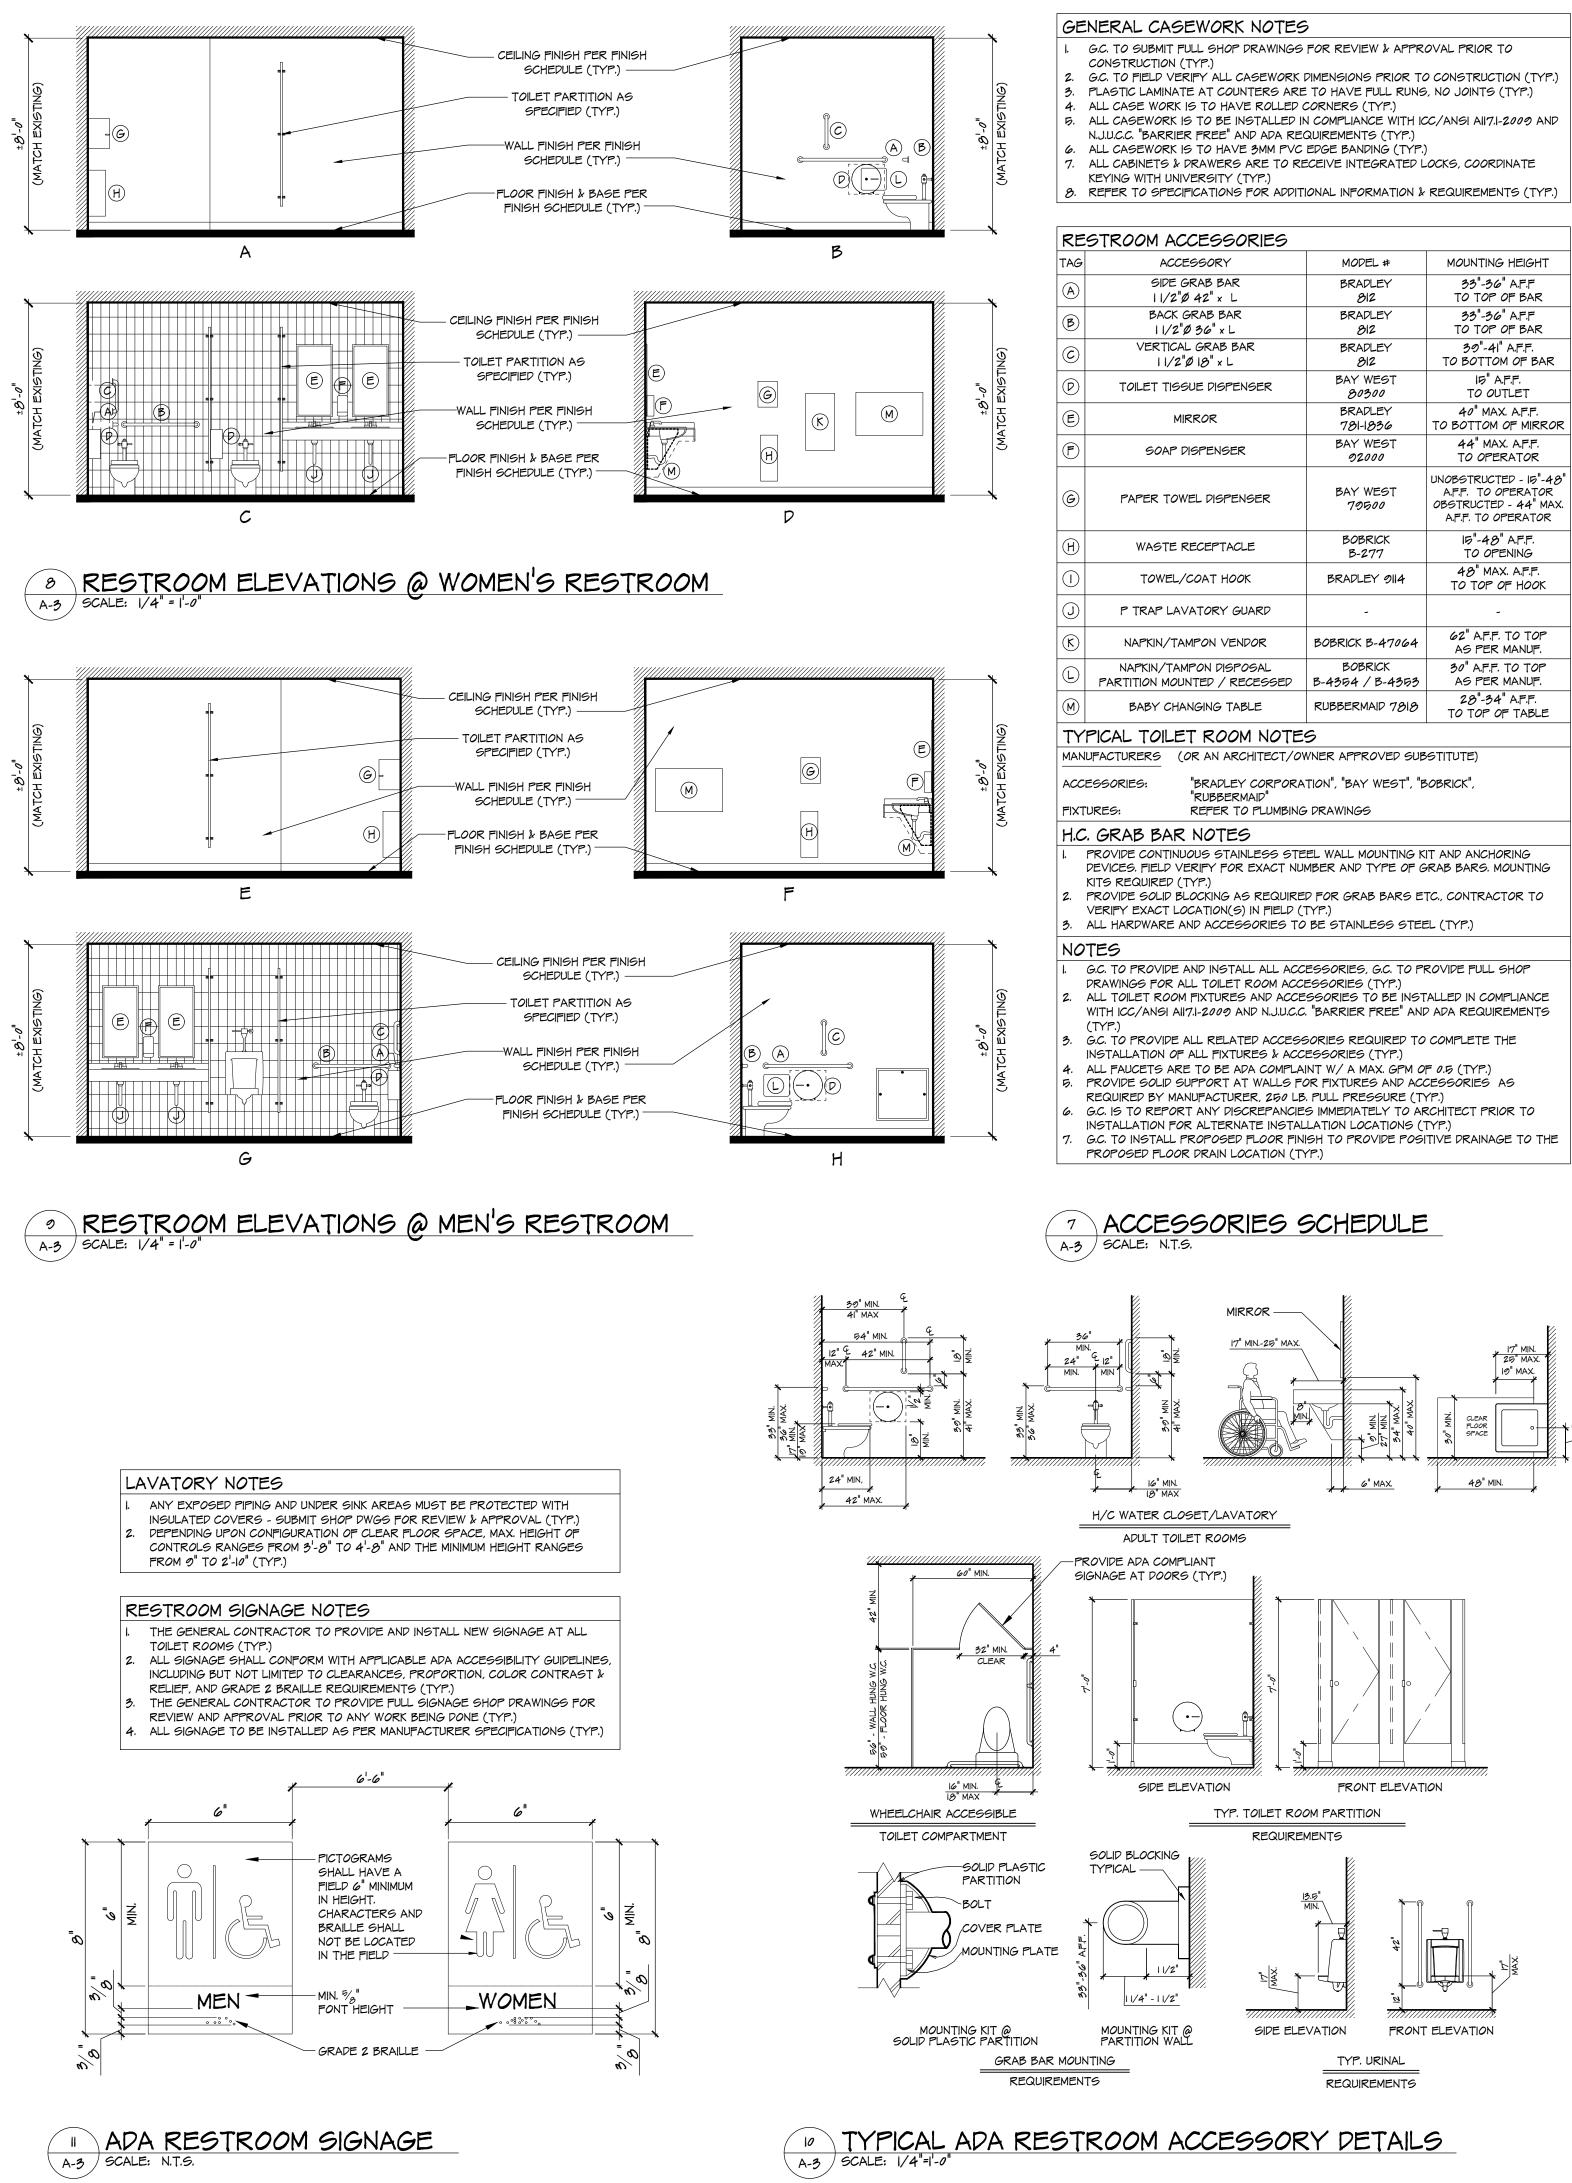


| /2"Ø 8" × L | 812 | TO BOTTOM OF BAR |
|---|----------------------------|---|
| TOILET TISSUE DISPENSER | BAY WEST 80300 | IG" A.F.F. TO OUTLET |
| MIRROR | BRADLEY 781-1836 | 40" MAX. A.F.F. TO BOTTOM OF MIRROR |
| SOAP DISPENSER | BAY WEST 02000 | 44" MAX. A.F.F. TO OPERATOR |
| PAPER TOWEL DISPENSER | BAY WEST 70500 | UNOBSTRUCTED - 15"-48" A.F.F. TO OPERATOR OBSTRUCTED - 44" MAX. A.F.F. TO OPERATOR |
| WASTE RECEPTACLE | BOBRICK B-277 | 15"-48" A.F.F. TO OPENING |
| TOWEL/COAT HOOK | BRADLEY 9114 | 48" MAX. A.F.F. TO TOP OF HOOK |
| P TRAP LAVATORY GUARD | - | - |
| NAPKIN/TAMPON VENDOR | BOBRICK B-47064 | 62" A.F.F. TO TOP AS PER MANUF. |
| NAPKIN/TAMPON DISPOSAL ARTITION MOUNTED / RECESSED | BOBRICK B-4354 / B-4353 | 30" A.F.F. TO TOP AS PER MANUF. |
| BABY CHANGING TABLE | RUBBERMAID 7818 | 28"-34" A.F.F. TO TOP OF TABLE |

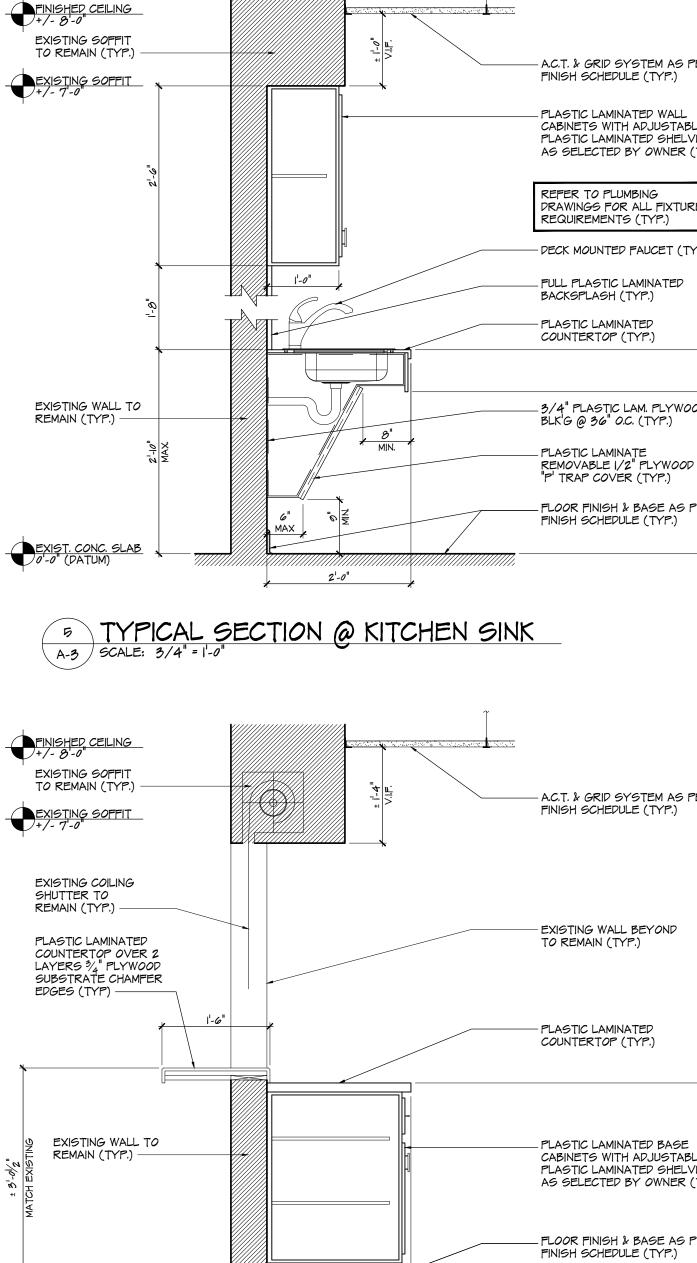

2'-0"

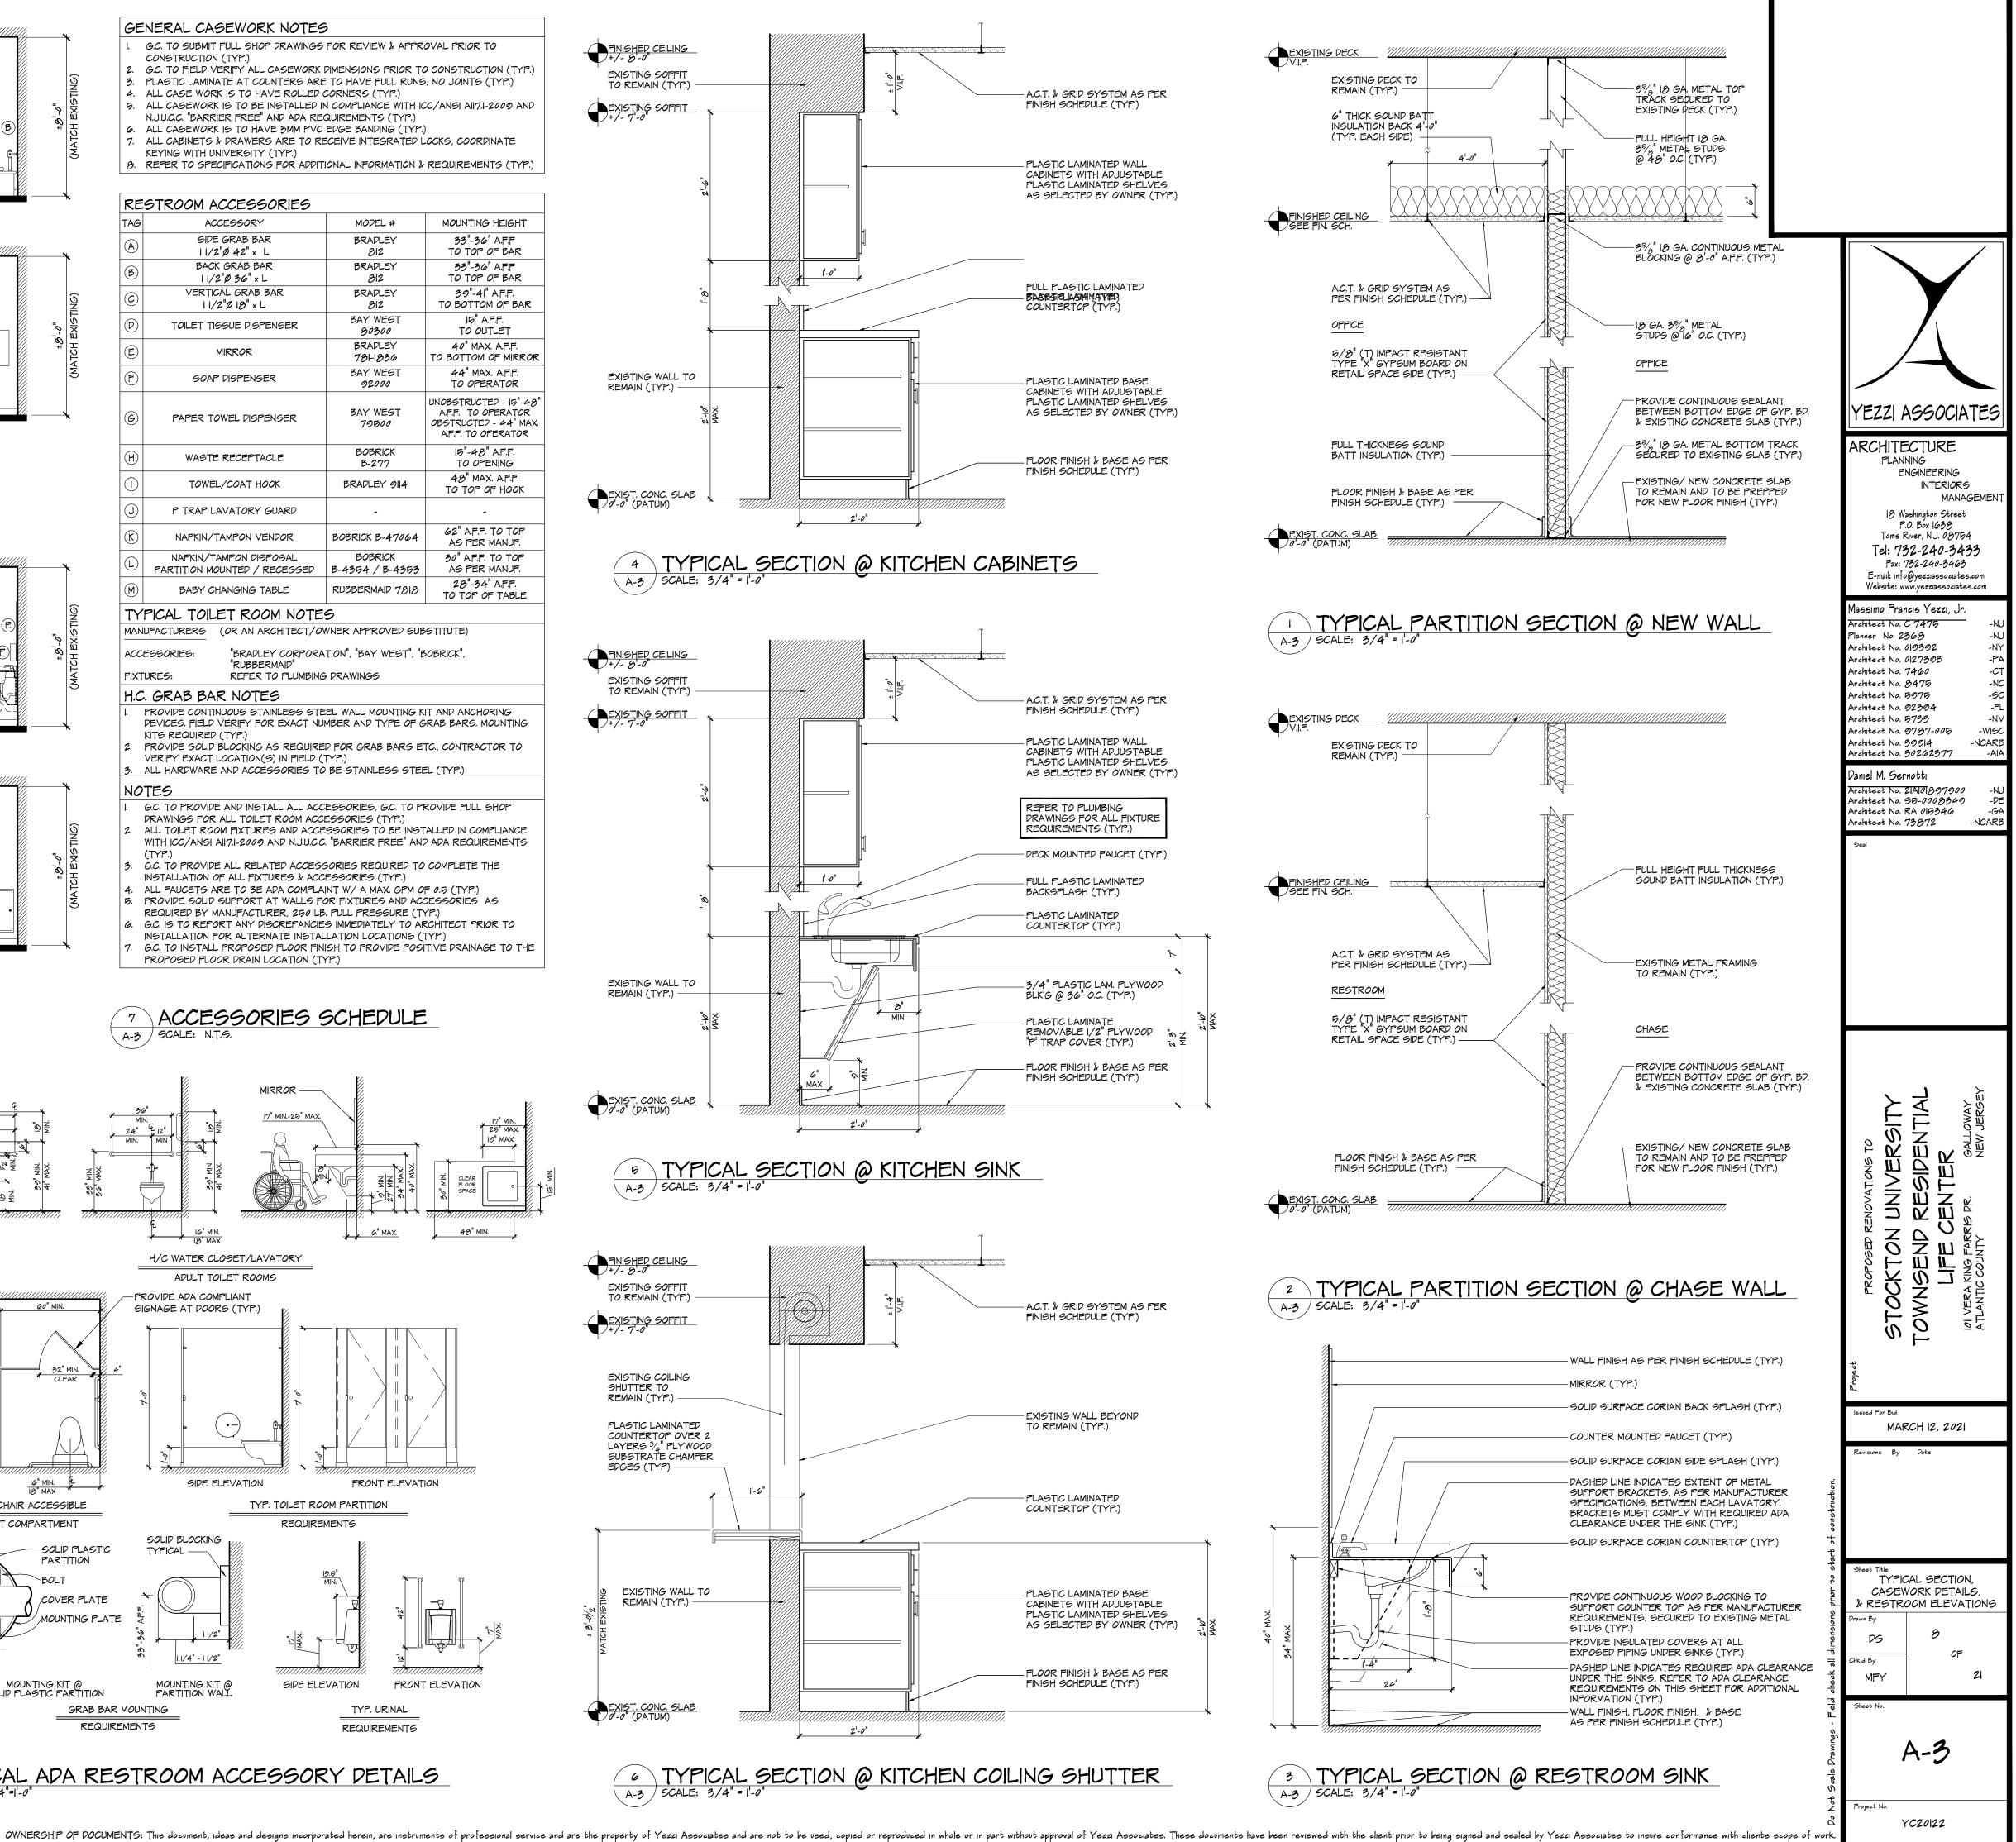

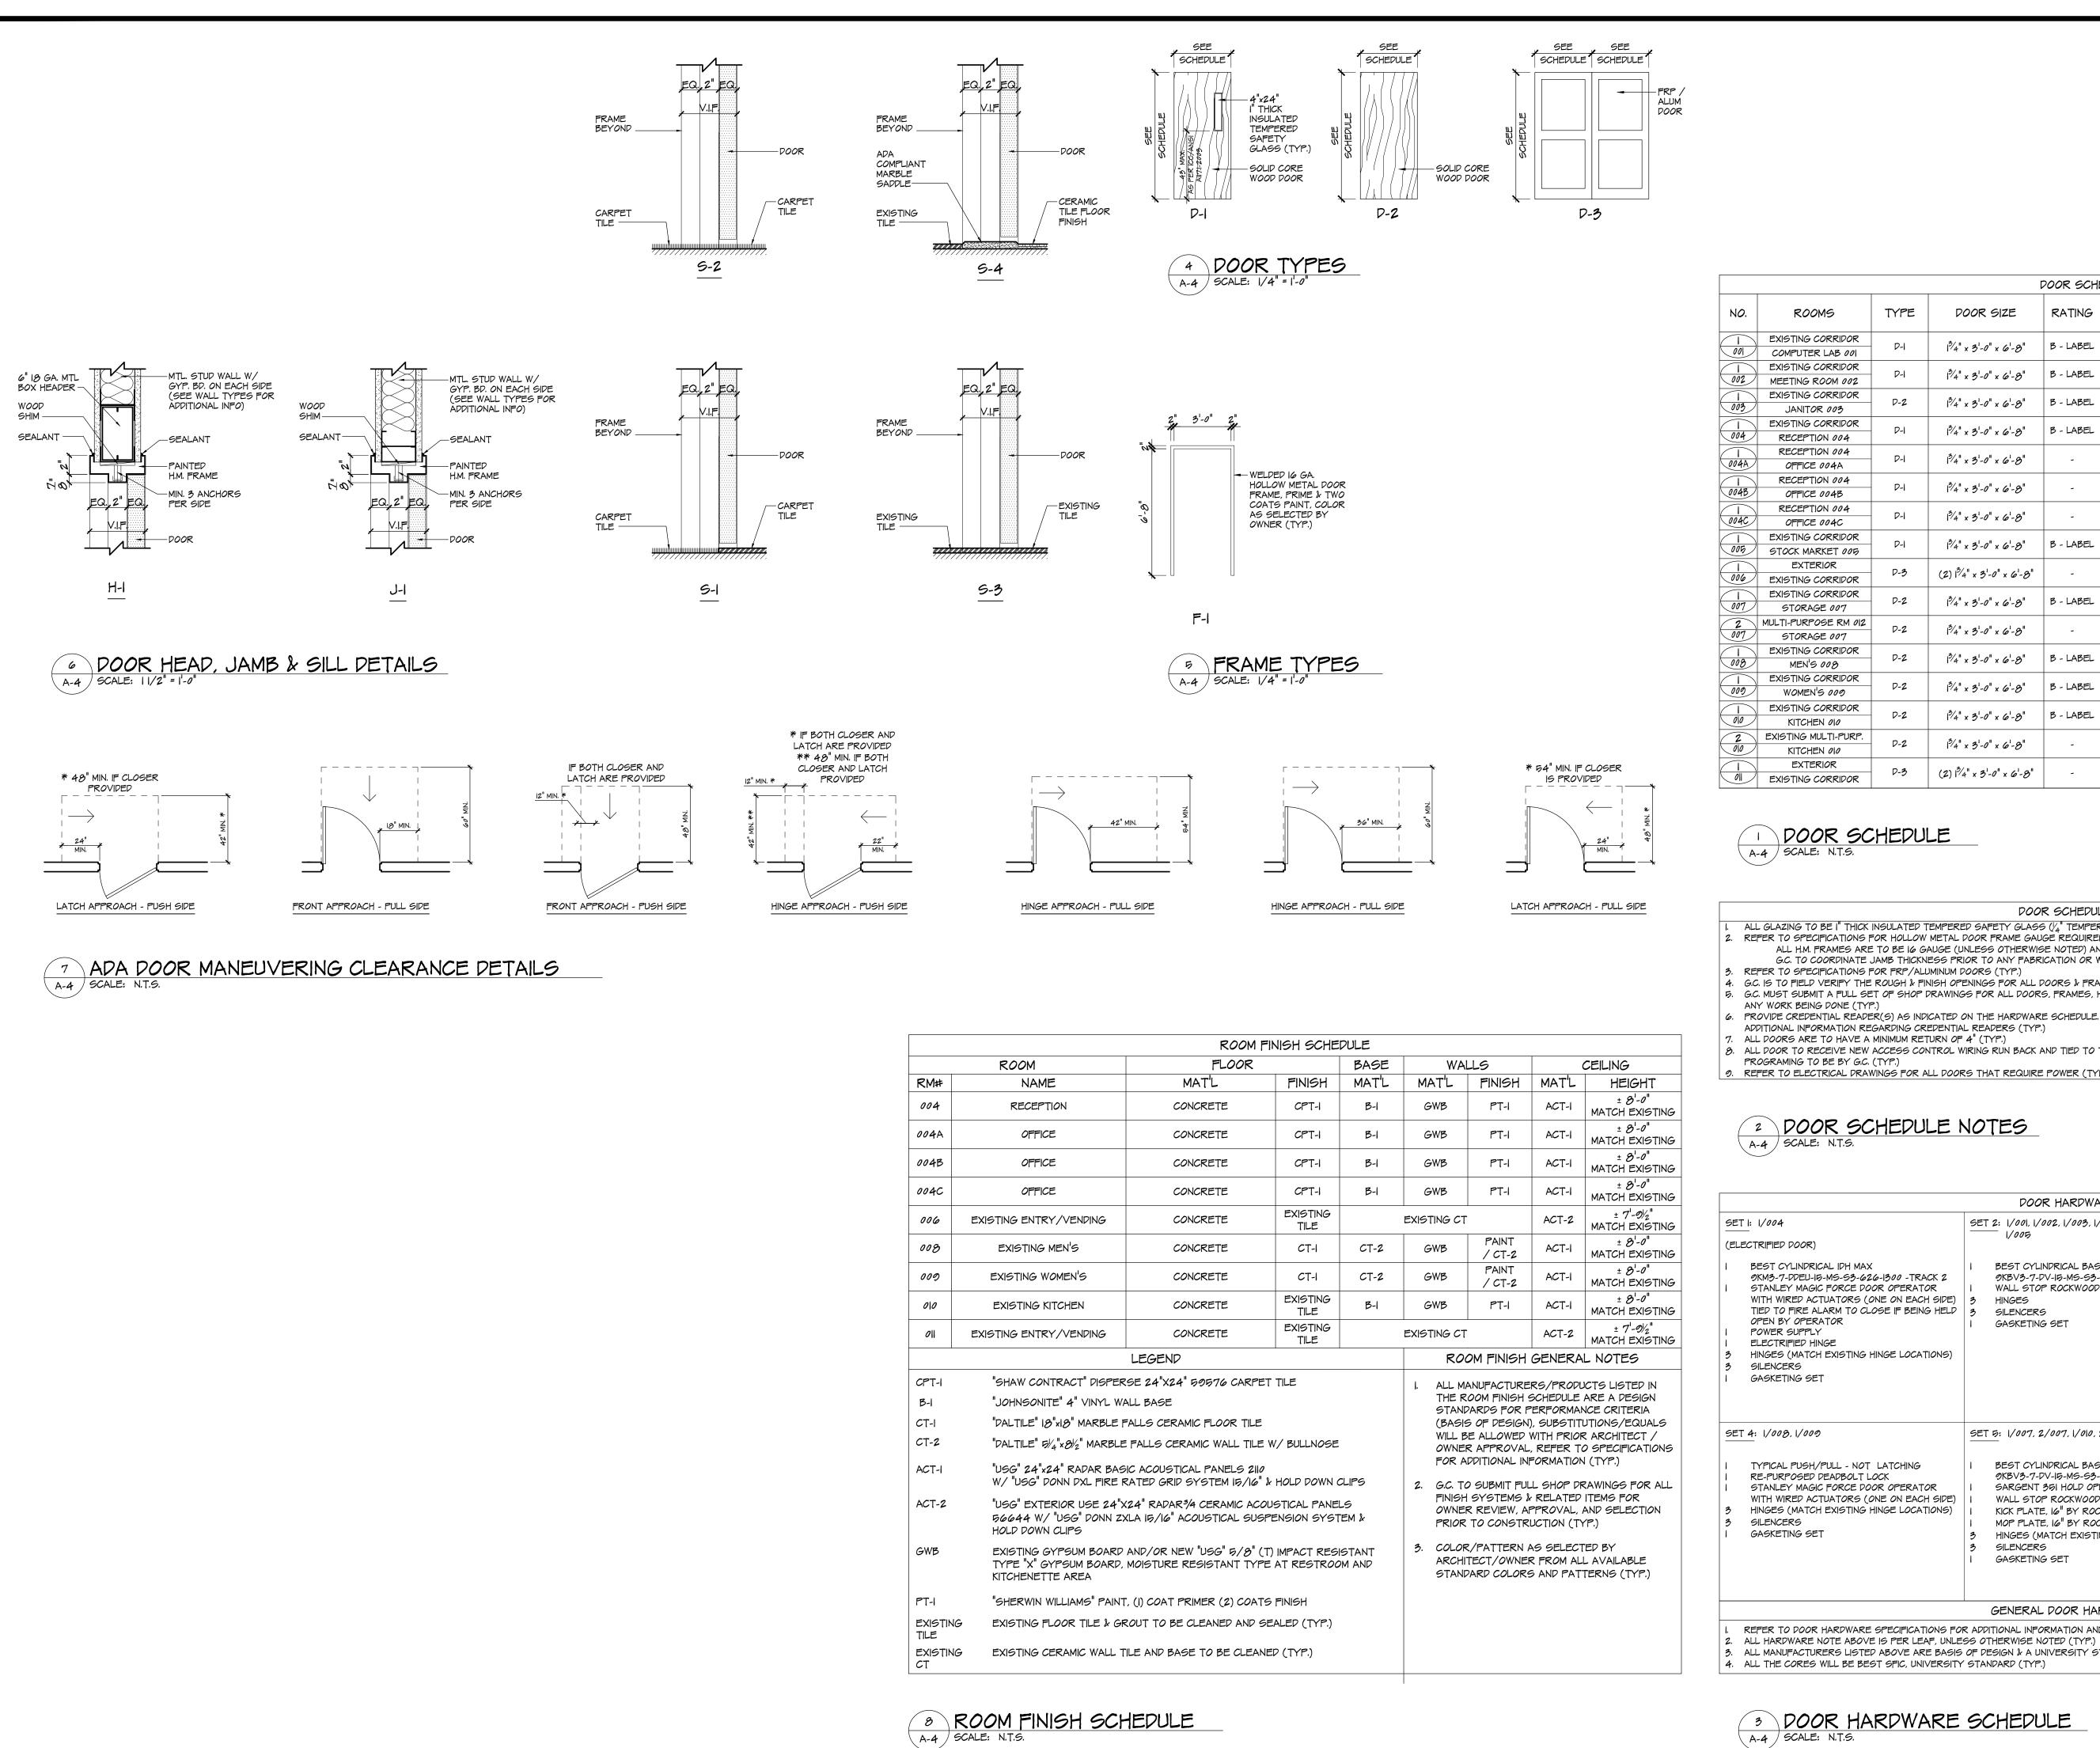

| ROOM | FINISH | SCHEDULE |
|------|--------|----------|

| ROOM | | FLOOR | FLOOR BA | | WALLS | | CEILING | |
|------|--|----------|------------------|------|-------------|-----------------|---------|-----------------------------|
| RM# | NAME | MATL | FINISH | MATL | MATL | FINISH | MATL | HEIGHT |
| 004 | RECEPTION | CONCRETE | CPT-I | B-1 | GWB | PT-I | ACT-I | ± 8'-0" MATCH EXISTIN |
| 004A | OFFICE | CONCRETE | CPT-I | B-1 | GWB | PT-I | ACT-I | ± 8'-0" MATCH EXISTIN |
| 004B | OFFICE | CONCRETE | CPT-I | B-I | GWB | PT-I | ACT-I | ± 8'-0" MATCH EXISTIN |
| 004C | OFFICE | CONCRETE | CPT-I | B-I | GWB | PT-I | ACT-I | ± 8'-0" MATCH EXISTIN |
| 006 | EXISTING ENTRY/VENDING | CONCRETE | EXISTING TILE | | EXISTING CT | | ACT-2 | ± 7'-9½" MATCH EXISTIN |
| 008 | EXISTING MEN'S | CONCRETE | CT-I | CT-2 | GWB | PAINT / CT-2 | ACT-I | ± 8'-0" MATCH EXISTIN |
| 000 | EXISTING WOMEN'S | CONCRETE | CT-I | CT-2 | GWB | PAINT / CT-2 | ACT-I | ± 8'-0" MATCH EXISTIN |
| 010 | EXISTING KITCHEN | CONCRETE | EXISTING TILE | B-I | GWB | PT-I | ACT-I | ± 8'-0" MATCH EXISTIN |
| 011 | EXISTING ENTRY/VENDING | CONCRETE | EXISTING TILE | | EXISTING CT | | ACT-2 | ± 7'-91/2" MATCH EXISTIN |
| | LEGEND | | | | | OM FINISH | GENERA | L NOTES |
| CPTI | PT I "GHAW CONTRACT" DIGPERGE 24"V24" GOGTA CARPET THE | | | | | | | |

| CPT-I | "SHAW CONTRACT" DISPERSE 24"X24" 59576 CARPET TILE |
|----------|--|
| B-1 | "JOHNSONITE" 4" VINYL WALL BASE |
| CT-I | "DALTILE" $18" \times 18"$ MARBLE FALLS CERAMIC FLOOR TILE |
| CT-2 | "DALTILE" $5\!\!\!/_4\!\!\!/_x\!\!\!/_2\!\!\!/_z$ " MARBLE FALLS CERAMIC WALL TILE W/ BULLNOSE |
| ACT-I | "USG" 24"x24" RADAR BASIC ACOUSTICAL PANELS 2110 W/ "USG" DONN DXL FIRE RATED GRID SYSTEM 15/16" & HOLD DOWN CLIF |
| ACT-2 | "USG" EXTERIOR USE 24"X24" RADAR34 CERAMIC ACOUSTICAL PANELS 56644 W/ "USG" DONN ZXLA 15/16" ACOUSTICAL SUSPENSION SYSTEM HOLD DOWN CLIPS |
| GWB | EXISTING GYPSUM BOARD AND/OR NEW "USG" 5/8" (T) IMPACT RESIST. TYPE "X" GYPSUM BOARD, MOISTURE RESISTANT TYPE AT RESTROOM A KITCHENETTE AREA |
| PT-I | "SHERWIN WILLIAMS" PAINT, (I) COAT PRIMER (2) COATS FINISH |
| EXISTING | EXISTING FLOOR TILE & GROUT TO BE CLEANED AND SEALED (TYP.) |

| TING | EXISTING CERAMIC WALL TILE AND BASE TO BE CLEANED (TYP.) |
|------|--|
| | |

| | DOOR SCHEDULE | | | | | | | | | |
|---------------------|---------------|--|-----------|-----------------|----------|-------|----------|------|-------------|------|
| <u> </u> | TYPE | | PATINIC | BASE BID VS | | FRAME | | | | HDW. |
| 9 | | DOOR SIZE | RATING | ALTERNATE | TYPE | MATL | Н | J | 9 | SET |
| RRIDOR .AB 001 | D-1 | 1 ³ ⁄4" × 3'-0" × 6'-8" | B - LABEL | ALTERNATE No. 1 | EXISTING | H.M. | EXIS | TING | S-1 | 2 |
| RRIDOR OM 002 | D-1 | 1 ³ ⁄4" × 3'-0" × 6'-8" | B - LABEL | ALTERNATE No. I | EXISTING | H.M. | EXIS | TING | <u>5-</u> 1 | 2 |
| RRIDOR 003 | D-2 | 1 ³ ⁄4" × 3'-0" × 6'-8" | B - LABEL | ALTERNATE No. I | EXISTING | H.M. | EXIS | TING | 5-3 | 2 |
| RRIDOR 1004 | D-1 | 1 ³ ⁄4" × 3'-0" × 6'-8" | B - LABEL | BASE BID | EXISTING | H.M. | EXIS | TING | S-I | I |
| 1 <i>004</i> 04A | D-1 | 1 ³ ⁄4" × 3'-0" × 6'-8" | - | BASE BID | F-1 | H.M. | Н-І | J-I | 5-2 | 2 |
| 1 <i>004</i> 04B | D-1 | 1 ³ ⁄4" × 3'-0" × 6'-8" | - | BASE BID | F-1 | H.M. | H-I | J-I | 5-2 | 2 |
| 1 004 04C | D-1 | 1 ³ ⁄4" × 3'-0" × 6'-8" | - | BASE BID | F-1 | H.M. | Н-І | J-I | 5-2 | 2 |
| RRIDOR ET 005 | D-1 | 1 ³ ⁄4" × 3'-0" × 6'-8" | B - LABEL | ALTERNATE No. I | EXISTING | H.M. | EXIS | TING | 5-1 | 2 |
| OR RRIDOR | D-3 | $(2) ^{3/4} \times 3^{1} - 0^{1} \times 6^{1} - 8^{1}$ | - | BASE BID | EXISTING | H.M. | EXIS | TING | 5-3 | 3 |
| RRIDOR 007 | D-2 | 1 ³ ⁄4" × 3'-0" × 6'-8" | B - LABEL | ALTERNATE No. I | EXISTING | H.M. | EXIS | TING | 5-3 | Б |
| E RM 012 007 | D-2 | 1 ³ ⁄4" × 3'-0" × 6'-8" | - | ALTERNATE No. I | EXISTING | H.M. | EXISTING | | 5-3 | Б |
| RRIDOR 08 | D-2 | ³ ⁄4" × 3'-0" × 6'-8" | B - LABEL | BASE BID | EXISTING | H.M. | EXISTING | | 5-4 | 4 |
| RRIDOR 009 | D-2 | ³ ⁄4" × 3'-0" × 6'-8" | B - LABEL | BASE BID | EXISTING | H.M. | EXISTING | | 5-4 | 4 |
| RRIDOR 010 | D-2 | 1 ³ ⁄4" × 3'-0" × 6'-8" | B - LABEL | BASE BID | EXISTING | H.M. | EXIS | TING | 5-3 | Б |
| TI-PURP. 010 | D-2 | ³ ⁄4" × 3'-0" × 6'-8" | - | BASE BID | EXISTING | H.M. | EXIS | TING | 5-3 | Б |
| OR RRIDOR | D-3 | (2) ^{3/} 4" × 3'-0" × 6'-8" | - | BASE BID | EXISTING | H.M. | EXIS | TING | 5-3 | 3 |

DOOR SCHEDULE

DOOR SCHEDULE NOTES

ALL GLAZING TO BE I" THICK INSULATED TEMPERED SAFETY GLASS ($\frac{1}{4}$ " TEMPERED SAFETY GLASS / $\frac{1}{2}$ " AIR SPACE / $\frac{1}{4}$ " TEMPERED SAFETY GLASS) (TYP.) 2. REFER TO SPECIFICATIONS FOR HOLLOW METAL DOOR FRAME GAUGE REQUIREMENTS. ALL H.M. FRAMES ARE TO BE 16 GAUGE (UNLESS OTHERWISE NOTED) AND ARE TO BE PRIMED & PAINTED, COLOR AS SELECTED BY OWNER (TYP.) G.C. TO COORDINATE JAMB THICKNESS PRIOR TO ANY FABRICATION OR WORK IS DONE (TYP.)

4. G.C. IS TO FIELD VERIFY THE ROUGH & FINISH OPENINGS FOR ALL DOORS & FRAMES (TYP.) 5. G.C. MUST SUBMIT A FULL SET OF SHOP DRAWINGS FOR ALL DOORS, FRAMES, HARDWARE AND ALL RELATED ITEMS FOR REVIEW AND APPROVAL PRIOR TO 6. PROVIDE CREDENTIAL READER(S) AS INDICATED ON THE HARDWARE SCHEDULE. REFER TO FLOOR PLAN, ELECTRICAL DRAWINGS, AND SPECIFICATIONS FOR

ADDITIONAL INFORMATION REGARDING CREDENTIAL READERS (TYP.) 7. ALL DOORS ARE TO HAVE A MINIMUM RETURN OF 4" (TYP.) 8. ALL DOOR TO RECEIVE NEW ACCESS CONTROL WIRING RUN BACK AND TIED TO THE EXISTING ACCESS CONTROL PANEL IN ROOM 012A BY G.C., ALL

9. REFER TO ELECTRICAL DRAWINGS FOR ALL DOORS THAT REQUIRE POWER (TYP.)


2 DOOR SCHEDULE NOTES A-4 SCALE: N.T.S.

| | DOOR HARDWARE SETS | |
|---|--|---|
| L IDH MAX MS-53-626-1300 -TRACK 2 FORCE DOOR OPERATOR DATORS (ONE ON EACH SIDE) | SET 2: 1/001, 1/002, 1/003, 1/004A, 1/004B, 1/004C, 1/005 I BEST CYLINDRICAL BASIS V 9KBV3-7-DV-IG-MS-S3-626-TRACK 2 I WALL STOP ROCKWOOD 409 3 HINGES | SET 3: 1/006, 1/011 (ELECTRIFIED DOOR) I EXIT DEVICE (PHI IN MLR CONFIGURATION) I STANLEY MAGIC FORCE DOOR OPERATOR WITH RELOCATED WIRED ACTUATORS (ON ON EACH SIDE). NEW WIRE RUNS TO PANELS AND |
| RM TO CLOSE IF BEING HELD FOR EXISTING HINGE LOCATIONS) | 3 SILENCERS I GASKETING SET | NEW POWER SUPPLY IN CLOSET 012A. I REQUEST FOR EXIT MOTION SENSOR I CARD READERS TO BE RELOCATED I POWER SUPPLY I & WIRE POWER TRANSFER I DPS (UTC/INTERLOGIX 1078D) I CONTINUOUS HINGES I WEATHER STRIPPING SET I SL-30I DOOR BOTTOM WITH TWO NYLON BRUSH WEATHER STRIPPING BY DOOR MANUFACTURER |
| | <u>SET 5: 1/007, 2/007, 1/010, 2/010</u> | NOTE: TURN OVER ALL OLD HARDWARE TO OWNER. |
| ULL - NOT LATCHING EADBOLT LOCK FORCE DOOR OPERATOR DATORS (ONE ON EACH SIDE) EXISTING HINGE LOCATIONS) | BEST CYLINDRICAL BASIS V 9KBV3-7-DV-IG-MS-S3-626-TRACK 2 SARGENT 35I HOLD OPENER & CLOSER WALL STOP ROCKWOOD 409 KICK PLATE, I6" BY ROCKWOOD MOP PLATE, I6" BY ROCKWOOD HINGES (MATCH EXISTING HINGE LOCATIONS) GILENCERS GASKETING SET | |
| | GENERAL DOOR HARDWARE NOTES | |
| APDWARE OPECIEICATIONS FOR | | |

REFER TO DOOR HARDWARE SPECIFICATIONS FOR ADDITIONAL INFORMATION AND REQUIREMENTS.

3. ALL MANUFACTURERS LISTED ABOVE ARE BASIS OF DESIGN & A UNIVERSITY STANDARD, ALL SUBSTITUTIONS MUST BE APPROVED PRIOR TO ANY WORK. 4. ALL THE CORES WILL BE BEST SFIC, UNIVERSITY STANDARD (TYP.)

3 DOOR HARDWARE SCHEDULE A-4 SCALE: N.T.S.

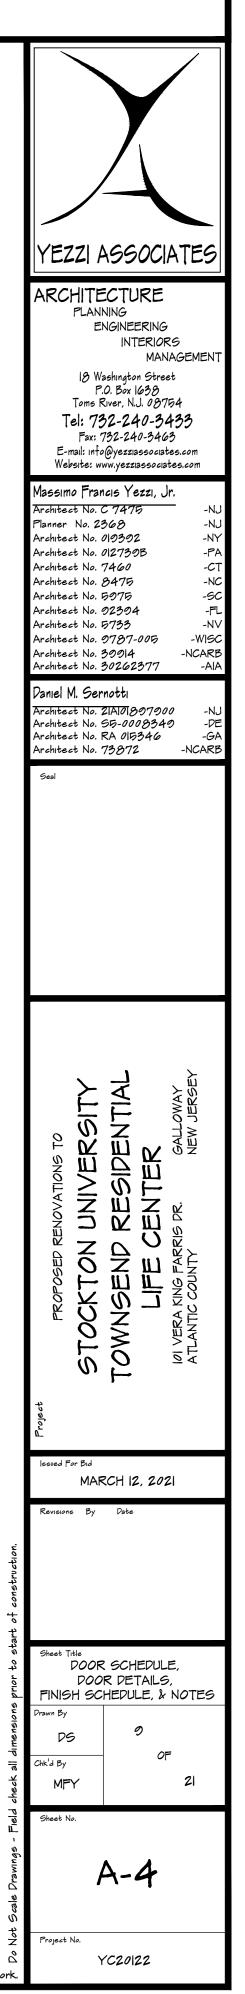

MECHANICAL GENERAL NOTES:

1. WORK IN THIS SECTION INCLUDES THE PROVIDING OF LABOR, MATERIALS, EQUIPMENT AND SERVICES NECESSARY FOR COMPLETE AND SAFE INSTALLATION IN ACCORDANCE WITH THE CONTRACT DOCUMENTS AND AUTHORITIES HAVING JURISDICTION.

2. DRAWINGS ARE DIAGRAMMATIC AND INDICATE GENERAL ARRANGEMENT OF SYSTEMS AND WORK. FOLLOW DRAWINGS IN LAYING OUT WORK AND CHECK DRAWINGS OF OTHER TRADES TO VERIFY SPACE CONDITIONS. MAINTAIN HEADROOM AND SPACE CONDITIONS.

3. SCALED AND FIGURED DIMENSIONS ARE APPROXIMATE AND ARE FOR ESTIMATING PURPOSES ONLY. BEFORE PROCEEDING WITH WORK, CHECK AND VERIFY ALL DIMENSIONS.

4. MAKE ADJUSTMENTS THAT MAY BE NECESSARY OR REQUIRED IN ORDER TO RESOLVE SPACE PROBLEMS.

5. ALL WORK SHALL BE PERFORMED IN ACCORDANCE WITH THE REQUIREMENTS OF THE NEW JERSEY UNIFORM CONSTRUCTION CODE AND ADOPTED (AS AMENDED) SUB CODES STANDARDS INCLUDING BUT NOT LIMITED TO THE FOLLOWING:

- INTERNATIONAL BUILDING CODE NEW JERSEY EDITION / 2018;

- NAPHCC NATIONAL STANDARD PLUMBING CODE / 2018; - NFPA 70 NATIONAL ELECTRIC CODE / 2017;
- ASHRAE 90.1-2016 ENERGY CODE
- INTERNATIONAL MECHANICAL CODE / 2018; - INTERNATIONAL FUEL GAS CODE / 2018;

CERTIFICATIONS AND APPROVALS TO THE OWNER.

6. CONTRACTOR SHALL BE RESPONSIBLE TO APPLY FOR AND PROCURE ALL REQUIRED PERMITS, CERTIFICATES AND AGENCY APPROVALS. ALL DOCUMENTS REQUIRED IN ADDITION TO THE CONTRACT DOCUMENTS SHALL BE PROVIDED BY THE CONTRACTOR. PROVIDE COPIES OF ALL REQUIRED

7. ALL WORK SHALL BE PERFORMED IN A WORKMANLIKE AND PROFESSIONAL MANNER CONSISTENT WITH ALL APPLICABLE INDUSTRY STANDARDS. SYSTEM INSTALLATIONS SHALL CONFORM WITH ALL APPLICABLE INDUSTRY STANDARDS.

8. BEFORE SUBMITTING PROPOSAL THE CONTRACTOR SHALL VISIT AND CAREFULLY EXAMINE THOSE PORTIONS OF THE SITE AND/OR PRESENT BUILDINGS AFFECTED BY THIS WORK SO AS TO FAMILIARIZE THEMSELVES WITH EXISTING CONDITIONS AND THE DIFFICULTIES ASSOCIATED WITH THE EXECUTION OF THE WORK. THESE DIFFICULTIES INCLUDE AVAILABILITY OF THE EQUIPMENT AND MATERIALS. REPORT IN WRITING ANY CONDITIONS WHICH MIGHT ADVERSELY AFFECT THEIR WORK.

9. NO CONSIDERATION OR ADDITIONAL PAYMENTS WILL BE GRANTED FOR ANY ALLEGED MISUNDERSTANDING OF THE MATERIALS TO BE FURNISHED OR WORK TO BE DONE, IT BEING UNDERSTOOD THAT THE SUBMISSION OF A PROPOSAL IS AN AGREEMENT TO ALL CONDITIONS REFERRED TO HEREIN OR INDICATED ON THE PLANS.

10. COORDINATE WITH OWNER AND GENERAL CONTRACTOR SCHEDULING OF ALL WORK SUCH THAT ANY REQUIRED OVERTIME IS INCLUDED AT NO ADDITIONAL COST.

11. PROVIDE THREE SETS OF OPERATION AND MAINTENANCE MANUALS COVERING ALL INSTALLED EQUIPMENT ITEMS TO THE OWNER. THE O&M MANUALS SHALL ALSO INCLUDE AS-BUILT DRAWINGS AND BALANCING REPORT.

12. CONTRACTOR SHALL ENGAGE THE SERVICES OF AN APPROVED TESTING AND BALANCING CONTRACTOR WITH NEBB OR AABC CERTIFICATION. CONTRACTOR SHALL BE RESPONSIBLE FOR MAKING ALL NECESSARY ADJUSTMENTS TO OBTAIN FLOW RATES AS INDICATED ON DRAWINGS. PROVIDE A FINAL TEST REPORT INCLUDING BUT NOT LIMITED TO THE FOLLOWING: CFM, STATIC PRESSURE, COOLING/HEATING COIL DISCHARGE TEMPERATURE, & FINAL FAN RPM.

13. THE CONTRACTOR SHALL LABEL ALL PIPING AND EQUIPMENT.

14. CONTRACTOR SHALL MAKE TESTS AT HIS OWN EXPENSE. AS REQUIRED BY OWNER AND/OR ANY INSPECTION DEPARTMENT. TEST SHALL BE MADE TO VERIFY WHETHER THE SYSTEM AND EQUIPMENT INSTALLED COMPLY WITH THE SPECIFICATIONS AND ARE IN PROPER WORKING ORDER.

15. AS A PART OF THIS CONTRACT, ALL WORK AND EQUIPMENT FURNISHED AND INSTALLED SHALL BE COVERED UNDER A FULL ONE YEAR GUARANTEE. THE WARRANTY SHALL COMMENCE ON THE DATE OF THE OWNER'S FINAL ACCEPTANCE.

16. PROVIDE DIELECTRIC ISOLATORS BETWEEN DISSIMILAR METALS.

17. IT IS NOT INTENDED THAT THE PLANS OR SPECIFICATIONS SHOW OR STATE EVERY DETAILED REQUIREMENT OF THE WORK, BUT RATHER THAT THEY FURNISH ADEQUATE INFORMATION FOR THE CONTRACTOR TO MAKE COMPLETELY APPROVED INSTALLATION.

18. CONTRACTOR SHALL BE RESPONSIBLE FOR REPAIRING OR REPLACING, WITHOUT ADDITIONAL CHARGE, ANY EXISTING WORK DAMAGED BY HIM DURING THE COURSE OF THIS CONSTRUCTION.

19. MECHANICAL CONTRACTOR SHALL PROVIDE NECESSARY CONTROLS AND INSTALLATION OF EQUIPMENT SUPPLIED BY THE UNIT MANUFACTURER TO MEET THE OPERATIONAL REQUIREMENTS OF THE MANUFACTURER SPECIFICATION. THE BAS MANUFACTURER WILL PROVIDE THE CONTROLS AND INSTALLATION REQUIRED TO MEET THE SEQUENCE OF OPERATION. MECHANICAL CONTRACTOR SHALL COORDINATE WITH THE IBS CONTRACTOR TO PROVIDE A COMPLETE FUNCTIONING SYSTEM.

20. CONTRACTOR SHALL LEAVE ALL SYSTEMS IN PROPER WORKING ORDER AND SHALL. WITHOUT ADDITIONAL CHARGE, REPLACE ANY WORK, MATERIALS, OR EQUIPMENT FURNISHED AND INSTALLED BY HIM UNDER HIS CONTRACT WHICH DEVELOPS DEFECTS, EXCEPT FROM ORDINARY WEAR AND TEAR, WITHIN ONE (1) YEAR FROM THE DATE OF FINAL ACCEPTANCE BY THE OWNER.

21. COORDINATE ALL WALL & ROOF PENETRATIONS WITH THE GENERAL CONTRACTOR.

22. ALL CONSTRUCTION DEBRIS SHALL BE DISPOSED OF AS PER THE DIRECTION OF OWNER.

23. THE CONTRACTOR SHALL SUBMIT SHOP DRAWINGS FOR ALL MAJOR MANUFACTURED ITEMS REQUIRED ON THIS PROJECT. A MINIMUM OF 4 COPIES SHALL BE SUBMITTED. PURCHASE OR INSTALLATION OF EQUIPMENT OR SYSTEM COMPONENTS PRIOR TO APPROVAL OF SHOP DRAWINGS IS FORBIDDEN. APPROVAL OF SHOP OR SETTING DRAWINGS SHALL ONLY BE CONSTRUED TO APPLY TO GENERAL LAYOUT AND CONFORMANCE TO THE DESIGN CONCEPT OF THE PROJECT AND FOR COMPLIANCE WITH THE GENERAL REQUIREMENTS OF THE CONTRACT DOCUMENTS. THE RESPONSIBILITY FOR ANY DEVIATION FROM THE REQUIREMENTS OF THE CONTRACT DOCUMENTS SHALL REMAIN THE CONTRACTOR'S UNLESS HE HAS, IN WRITING, SPECIFICALLY CALLED ATTENTION TO SUCH DEVIATIONS AT THE TIME OF SUBMISSION AND HAS RECEIVED WRITTEN APPROVAL OF SUCH DEVIATIONS FROM THE OWNER.

24. CONTRACTOR SHALL PROVIDE PRODUCT DATA INCLUDING INSTALLATION AND STARTUP INSTRUCTIONS FOR ALL EQUIPMENT PROVIDED BY HIM. SUBMITTALS SHALL INCLUDE PERFORMANCE DATA, DETAILED SHOP DRAWINGS, WIRING DIAGRAMS AND MAINTENANCE INSTRUCTIONS.

25. ALL EQUIPMENT SHALL BE INSTALLED IN STRICT COMPLIANCE WITH MANUFACTURERS WRITTEN INSTALLATION INSTRUCTIONS.

26. CONTRACTOR SHALL PROVIDE ALL MISCELLANEOUS STEEL SHAPES, HANGER RODS, STRAPS, ETC. REQUIRED FOR ALL SYSTEM INSTALLATIONS. PROVIDE ALL SEISMIC RESTRAINTS AS REQUIRED BY THE INTERNATIONAL BUILDING CODE.

27. PROVIDE ALL CUTTING AND PATCHING AS REQUIRED. COORDINATE THIS WORK WITH THE GENERAL CONTRACTOR AND/OR CONSTRUCTION MANAGER.

28. SEAL ALL EXTERIOR WALL PENETRATIONS WEATHER TIGHT. PROVIDE FIRE RATED SLEEVES AT ALL FIRE WALL PENETRATIONS AND SEAL AROUND ALL PIPE WITH FIRE STOP SEALANT. COORDINATE PENETRATIONS AND FIRE STOPPING WITH THE GENERAL CONTRACTOR AND/OR CONSTRUCTION MANAGER.

29. AT THE COMPLETION OF CONSTRUCTION, THE CONTRACTOR SHALL PROVIDE TO THE OWNER COMPLETE AND ACCURATE "AS CONSTRUCTED DOCUMENTATION" FOR ALL SYSTEMS INSTALLED OR ALTERED UNDER THIS CONTRACT.

MECHANICAL GENERAL SPECIFICATIONS:

<u>PART 1 – GENERAL</u> <u>GENERAL:</u>

B. THE MECHANICAL CONTRACTOR IS TO COORDINATE WITH OTHER TRADES AND OWNER FOR EQUIPMENT LOCATIONS AND CLEARANCES REQUIRED FOR EQUIPMENT. CONTRACTOR TO COORDINATE AND MODIFY LAYOUT ACCORDINGLY.

C. THE MECHANICAL CONTRACTOR SHALL FURNISH ALL PERMITS, CERTIFICATES, INSPECTIONS, ETC. AND PAY ALL FEES LEVIED BY STATE, LOCAL AND MUNICIPAL AUTHORITIES HAVING JURISDICTION OVER WORK DONE UNDER THIS CONTRACT.

SHOP DRAWING SUBMITTAL:

A. THE CONTRACTOR SHALL SUBMIT, IN A TIMELY MANNER, ALL SUBMITTALS FOR APPROVAL BY THE ENGINEER. UNDER NO CIRCUMSTANCES SHALL THE CONTRACTOR INSTALL ANY MATERIALS UNTIL THE ENGINEER HAS MADE FINAL APPROVAL ON THE SUBMITTALS.

PREPARE COORDINATION DRAWINGS TO A SCALE OF 1/4"=1'-0" OR LARGER, DETAILING MAJOR ELEMENTS. COMPONENTS, AND SYSTEMS OR MECHANICAL EQUIPMENT AND MATERIALS IN RELATIONSHIP WITH OTHER SYSTEMS, INSTALLATIONS, AND BUILDING COMPONENTS.

C. SUBMIT FIVE(5) SETS OF SHOP DRAWING FOR THE FOLLOWING: HVAC EQUIPMENT DIFFUSERS AND FIRE DAMPERS DUCTWORK

COORDINATION:

A. POWER WIRING TO MECHANICAL EQUIPMENT. MOTOR CONTROLLERS AND CONTROL PANELS SHALL BE PROVIDED BY THE ELECTRICAL CONTRACTOR.

B. HVAC CONTROL WIRING SHALL BE PROVIDED BY THE MECHANICAL CONTRACTOR. C. ALL NON-FACTORY FURNISHED MOTOR CONTROLLERS, MOTOR STARTERS AND DISCONNECTS

PROVIDED BY THE MECHANICAL CONTRACTOR. SHALL BE

CONTRACTOR.

PART 2 - PRODUCT

REFER TO BOOK SPECIFICATION.

PART 3 - TESTING, ADJUSTING AND BALANCING A. BEFORE COMMENCING WITH THE BALANCING OF THE EXISTING BUILDING HOT WATER/CHILLED SYSTEM, THE SYSTEM SHALL BE THOROUGHLY LEAK FREE AND ANY AIR PRESENT SHALL BE VENTED AND PURGED.

CLEANING THE AIR SYSTEMS: BEFORE FINAL ADJUSTMENT AND BALANCING, CHEESE CLOTH SHALL BE PLACED OVER EACH DUCT OPENING FOR ENTRAINING PARTICLES DURING THE CLEANING OPERATION. OPERATE ALL SYSTEMS FOR A MINIMUM OF FOUR (4) HOURS. AFTER THIS PERIOD, REMOVE ALL FILTERS. CLEAN ALL SUPPLY DUCTS, GRILLES AND REGISTERS, IN ALL UNITS, USING A VACUUM CLEANER AND BRUSH. FILTERS SHALL BE REPLACED.

BALANCING THE AIR SYSTEMS: OPERATE ALL SYSTEMS FOR AS LONG AS NECESSARY TO TEST AIR FLOW AT ALL OPENINGS. DAMPERS, FANS, AND SHEAVES UNTIL EVEN DISTRIBUTION AND REQUIRED CFM OF AIR ADJUST THROUGHOUT. SUBMIT FOR APPROVAL FOUR (4) TEST REPORTS SHOWING IS OBTAINED ALL PERTINENT OPERATING DATA SUCH AS CFM AND FPM AT EACH OUTLET. FAN RPM, MOTOR CURRENT, ETC., SHALL BE SUBMITTED FOR PERMANENT RECORD. DURING ADJUSTING PERIOD. MAKE ALL NECESSARY SETTINGS AND ADJUSTMENTS OF TEMPERATURE REGULATING EQUIPMENT. TEST REPORTS SHALL BE CERTIFIED BY A NEBB OR AABS LICENSED PROFESSIONAL ENGINEER WHO SHALL BE A MEMBER OF THE BALANCING FIRM.

PERFORMANCE: AIR DISTRIBUTION DEVICES OF MANUFACTURERS OTHER THAN THOSE SCHEDULED SHALL MATCH FEATURES, CAPACITY AND DIMENSIONS OF MODEL NUMBER SCHEDULED. AIR DESIGN, DISTRIBUTION DEVICES SHALL BE SELECTED FOR PROPER THROW WITH A MAXIMUM NC LEVEL OF 35. BALANCE ALL NEW DIFFUSERS TO AIR QUANTITIES INDICATED. ALL DIFFUSERS ARE INDICATED BY A TAG INDICATING THE DIFFUSER MARK, NECK SIZE, AND CFM. DIFFUSERS SHALL BE AS SCHEDULED ON THE MECHANICAL DRAWINGS AND/OR ON THE AIR DISTRIBUTION DEVICE SCHEDULE.

<u>PART 4 – INSTALLATION</u>

EQUIPMENT INSTALLATION:

A. INSTALL EQUIPMENT IN STRICT COMPLIANCE WITH MANUFACTURER'S INSTALLATION INSTRUCTION. B. INSTALL EQUIPMENT IN STRICT COMPLIANCE WITH STATE AND LOCAL CODES AND APPLICABLE

NFPA STANDARDS.

EQUIPMENT.

D. INSTALL COMPONENTS THAT WERE REMOVED FROM EQUIPMENT FOR SHIPPING PURPOSES. E. INSTALL COMPONENTS THAT WERE FURNISHED LOOSE WITH EQUIPMENT FOR FIELD INSTALLATION.

F. PROVIDE ALL ELECTRICAL CONTROL AND POWER INTERCONNECT WIRING.

A. THE MECHANICAL CONTRACTOR SHALL FURNISH ALL LABOR, MATERIALS, TOOLS, TRANSPORTATION, EQUIPMENT, SERVICES AND FACILITIES REQUIRED FOR THE HVAC MODIFICATION WORK AND OTHER MECHANICAL WORK AS SHOWN ON THIS DOCUMENTS. ALL FIXTURES, DEVICES AND EQUIPMENT SHOWN, NOTED OR REQUIRED ON THE DRAWINGS, AND/OR CONTAINED HEREIN SHALL BE FURNISHED, INSTALLED, TESTED AND MADE READY FOR SATISFACTORY OPERATION.

DISCONNECT SWITCHES SHALL BE HEAVY DUTY TYPE WITH LOCKABLE HANDLE. DISCONNECTS FOR ALL ELECTRICALLY DRIVEN HVAC EQUIPMENT SHALL BE PROVIDED BY THE ELECTRICAL

MAINTAIN MANUFACTURER'S RECOMMENDED CLEARANCES AROUND SIDES AND OVER TOP OF

ABBREVIATIONS


| ATC ATC ATM AVG AWG BAS BHP BTU CA CD CFM CHWR CHWR CHWR CHWR CHWR CHWR CHWR CHWR | ELECTRIC DUCT HEATER EXHAUST FAN EFFICIENCY ENTERING EXHAUST REGISTER ELECTRIC REHEAT COIL ENTERING WATER TEMPERATURE EXHAUST EXISTING EXPANSION FAHRENHEIT FACE AREA FLEXIBLE CONNECTION FLOOR DRAIN FIRE DAMPER FULL LOAD AMPS FREEZING POINT FEET PER MINUTE FAN POWERED UNIT FIBERGLASS REINFORCED PLASTIC FIRE AND SMOKE DAMPER FEET GENERAL CONTRACTOR GAGE OR GAUGE GALLONS PER MINUTE HEAT EXCHANGER HORSEPOWER HOT WATER RETURN HOT WATER RETURN HOT WATER SUPPLY | LD LF LWT M.C. MAX MBH MD MECH MIN.C.C. N.O. N.T.O. N.T.O. N.T.O. N.T.O. N.T.O. N.T.O. N.T.O. N.T.O. N.T.O. N.T.O. N.T.O. PC D PEH PRESS PVC RAG RCVR RD PEH PRSI PVC RAG RCVR RECIRC REEV RLA RAG SAG SD SF PT TAD PEG TYP V V V V V V V V V V V V V V V V V V |
|---|---|---|
| GPM HE HP HW HWR | GALLONS PER MINUTE HEAT EXCHANGER HORSEPOWER HOT WATER HOT WATER RETURN HOT WATER SUPPLY HERTZ INCHES KILOWATT | W W/M WB |
| KWH LBS | KILOWATT HOUR POUNDS | |

| | 050 |
|---|------------------|
| LINEAR DIFFU | SER |
| LINEAR FEET | |
| | R TEMPERATURE |
| | |
| MECHANICAL | CUNTRACTOR |
| MAXIMUM | |
| BTU PER HOU | JR (THOUSAND) |
| MOTORIZED D | |
| | |
| MECHANICAL | |
| MECHANICAL | EQUIPMENT ROOM |
| MINIMUM | |
| NORMALLY CL | OSED |
| | |
| NOT IN CONT | |
| NORMALLY OF | |
| NOT TO SCAL | E |
| NOT TO SCAL | RI F |
| | |
| NOISE CRITER | IA |
| OUTSIDE AIR | |
| PUMP | |
| PUMPED CON | DENSATE |
| | |
| PRESSURE DF | |
| | CEILING DIFFUSEF |
| PHASE | |
| PRESSURE | |
| | SOLIADE INOU |
| | SQUARE INCH |
| POLYVINYL CH | |
| REMOVE AND | BLANK OFF |
| RETURN AIR | |
| | |
| RETURN AIR | GRILL |
| RECEIVER | |
| RETURN AIR I | DIFFUSER |
| RECIRCULATE | |
| | |
| REGISTER | |
| REVOLUTIONS | |
| RELATIVE HUN | IIDITY |
| RUNNING LOA | D AMPS |
| | |
| REVOLUTIONS | PER MINULE |
| SUPPLY AIR | |
| SUPPLY AIR I | DIFFUSER |
| SUPPLY AIR | |
| | |
| SUPPLY AIR I | TLUISIER |
| SMOKE DETEC | TOR |
| SMOKE DETEC SUPPLY AIR I SUPPLY FAN | DIFFUSER |
| SUPPLY FAN | |
| STATIC PRESS | |
| | OURE |
| THERMOSTAT | |
| TRANSFER AIF | R DIFFUSER |
| TEMPERATURE | |
| | |
| TRANSFER GR | |
| TYPICAL | |
| UNLESS OTHE | RWISE NOTED |
| VOLT | |
| | |
| VENT | |
| VARIABLE AIR | VOLUME |
| VOLUME DAM | |
| VELOCITY | |
| | |
| VOLUME | |
| WATT | |
| WASTE | |
| WIRE MESH | |
| | |
| WET BULB | |
| WEIGHT | |
| | |
| | |

HVAC SYMBOL LEGEND

| (#) | DEMOLITION WORK NOTES |
|--|--|
| $\overline{\langle\!\!\!\!\!\!\!\!\!\rangle}$ | PROPOSED WORK NOTES |
| | SUPPLY AIR DUCT |
| | RETURN AIR DUCT |
| \boxtimes | NEW AIR DIFFUSER |
| | EXISTING AIR DIFFUSER |
| | 2-WAY AIR DIFFUSER |
| | 2-WAY AIR DIFFUSER |
| | EXISTING SUPPLY AIR DIFFUSER TO BE REMOVED |
| | NEW RETURN AIR REGISTER |
| | NEW CONNECTION |
| | THERMOSTAT (T-STAT) |
| ₽ <u></u> //////////////////////////////////// | EXISTING TO REMAIN |
| | EXISTING TO BE REMOVED |
| | NEW WORK |
| ر | PIPE DROP |
| \sim | FLEXIBLE DUCT |
| (D) | FIRE ALARM SYSTEM DUCT MOUNTED PHOTOELECTRIC SMOKE DETECTOR. FURNISHED AND INSTALLED BY ELECTRICAL CONTRACTOR. |
| | POINT OF TERMINATION |
| • | FIRE DAMPER |
| L | VOLUME DAMPER |
| 下 人 | 3 WAY VALVE |
| ıбı | BALL VALVE |
| | CIRCUIT BALANCING VALVE |
| | |

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|---|---|
| | Massimo Francis Yezzi, Jr.Architect No. C 7475-NJPlanner No. 2368-NJArchitect No. 39914-NCARBArchitect No. 30262377-AIADaniel M. SernottiArchitect No. 21Al01897900-NJArchitect No. S5-0008349-DEArchitect No. RA 015346-GA |
| | Architect No. 73872 – NCARB |
| | MATTHEW DAVID WELLS, N.J.P.E. PROFESSIONAL ENGINEER, LIC. NO. 24GE04594000 |
| | PROPOSED RENOVATIONS TO STOCKTON UNIVERSITY TOWNSEND RESIDENTIAL LIFE CENTER 101 VERA KING FARRIS DR. GALLOWAY ATLANTIC COUNTY NEW JERSEY |
| struction. | Issued for Bid |
| to start of construction. | March 12, 2021 Revisions By Date |
| Field check all dimensions prior to sta | |
| all dimer. | Sheet Title MECHANICAL COVERSHEET |
| | Drawn By IO Chk'd By 21 |
| Not Scale Drawings — | Sheet No. $M-O$ |
| oN oQ work. | Project No. YC20122 |

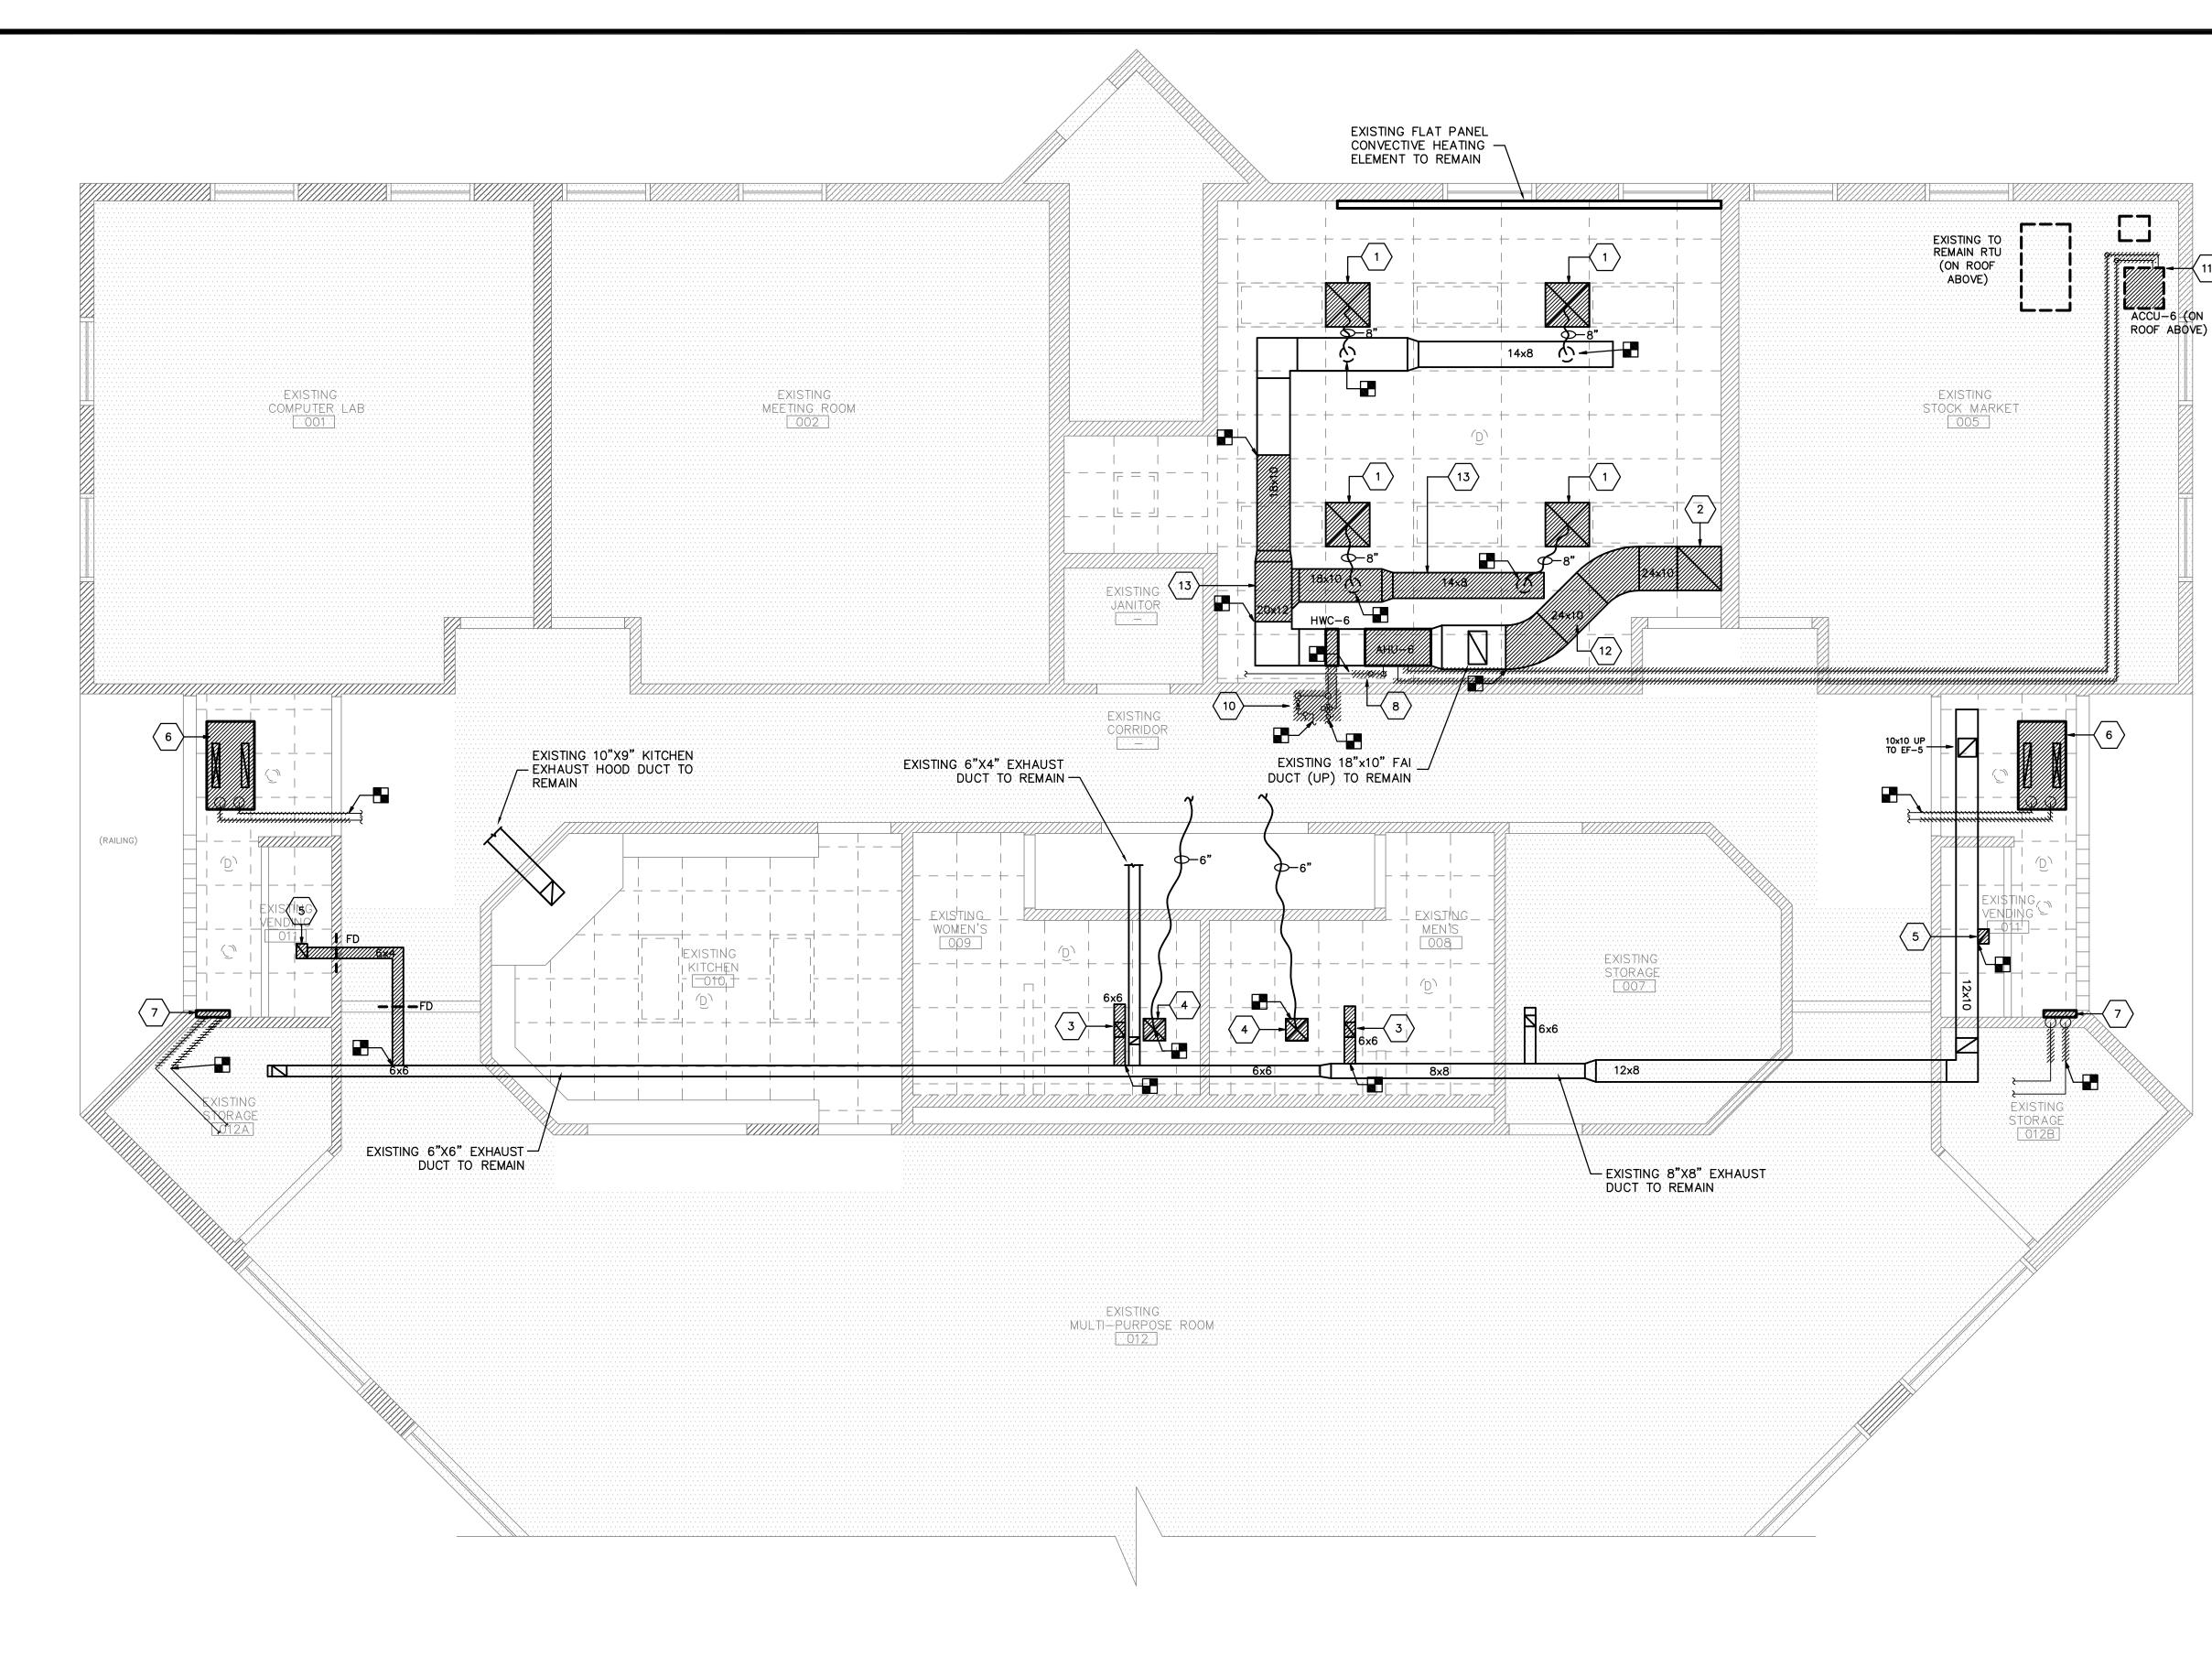


(1) MECHANICAL DEMOLITION WORK PLANM-1) SCALE: 1/4" = 1'-0"

DEMOLITION WORK NOTES

- 1 REMOVE EXISTING CEILING DIFFUSER AND INSULATED FLEX DUCT RUN-OUT. PATCH BOTTOM TAKE-OFF ON RECTANGULAR DUCT BRANCH.
- 2 REMOVE EXISTING 24" x 24" RETURN AIR FILTER GRILLE.
- $\overline{3}$ REMOVE EXISTING 8" x 6" EXHAUST AIR GRILLE.
- 4 REMOVE EXISTING 12" x 12" SUPPLY AIR DIFFUSER EXISTING 6" INSULATED FLEX DUCT RUN-OUT TO REMAIN.
- 5 REMOVE 6" x 6" EXHAUST AIR GRILLE AND 6"x 4" EXHAUST DUCT BRANCH. CAP EXISTING EXHAUST DUCT WHERE INDICATED AT BRANCH TAKE-OFF.
- 6 REMOVE EXISTING HYDRONIC CABINET UNIT HEATER INCLUDING UNIT CHASSIS, SUPPORTS, SUPPLY AND RETURN HOT WATER PIPING AND SERVICE VALVES. TERMINATE PIPING INSIDE BUILDING ENVELOPE WITH NEW ISOLATION VALVES, PIPE NIPPLES AND CAPS.
- 7 REMOVE EXISTING FLAT PANEL HOT WATER RADIATOR AND SUPPORTS. TERMINATE SUPPLY AND RETURN HOT WATER PIPING INSIDE BUILDING ENVELOPE WITH NEW ISOLATION VALVES, PIPE NIPPLES AND CAPS.
- $\langle 8 \rangle$ REMOVE EXISTING CONDENSATE DRAIN TRAP.
- 9 REMOVE EXISTING AIR HANDLING UNIT AND EXISTING REFRIGERANT PIPING UP TO AIR COOLED CONDENSING UNIT ON ROOF.
- (10) REMOVE EXISTING HOT WATER COIL AND PIPING INCLUDING CIRCUIT BALANCING VALVE AND THREE WAY CONTROL VALVE.
- (11) REMOVE EXISTING AIR COOLED CONDENSING (HEAT PUMP) UNIT ON ROOF. RECLAIM AND RECYCLE THE REFRIGERANT FROM THIS SYSTEM.
- 12 REMOVE PORTION OF RETURN AIR DUCT SHOWN. REMOVE RETURN AIR DAMPER, FRESH AIR INTAKE DAMPER, AND ASSOCIATED DAMPER ACTUATORS. REMOVE 12" FLEXIBLE RELIEF AIR INTAKE DUCT. REMOVE EXISTING DUCT MOUNTED RETURN AIR AND MIXED AIR TEMPERATURE SENSORS.
- $\langle 13 \rangle$ REMOVE PORTIONS OF SUPPLY AIR DUCTWORK AS SHOWN.

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|--|---|
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| | Architect No. C 7475 -NJ Planner No. 2368 -NJ Architect No. 39914 -NCARB Architect No. 30262377 -AIA Daniel M. Sernotti Architect No. 21AI01897900-NJ Architect No. S5-0008349 -DE Architect No. RA 015346 -GA Architect No. 73872 -NCARB |
| | HIGHLAND RESOURCE GROUP, LLC. 130 BORTONS ROAD, MARLTON, NJ 08053 WWW.HRGNJ.COM, V.S56-404-0572, F.S66-627-7886 CERTIFICATE OF AUTHORIZATION: #24GA28138200 MATTHEW DAVID WELLS, N.J.P.E. |
| | PROFESSIONAL ENGINEER, LIC. NO. 24GE04594000 SIGNATURE NOT VALID DATE WITHOUT RAISED SEAL |
| | PROPOSED RENOVATIONS TO STOCKTON UNIVERSITY TOWNSEND RESIDENTIAL LIFE CENTER 101 VERA KING FARRIS DR. GALLOWAY ATLANTIC COUNTY NEW JERSEY |
| ıstruction. | L O L Issued for Bid |
| dimensions prior to start of construction. | March 12, 2021 Revisions By Date |
| Field check all | Sheet Title MECHANICAL DEMOLITION WORK PLAN Drawn By II Chk'd By 21 |
| . Do Not Scale Drawings - | Sheet No. M — 1 Project No. YC20122 |

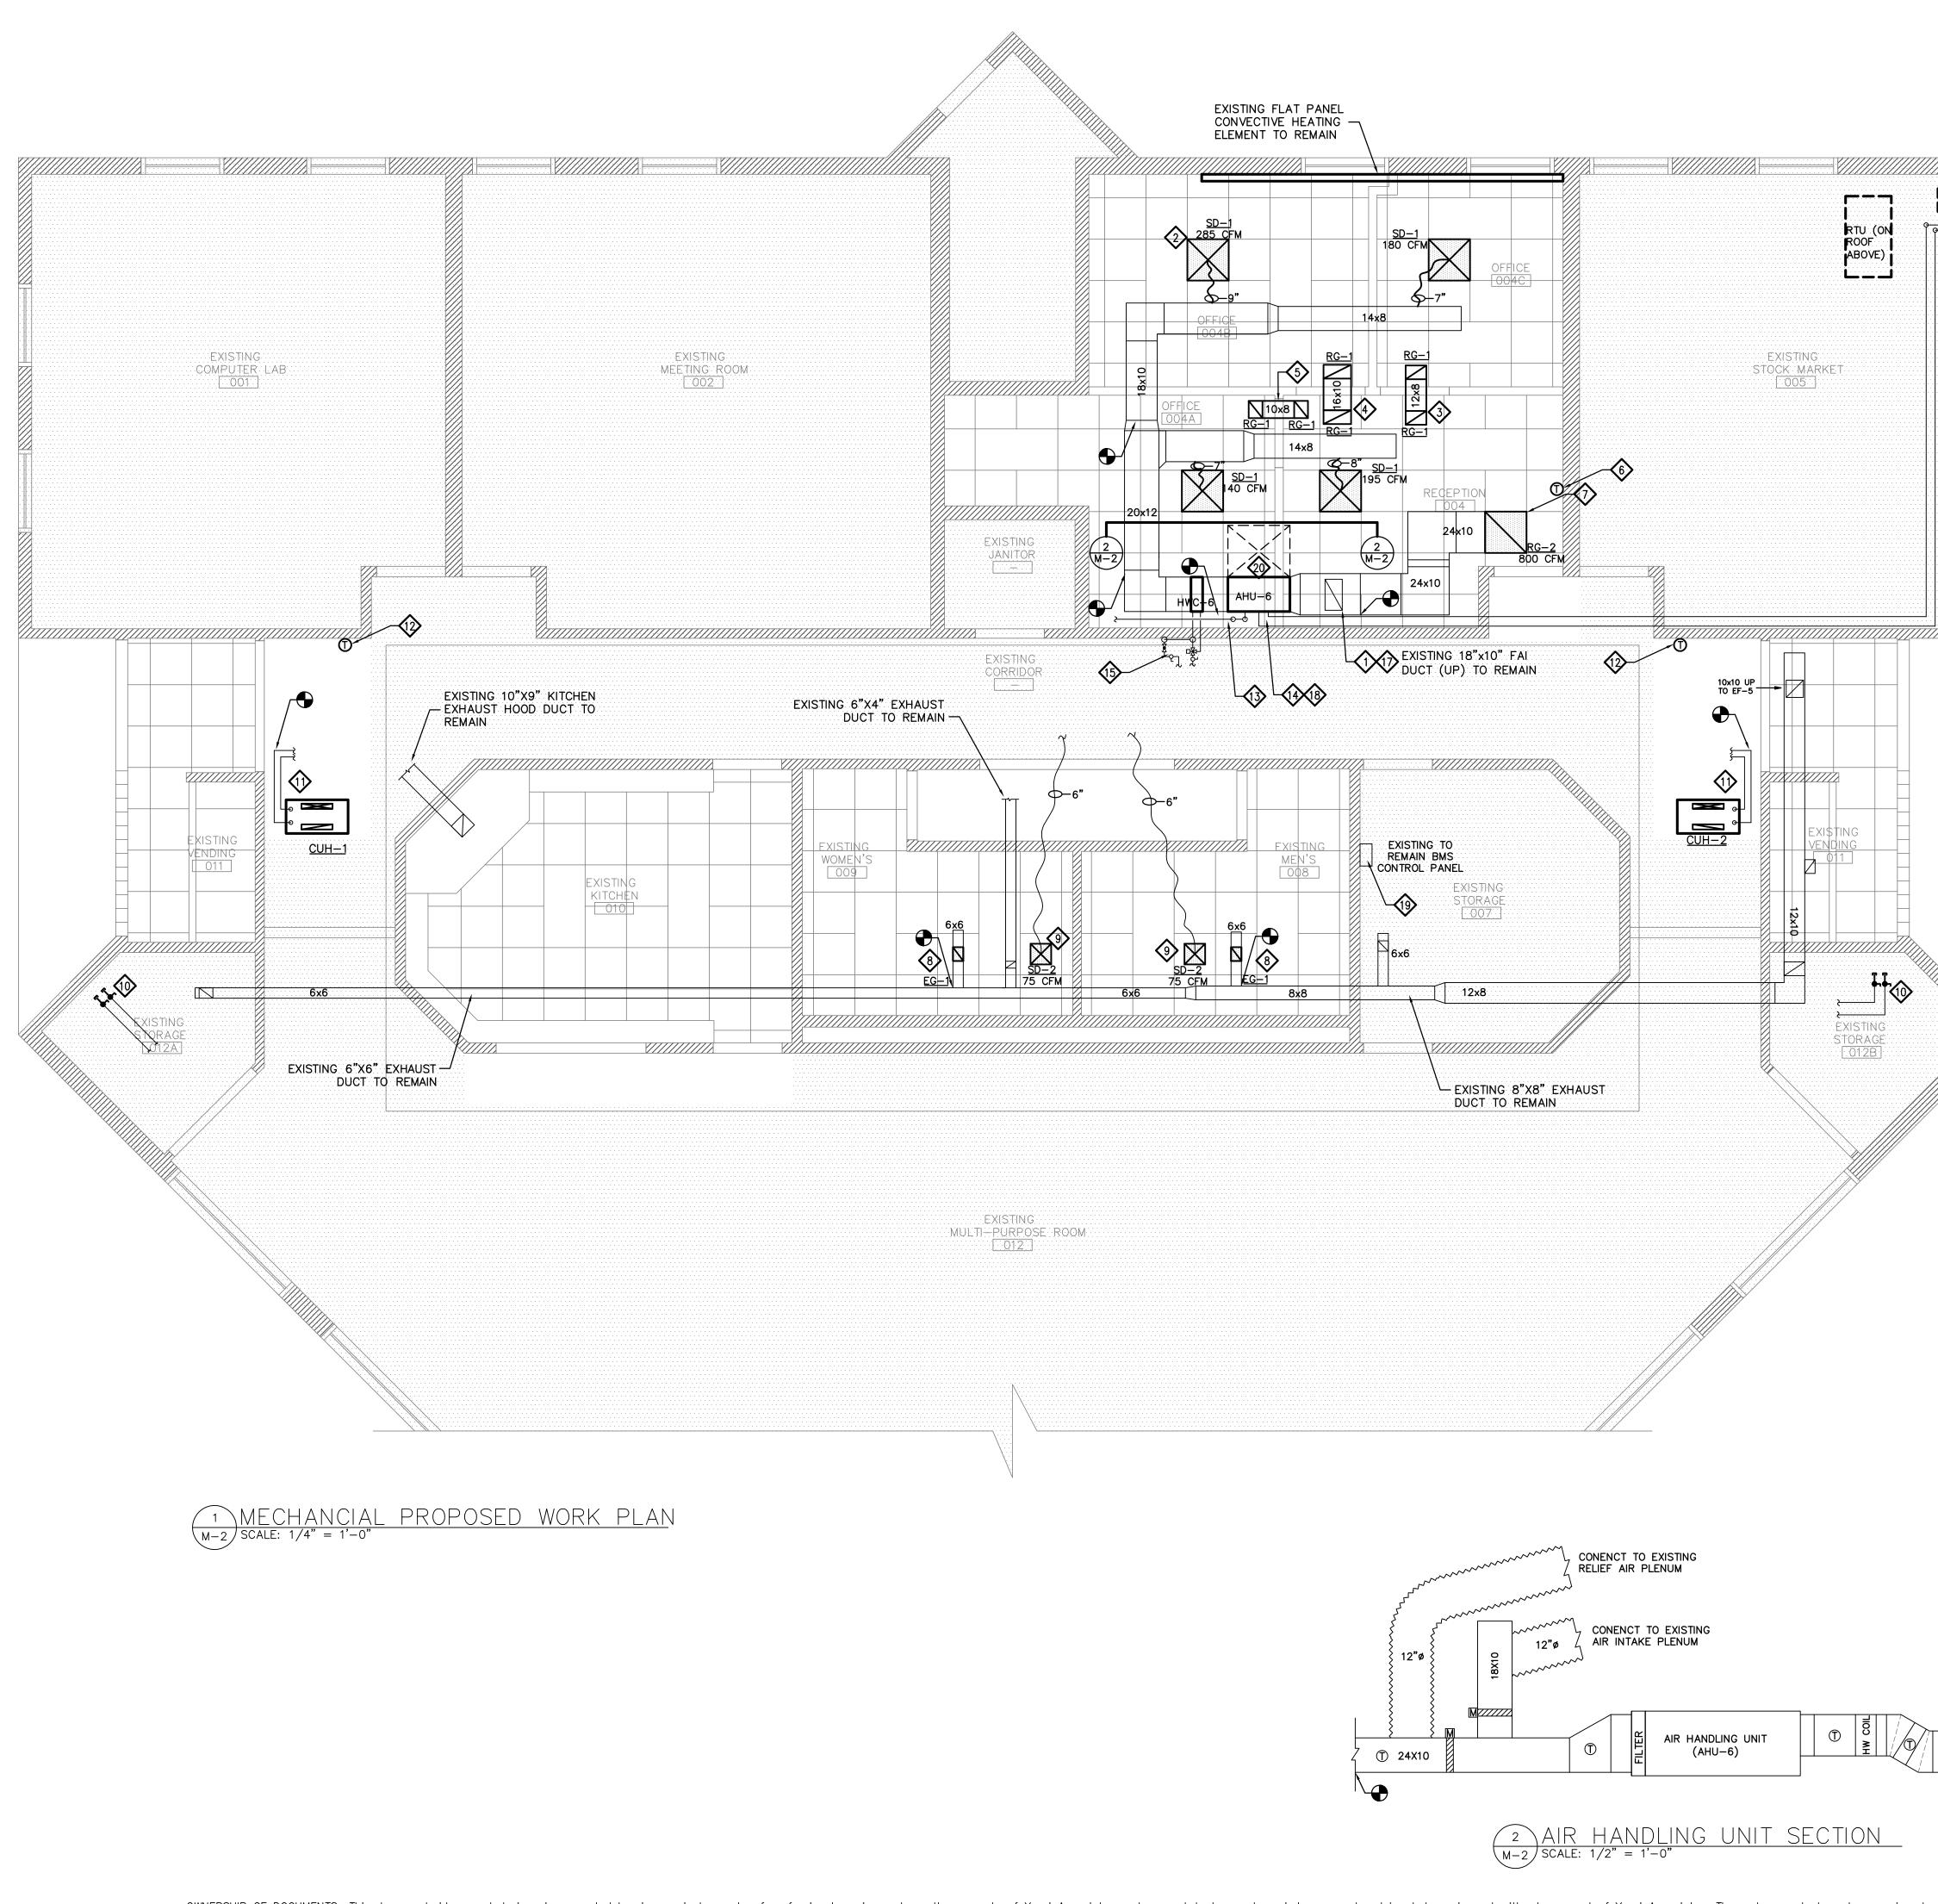


PROPOSED WORK NOTES

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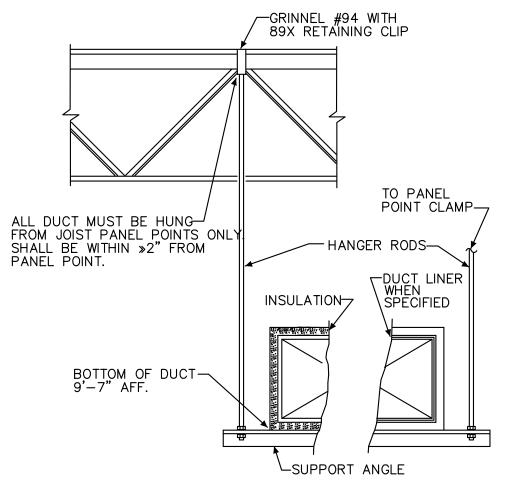
ACCU-6 (ON ROOF ABOVE)

- INSTALL NEW 12"Ø FLEXIBLE RELIEF AIR DUCT AND 12"Ø FLEXIBLE FRESH AIR INTAKE DUCT. ADJUST OUTDOOR AIR DAMPER AND RELIEF AIR DAMPER TO MINIMUM POSITIONS TO ACHIEVE 145CFM (APPROXIMATELY 18%) OUTDOOR AIR FLOW RATE.
- INSTALL NEW BELLMOUTH DUCT TAKE-OFF FITTING WITH MANUAL VOLUME DAMPER, INSULATED (R-8) FLEX DUCT RUN-OUT, AND 2X2, FOUR-WAY BLOW, CEILING DIFFUSER (TYP FOR 4).
- (3) INSTALL 12X8 TRANSFER AIR DUCT WITH INTERNAL ACOUSTICAL LINER AND 12X8 RETURN AIR GRILLE (BOTH SIDES).
- INSTALL 20X8 TRANSFER AIR DUCT WITH INTERNAL ACOUSTICAL LINER AND 12X8 RETURN AIR GRILLE (BOTH SIDES).
- (5) INSTALL 10X8 TRANSFER AIR DUCT WITH INTERNAL ACOUSTICAL LINER AND 12X8 RETURN AIR GRILLE (BOTH SIDES).
- (6) INSTALL NEW 24V TRANE ROOM TEMPERATURE SENSOR.
- INSTALL NEW 24X24 RETURN AIR GRILLE. ATTACH TO EXTENDED RETURN AIR DUCT.
- NSTALL NEW 8X6 EXHAUST AIR GRILLE TO RELOCATED 6X6 EXHAUST DUCT BRANCH. CONNECT EXISTING EXHAUST DUCT. ADJUST EXISTING MANUAL VOLUME DAMPERS TO ACHIEVE 100 CFM CONTINUOUS AIRFLOW RATE.
- INSTALL NEW 12X12, 4-WAY BLOW CEILING DIFFUSER. ATTACH EXISTING 6" FLEX DUCT RUN-OUT TO NEW CEILING DIFFUSER. ADJUST TO EXISTING MANUAL VOLUME DAMPERS TO ACHIEVE 75 CFM SUPPLY AIR FLOW RATE.
- (1) INSTALL NEW BALL VALVE, PIPE NIPPLE, AND CAP ON EXISTING HHW SUPPLY AND RETURN PIPING TO PERMANENTLY CAP PIPING WHERE FLAT PANEL RADIATOR WAS REMOVED UNDER THE SCOPE OF THE DEMOLITION WORK.
- INSTALL NEW HYDRONIC CABINET UNIT HEATER. EXTEND THE 3/4" HHW SUPPLY AND RETURN PIPING AND CONNECT TO NEW UNIT HEATER. PROVIDE NEW BALL VALVES (ISOLATION DUTY) IN THE SUPPLY AND RETURN LINES AND A NEW CIRCUIT BALANCING VALVE IN THE SUPPLY LINE. PROVIDE WATER-SIDE BALANCING TO ACHIEVE 3.0 GPM THROUGH THE UNIT HEATER COIL.
- PROVIDE NEW 24V TRANE ROOM TEMPERATURE SENSOR. PROVIDE NEW 40VA, 120/24V CONTROL TRANSFORMER AND PILOT DUTY RELAY (CONTACTS RATED AT 10A, 24 VOLT HOLDING COIL AND HOA SWITCH). PROVIDE NEW TRANE TRACER SC SYSTEM UC400 CONTROLLER AND INTEGRATE INTO EXISTING BMS SYSTEM. PROVIDE CONTROL WIRING TO ENERGIZE/DE-ENERGIZE THE BLOWER IN THE CABINET HEATER.
- (13) INSTALL NEW CONDENSATE DRAIN TRAP AND CONNECT TO EXISTING CONDENSATE DRAIN PIPING.
- INSTALL NEW AIR HANDLING UNIT AND NEW 3/8" X 3/4" REFRIGERANT PIPING UP TO AIR COOLED CONDENSING UNIT ON ROOF.
- (15) INSTALL NEW HOT WATER COIL AND NEW 3/4" HOT WATER PIPING INCLUDING CIRCUIT BALANCING VALVE AND MODULATING THREE WAY CONTROL VALVE AND CONNECT TO EXISTING HOT WATER PIPING.
- INSTALL NEW AIR COOLED CONDENSING UNIT ON ROOF. PROVIDE PATE RAILS AND ROOF PADS FOR SUPPORT.
- INSTALL 24X10 RETURN AIR DAMPER AND 18X10 OUTDOOR AIR INTAKE DAMPER INCLUDING NEW 24V ACTUATORS.
- INSTALL DUCT-MOUNTED TEMPERATURE SENSORS FOR RETURN AIR, MIXED AIR, DISCHARGE AIR (DOWNSTREAM OF AHU-6) AND SUPPLY AIR (DOWNSTREAM OF HWC-6).
- PROVIDE TRANE TRACER SC SYSTEM UC400 CONTROLLER IN AHU-6 AND INTEGRATE INTO THE EXISTING BMS SYSTEM. PROVIDE CONTROL WIRING AND ACCESSORIES FOR ACCU-6, RA/FAI DAMPER ACTUATOR, HWC-6 VALVE ACTUATOR, AND DUCT-MOUNTED TEMPERATURE SENSORS TO THE UC400 CONTROLLER.
- INSTALL AHU-6 SO THAT ALL ACCESS FOR SERVICE AND MAINTENANCE IS FROM THE "ROOM SIDE" OF THE UNIT. MAINTAIN AT LEAST 30" OF CLEAR SPACE IN FRONT OF UNIT FOR FILTER CHANGES, SERVICE AND MAINTENANCE.

| · Do Not Scale Drawings - | 1gs - Field check all | Field check all dimensions prior to start of construction. | t of cor | instructio | on. | | | | | | |
|---------------------------------|---|--|-------------------------------------|----------------|--|--|--|---|---|---|------------------|
| M — 2 Project No. YC20122 | Drawn By I2 Chk'd By Sheet No. | Sheet Title MECHANICAL PROPOSED WORK PLANS | March 12, 2021 Revisions By Date | Issued for Bid | Project Proposed renovations to STOCKTON UNIVERSITY TOWNSEND RESIDENTIAL LIFE CENTER 101 VERA KING FARRIS DR. GALLOWAY ATLANTIC COUNTY NEW JERSEY | MATTHEW DAVID WELLS, N.J.P.E. PROFESSIONAL ENGINEER, LIC. NO. 24GE04594000 | HIGHLAND RESOURCE GROUP, LLC. 130 BORTONS ROAD, MARLTON, NJ 08053 WWW.HRGNJ.COM, V.S66-404-0572, F.856-627-7886 CERTIFICATE OF AUTHORIZATION: #24GA28138200 | Daniel M. Sernotti Architect No. 21AI01897900-NJ Architect No. S5-0008349-DE Architect No. RA 015346-GA Architect No. 73872-NCARB | Massimo Francis Yezzi, Jr. Architect No. C 7475 — NJ Planner No. 2368 — NJ Architect No. 39914 — NCARB Architect No. 30262377 — AIA | ARCHITECTURE PLANNING ENGINEERING INTERIORS MANAGEMENT 18 Washington Street P.O. Box 1638 Toms River, N.J. 08754 Tel: 732-240-3433 Fax: 732-240-3463 E-mail: info@yezziassociates.com Website: www.yezziassociates.com | YEZZI ASSOCIATES |

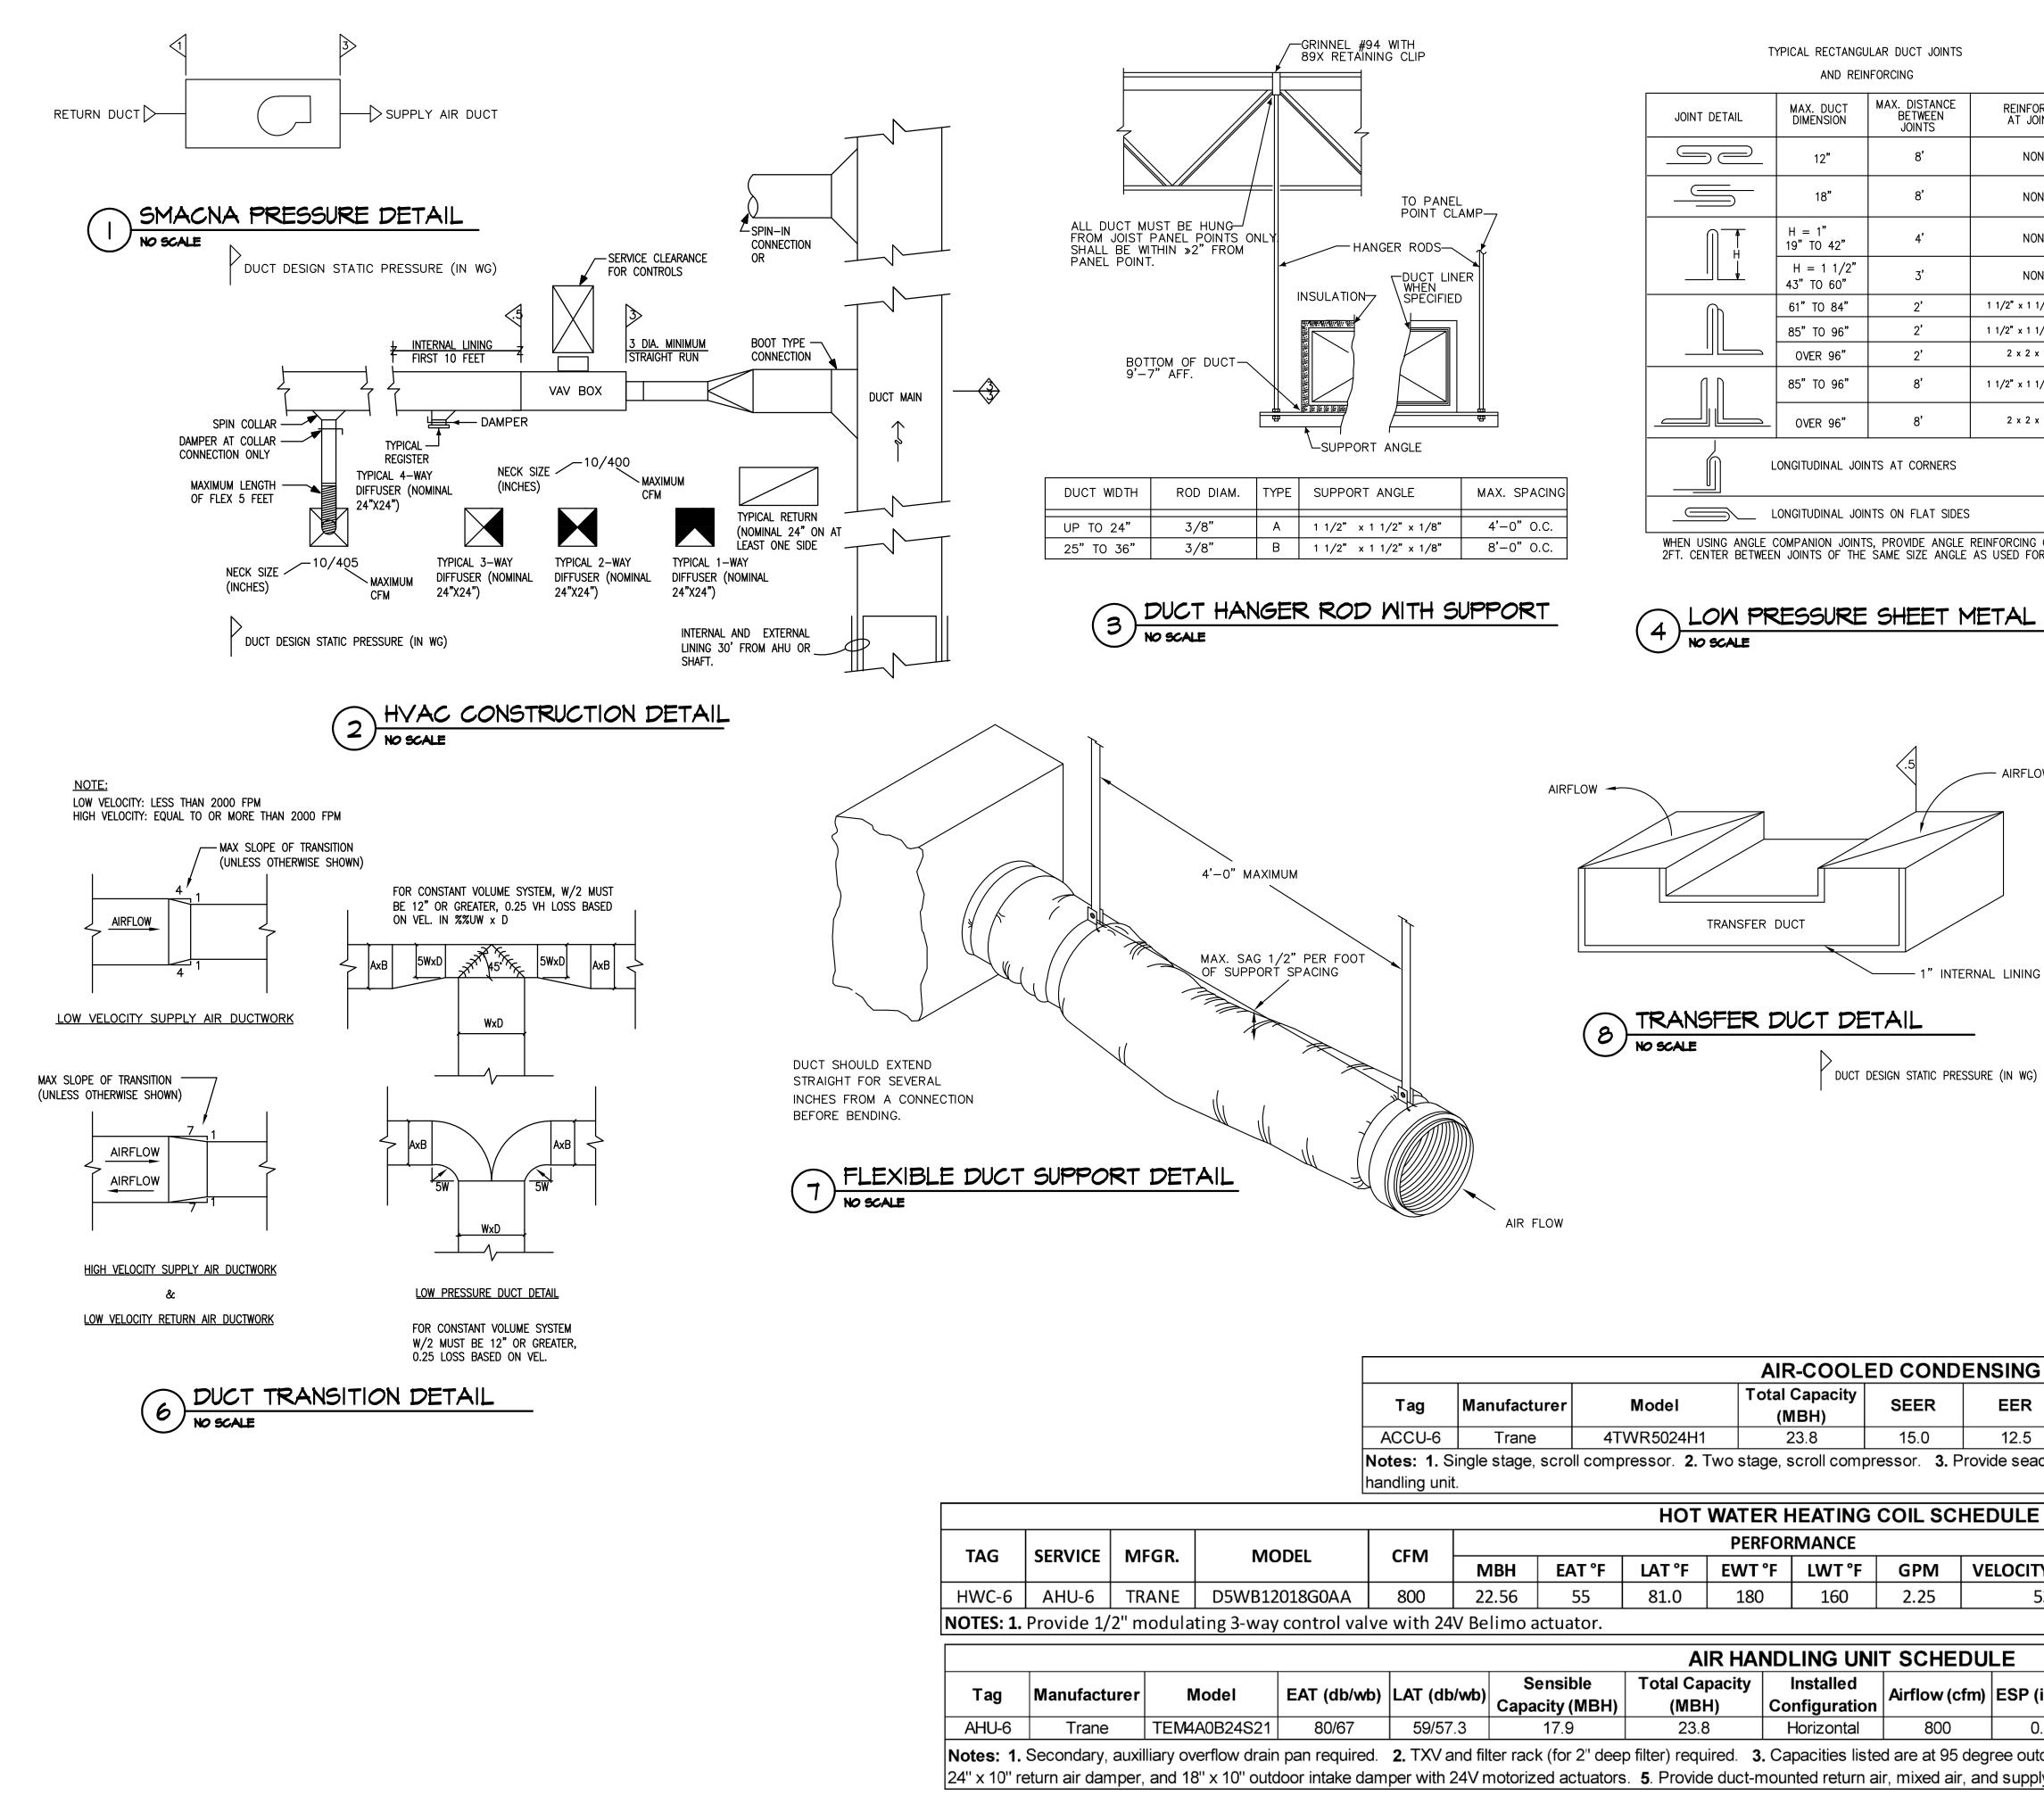

| Tag |
|-------|
| CUH-1 |
| CUH-2 |



| DUCT WIDTH | ROD DIAM. | TYPE | SUPPORT ANGLE | MAX. SPACING |
|------------|-----------|------|------------------------|--------------|
| UP TO 24" | 3/8" | A | 1 1/2" x 1 1/2" x 1/8" | 4'-0" O.C. |
| 25" TO 36" | 3/8" | В | 1 1/2" x 1 1/2" x 1/8" | 8'-0" O.C. |

| | TYPICAL RECTANG | ULAR DUCT JOINTS | | | | | | | | | | |
|--|-------------------------------------|--|--|--------------------------------|------------------|-------------------------------|---------------------|--------------------------|--|-----------------------|------------|--|
| | AND REI | NFORCING | | | | | | 22 . 22 | <u> </u> | 7 | | |
| JOINT DETAIL | MAX. DUCT DIMENSION | MAX. DISTANCE BETWEEN JOINTS | REINFORCING AT JOINTS | | | DUCT S | | "A" FLAT BAR | "B" ROD DIA. | = | | |
| | 12" | 8' | NONE | | | UP TO | | 1" × 1 /8" 1" × 1 /8" | 3 /8" | - | | |
| | 18" | 8' | NONE | | | 42" ANI | | 1 /2" x 3 /16" | 3 /8" | - | | |
| | H = 1" 19" TO 42" | 4' | NONE | | | | | | | | | |
| | H = 1 1/2" | 3' | NONE | | | \uparrow | | Υ | | | Γ | |
| | 43" TO 60" 61" TO 84" | 2' | 1 1/2" x 1 1/2" x 1/8" | | | ⊸ "₿" | | | "В" "Е | 3 ²² | | |
| | 85" TO 96" OVER 96" | 2' 2' | 1 1/2" x 1 1/2" x 3/16 2 x 2 x 1/4" | , | | ரீ பிடி——— | | (- " | ^" ـــر | 27 | | |
| []]] | 85" TO 96" | 8' | 1 1/2" x 1 1/2" x 3/16 | " | | | Ť | /2" | | | | |
| | OVER 96" | 8' | 2 x 2 x 1/4" | _ | | Ň | \\``^ | A" // | | | | |
| | LONGITUDINAL JOI | | | _ | | | | | | | | YEZZI ASSOCIATES |
| | LONGITODINAL JOI | NTS AT CORNERS | | _ | | | // | 2 1/ | | | A | ARCHITECTURE Planning engineering |
| | | INTS ON FLAT SIDES | | | | | | | | | | INTERIORS MANAGEMENT |
| WHEN USING ANGLE 2FT. CENTER BETWE | COMPANION JOINT EN JOINTS OF THE | TS, PROVIDE ANGLE E SAME SIZE ANGLE | REINFORCING ON AS USED FOR JOINT | | SUP | PORT FOR ROU UP TO 24" DIA | ND DUC ⁻ | TS SI | JPPORT FOR ROUND 25" DIA. AND LAR | DUCTS GER | | 18 Washington Street P.O. Box 1638 Toms River, N.J. 08754 |
| | | | | | | | | | | | 1 | Tel: 732-240-3433 Fax: 732-240-3463 E-mail: info@yezziassociates.com |
| 4 LOW P | RESSURE | SHEET N | IETAL DUC | TWORK | <u><</u> | | VIND | DRK HAN DUCTWO | IGER DRK) | | | Website: www.ýezziassociates.com |
| | | | | | | | | | | | Ai Pl | assimo Francis Yezzi, Jr. rchitect No. C 7475 −NJ Ianner No. 2368 −NJ |
| | | | | | | | | | | | An An | rchitect No. 39914 —NCARB rchitect No. 30262377 —AIA |
| | | 1 | | | | | | | | | Ar | <mark>aniel M. Sernotti</mark> chitect No. 21AI01897900-NJ chitect No. S5-0008349 -DE |
| | | .5 | AIRFLOW | | | | | | | | Ar | chitect No. SS=0008349 -DE chitect No. RA 015346 -GA chitect No. 73872 -NCARB |
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| | | | | | | | | | | | | HIGHLAND RESOURCE GROUP, LLC. 130 BORTONS ROAD, MARLTON, NJ 08053 WW.HRGNJ.COM, V.856-404-0572, F.856-627-7886 ENTIFICATE OF AUTHORIZATION: #24GA28138200 |
| TRANSFER | DUCT | | | | | | | | | | | ATTHEW DAVID WELLS, N.J.P.E. |
| | | | | | | | | | | | | PROFESSIONAL ENGINEER, LIC. NO. 4GE04594000 |
| | Ň | 1" INTEF | RNAL LINING | | | | | | | | | |
| TRANSFER | DUCT DE | TAIL | _ | | | | | | | | Ē | IGNATURE NOT VALID DATE |
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| HYDRONIC CAI | | | | | | | | | | | | 21 |
| W GPM Water) GPM PD (Ft.) | Coil Fins | | Blower Dia | otor Type | Motor Hp | Electrica (V/Ph/Hz | I IV | |) Dimensions (WxLxH) | Applicable Notes | awi | Sheet No. |
| 3.0 0.55 | 12 | 1.5 | 5.75 x 7 | ECM | 1/15 | 120/1/60 |) (| 0.6 15 | 26" x 43" x 9.5 | 5" 1,2,3 | cale Dr | |
| 3.0 0.55 | 12 | 1.5 | 5.75 x 7 | ECM | 1/15 | 120/1/60 | | 0.6 15 | 26" x 43" x 9. | 5" 1,2,3 | Sc | M - 3 |

Project No.

YC20122

| EL #94 WITH RETAINING CLIP | 1 | YPICAL RECTANGULAR | | | | | | | | | | | | | | | |
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| | JOINT DETAIL | AND REINFOR MAX. DUCT MA DIMENSION | CING X. DISTANCE BETWEEN | REINFORCING AT JOINTS | ; | | DUC | CT SIZE | Å" FLAT B | BAR | "B" ROD DIA. | | | | | | |
| | | DIMENSION 12" | JOINTS 8' | AT JOINTS NONE | | | | TO 24" | 1" × 1 | /8" | 3 /8" | | | | | | |
| | | 18" | 8' | NONE | | | | ' TO 41" ' AND UP | 1" × 1 1 1 /2" × 3 | | 3 /8" 1 /2" | - | | | | | |
| HANGER RODS | | H = 1" 19" TO 42" | 4' | NONE | | | L | | 1 | <u> </u> | , | | | ━┲╴ | | | |
| TION SPECIFIED | | H = 1 1/2" 43" TO 60" | 3' | NONE | | | | "B" | / | Т"в" | 97 | в <u>"</u> | | | | | |
| | | 61" TO 84" 85" TO 96" | 2' 2' | 1 1/2" x 1 1/2" x 1 1/2" x 1 1/2" x | | | | ļ | | | " | A" | | | | Χ | |
| | | OVER 96" 85" TO 96" | 2' 8' | 2 x 2 x 1/4" 1 1/2" x 1 1/2" x 3 | 3/16" | | | | 1 /2" | | | | | | _ | | |
| | | OVER 96" | 8' | 2 x 2 x 1/4" | | | | | -"A" | | | | | | γf771 Δ' | SSOCIATES | |
| PPORT ANGLE | | LONGITUDINAL JOINTS . | AT CORNERS | | | | ` | | | Ŧ | | | | | ARCHITEC | TURE | - |
| PORT ANGLE MAX. SPACING '2" x 1 1/2" x 1/8" 4'-0" O.C. | | LONGITUDINAL JOINTS | ON FLAT SIDES | | | | | | 2 | 1/_2 | | <u> </u> | _ | | | G NEERING INTERIORS MANAGEMENT | |
| $2^{2} \times 1 \frac{1}{2^{2}} \times \frac{1}{8^{3}} = \frac{1}{8^{2}} = \frac{1}{2^{2}} = \frac{1}$ | WHEN USING ANGLE 2FT. CENTER BETWEE | COMPANION JOINTS, PI IN JOINTS OF THE SAM | ROVIDE ANGLE F IE SIZE ANGLE | REINFORCING ON AS USED FOR JOII | NT | SUF | PPORT FOR UP TO 24" | ROUND DU DIA. | ICTS | SUPPOF 25" | RT FOR ROUNE DIA. AND LAF | DUCTS RGER | | | | gton Street ox 1638 , N.J. 08754 | |
| OD WITH SUPPORT | | RESSURE S | HEET M | | UCTWO | RK | ľ | DUCTM | IORK H | IANGE | R | | | Ę | -Fax: 732 E-mail: info@ye | -240-3433 -240-3463 zziassociates.com zziassociates.com | |
| (| 4 NO SCALE | | | | | | | ROUND 10 SCALE | DUCT | WORK | <) | | | A | lassimo Fran e Architect No. C | 7475 – NJ | |
| | | | | | | | - | | | | | | | PI | Planner No. 23 wrchitect No. 3 wrchitect No. 3 | 368 – NJ 39914 – NCARB | |
| | | | _1 | | | | | | | | | | | Ar Ar | rchitect No. S | 21AI01897900-N 55-0008349 -D | |
| AIRFLOW - | | | (.5 | - AIRFLOW | | | | | | | | | | Ar | rchitect No. R | RA 015346 –G, 73872 –NCARI | |
| | 1 | | | | | | | | | | | | | | H | K | |
| | | | \square | | | | | | | | | | | w | 130 BORTONS ROA VWW.HRGNJ.COM, V.85 | DURCE GROUP, LLC. AD, MARLTON, NJ 08053 56-404-0572, F.856-627-788 ORIZATION: #24GA2813820 | í. |
| | TRANSFER | DUCT | | | | | | | | | | | | N | | ID WELLS, N.J.P.E | |
| FOOT | | | 1" INTER | NAL LINING | | | | | | | | | | 2 | 4GE04594000 | | |
| | RANSFER | | AIL | | | | | | | | | | | - | | DATE | |
| | o scale | | GN STATIC PRESS | URE (IN WG) | | | | | | | | | | | SIGNATURE NOT VALID WITHOUT RAISED SEAL | | 1 |
| | | Ι | | 、 <i>,</i> | | | | | | | | | | | | | L |
| | | | | | | | | | | | | | | | |)EN ITAL R galloway new jersey | |
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| AIR FLOW | | | | | | | | | | | | | | | | ENTE S Br. | L |
| | | | | | | | | | | | | | | | ED RENG | CEN Farris NTY | |
| | | | | | | | | | | | | | | | | SENL LIFE Ra king Tic coun | |
| | Tot | IR-COOLED | | | | / | | | | . | | Apr | plicable | | STOC | | |
| | odel 700 35024H1 | (MBH) 23.8 | SEER 15.0 | EER 12.5 | 47°F 3.6 | | n/Hz) | MCA 14 | MOPD 25 | | 32.5" x 32.75 | H) N | Notes 1,3,4 | | Ω F | <u> </u> | |
| Notes: 1. Single stage, scroll compres handling unit. | sor. 2. Two stage | e, scroll compres | sor. 3. Pro | ovide seacost | t kit. 4. Lis | sted SEER, EE | R, and C | OP are at | AHRI ratin | | | I | | stion. Deniant | 12022 | | |
| | | | OIL SCH | EDULE | | | | | | | | | | construc | Issued for Bid March | 12, 2021 | 1 |
| CFM MBH EAT °F L | PERF AT °F EWT °I | ORMANCE F LWT °F | GPM | VELOCITY (f | t/min) | APD (in. wc) | WPD (f | t. H2O) | ROWS | FIN SP/ (fp | | SIZE NXH | NOTES | tart of | Revisions By | Date | 1 |
| A 800 22.56 55 Valve with 24V Belimo actuator. | 81.0 180 | 160 | 2.25 | 533 | | 0.098 | 0. | 07 | 1 | 11 | 13 1 | 8" x 12" | 1 | rior to s | | | |
| | | | SCHED | ULE | | ŗ | 1 | | | | | | | Isions pr | | | |
| Capacity (MBH) | / | Configuration | - | n) ESP (in. v | wc.) (\ | //Pn/Hz) | | סיכ | Dimensio (WxLxH |) | Unit Weigl (Ibs.) | N | olicable Notes | II dimen | DETAILS & | HANICAL & EQUIPMENT EDULES | 1 |
| 67 59/57.3 17.9 juired. 2. TXV and filter rack (for 2" deep fil | 23.8 ter) required. 3. (| Horizontal Capacities listed | 800 are at 95 de | 0.50 egree outdoo | | erature, with e | | | 8.5" x 45" > is listed an | | 110 uled condens | | 2,3,4,5,6 4 . Provide | | Drawn By | 13 | 1 |
| ke damper with 24V motorized actuators. | | | | | • | ture sensors. | 6. Provide | e Trane Tr | racer SC S | System L | JC400 contro | oller. | | l Field | Chk'd By | OF 21 | |
| AT Capacity EWT LWT Airflow °F) (MBH) (°F) (°F) (cfm) | YDRONIC CAE GPM Water PD (Ft.) | Coil Fins Co | | Rlower Dia | Motor Ty | pe Motor Hp | | trical h/Hz) | MCA M | OPD | Dimension (WxLxH) | | oplicable Notes | rawings | Sheet No. | | 1 |
| (MBH) (°F) (°F) (°F) (°F) 126 23.8 200 184 335 126 23.8 200 184 335 | 3.0 0.55 3.0 0.55 | per InchArea1212 | a (sq. π.) 1.5 1.5 | 5.75 x 7 5.75 x 7 | ECM ECM | 1/15 | 120/ | /1/60 /1/60 | 0.6 | | (WXLXH) 26" x 43" x 9 26" x 43" x 9 | .5" | 1,2,3 1,2,3 | Scale Dr | N A | _ 7 | |
| incomply and return air 2 Airflow listed is f | | ium aneed airflow | | | | | | | 5" x 0" x 1/2 | | | | 40.1/0 120 | 1 ਦ | IVI | -3 | ſ |

| GRINNEL #94 WITH | TYPICAL RECTANGULAR DUCT JOINTS | | | | | | |
|--|---|---|---|--|--|--|--|
| TO PANEL POINT CLAMP- | AND REINFORCINGJOINT DETAILMAX. DUCT DIMENSIONMAX. DISTANCE BETWEEN JOINTSREINFORCING | DUCT SIZE "A" "B" FLAT BAR ROD DIA. UP TO 24" 1" x 1 /8" 3 /8" 25" TO 41" 1" x 1 /8" 3 /8" 42" AND UP 1 1 /2" x 3 /16" 1 /2" | | | | | |
| ALL DUCT MUST BE HUNG- FROM JOIST PANEL POINTS ONLY SHALL BE WITHIN *2" FROM PANEL POINT. BOTTOM OF DUCT 9'-7" AFF. BOTTOM OF DUCT SUPPORT ANGLE | $ \begin{array}{c ccccccccccccccccccccccccccccccccccc$ | $ \begin{array}{c} & & & \\ & $ | YEZZI ASSOCIATES | | | | |
| DUCT WIDTH ROD DIAM. TYPE SUPPORT ANGLE MAX. SPACING UP TO 24" 3/8" A 1 1/2" x 1 1/2" x 1/8" 4'-0" O.C. 25" TO 36" 3/8" B 1 1/2" x 1 1/2" x 1/8" 8'-0" O.C. | LONGITUDINAL JOINTS AT CONNERS | 2 1 2 SUPPORT FOR ROUND DUCTS UP TO 24" DIA. SUPPORT FOR ROUND DUCTS 25" DIA. AND LARGER | ARCHITECTURE PLANNING ENGINEERING INTERIORS MANAGEMENT 18 Washington Street P.O. Box 1638 Toms River, N.J. 08754 Tel: 732-240-3433 Fax: 732-240-3463 E-mail: info@yezziassociates.com | | | | |
| 3 DUCT HANGER ROD WITH SUPPORT | 4 LOW PRESSURE SHEET METAL DUCTWORK NO SCALE | DUCTWORK HANGER (ROUND DUCTWORK) 5 NO SCALE | Website: www.yezziassociates.com <u>Massimo Francis Yezzi, Jr.</u> Architect No. C 7475 — NJ Planner No. 2368 — NJ Architect No. 39914 — NCARB Architect No. 30262377 — AIA | | | | |
| AIRFLOW | .5 AIRFLOW | | Daniel M. Sernotti Architect No. 21Al01897900-NJ Architect No. S5-0008349 -DE Architect No. RA 015346 -GA Architect No. 73872 -NCARB | | | | |
| 4'-0" MAXIMUM | TRANSFER DUCT | | HIGHLAND RESOURCE GROUP, LLC. 130 BORTONS ROAD, MARLTON, NJ 08053 WWW.HRGNJ.COM, V.856-404-0572, F.856-627-7886 CERTIFICATE OF AUTHORIZATION: #24GA28138200 MATTHEW DAVID WELLS, N.J.P.E. PROFESSIONAL ENGINEER, LIC. NO. 24GE04594000 | | | | |
| | 1" INTERNAL LINING | | SIGNATURE NOT VALID DATE WITHOUT RAISED SEAL | | | | |
| UCT SUPPORT DETAIL | DUCT DESIGN STATIC PRESSURE (IN WG) | | PROPOSED RENOVATIONS TO PROPOSED RENOVATIONS TO STOCKTON UNIVERSITY TOWNSEND RESIDENTIAL LIFE CENTER 101 VERA KING FARRIS DR. GALLOWAY ATLANTIC COUNTY NEW JERSEY | | | | |
| Tag Manufacturer M | lodel Total Capacity (MBH) SEER EER COP AT 47°F | Elec. Char. (V/Ph/Hz) MCA MOPD Dimensions (WxLxH) Applical Notes | | | | | |
| | R5024H1 23.8 15.0 12.5 3.6 ssor. 2. Two stage, scroll compressor. 3. Provide seacost kit. 4. Listed S | 208/1/60 14 25 30" x 32.5" x 32.75" 1,3,4 EER, EER, and COP are at AHRI rating conditions, and with scheduled air | | | | | |
| handling unit. | | | Proj | | | | |
| | HOT WATER HEATING COIL SCHEDULE | FIN SPACING SIZE | | | | | |
| /C-6 AHU-6 TRANE D5WB12018G0AA 800 22.56 55 | LAT °F EWT °F LWT °F GPM VELOCITY (ft/min) | $\begin{array}{c c c c c c c c c c c c c c c c c c c $ | TES Revisions By Date T of L | | | | |
| ES: 1. Provide 1/2" modulating 3-way control valve with 24V Belimo actuator. | | | | | | | |
| agManufacturerModelEAT (db/wb)LAT (db/wb)Sensible Capacity (MBH)IU-6TraneTEM4A0B24S2180/6759/57.317.9 | AIR HANDLING UNIT SCHEDULETotal CapacityInstalledAirflow (cfm)ESP (in. wc.)Elec. Ch(MBH)ConfigurationAirflow (cfm)ESP (in. wc.)Elec. Ch23.8Horizontal8000.50208/1/6 | z) MICA MOPD (WxLxH) (lbs.) Notes | DETAILS & EQUIPMENT | | | | |
| es: 1. Secondary, auxilliary overflow drain pan required. 2. TXV and filter rack (for 2" deep f | ilter) required. 3. Capacities listed are at 95 degree outdoor air temperature | e, with entering air conditions listed and scheduled condensing units. 4 . Pr | | | | | |
| 10" return air damper, and 18" x 10" outdoor intake damper with 24V motorized actuators. | 5. Provide duct-mounted return air, mixed air, and supply air temperature se | ensors. b . Provide Frane Fracer SC System UC400 controller. | OF Chk'd By 21 | | | | |
| Manufacturer Model Size EAT LAT Capacity EWT LWT Airflow | GPM Water Coil Fins Coil Face Blower Dia. Motor Type | Motor Hp Electrical MCA MOPD Dimensions Applica | 2 | | | | |
| Interference Interference< | PD (Ft.) per Inch Area (sq. ft.) X W (in.) Inotion 1 ypc I 3.0 0.55 12 1.5 5.75 x 7 ECM 3.0 0.55 12 1.5 5.75 x 7 ECM 3.0 0.55 12 1.5 5.75 x 7 ECM | (V/Ph/Hz) IIIOA IIIOA (WxLxH) Note 1/15 120/1/60 0.6 15 26" x 43" x 9.5" 1,2,3 1/15 120/1/60 0.6 15 26" x 43" x 9.5" 1,2,3 1/15 120/1/60 0.6 15 26" x 43" x 9.5" 1,2,3 2 Upit is provided with a 27 75" x 9" x 1/2" thick permaport filter 4 Provide 40 V | | | | | |

| GRINNEL #94 WITH 89X RETAINING CLIP | TYPICAL RECTANGULAR DUCT JOINTS | | |
|---|--|---|--|
| ALL DUCT MUST BE HUNG- FROM JOIST PANEL POINTS ONLY SHALL BE WITHIN *2" FROM PANEL POINT. | AND REINFORCINGJOINT DETAILMAX. DUCT DIMENSIONMAX. DISTANCE BETWEEN JOINTSREINFORCING AT JOINTSImage: Descent state12"8'NONEImage: Descent state18"8'NONEImage: Descent state18"4'NONEImage: Descent state19" TO 42"4'NONE | DUCT SIZE "A" FLAT BAR "B" ROD DIA. UP TO 24" 1" x 1 /8" 3 /8" 25" TO 41" 1" x 1 /8" 3 /8" 42" AND UP 1 1 /2" x 3 /16" 1 /2" | |
| BOTTOM OF DUCT 9'-7" AFF. BOTTOM OF DUCT 9'-7" AFF. DUCT WIDTH ROD DIAM. TYPE SUPPORT ANGLE UP TO 24" 3/8" A 1 1/2" × 1 1/2" × 1/8" 4'-0" O.C. | H = 1 1/2" 3' NONE 43" TO 60" 3' NONE 61" TO 84" 2' $1 1/2" \times 1 1/2" \times 1/8"$ 85" TO 96" 2' $1 1/2" \times 1 1/2" \times 3/16"$ 0VER 96" 2' $2 \times 2 \times 1/4"$ 85" TO 96" 8' $1 1/2" \times 1 1/2" \times 3/16"$ 0VER 96" 8' $2 \times 2 \times 1/4"$ 1000000000000000000000000000000000000 | | YEZZI ASSOCIATES ARCHITECTURE PLANNING ENGINEERING INTERIORS MANAGEMENT |
| 25" TO 36" 3/8" B 1 1/2" x 1 1/2" x 1/8" 8'-0" O.C. 3 DUCT HANGER ROD WITH SUPPORT NO SCALE | WHEN USING ANGLE COMPANION JOINTS, PROVIDE ANGLE REINFORCING ON 2FT. CENTER BETWEEN JOINTS OF THE SAME SIZE ANGLE AS USED FOR JOINT A LOW PRESSURE SHEET METAL DUCTWORK NO SCALE | - (ROUND DUCTWORK) | 18 Washington Street P.O. Box 1638 Toms River, N.J. 08754 Tel: 732-240-3433 Fax: 732-240-3463 E-mail: info@yezziassociates.com Website: www.yezziassociates.com |
| | .5 | NO SCALE | Architect No. C 7475 -NJ Planner No. 2368 -NJ Architect No. 39914 -NCARB Architect No. 30262377 -AIA Daniel M. Sernotti Architect No. 21AI01897900-NJ Architect No. S5-0008349 -DE Architect No. RA 015346 -GA |
| AIRFLOW - 4'-0" MAXIMUM MAX. SAG 1/2" PER FOOT OF SUPPORT SPACING | TRANSFER DUCT | | Architect No. 73872 –NCARB INFORMATION HIGHLAND RESOURCE GROUP, LLC. 130 BORTONS ROAD, MARLTON, NJ 08053 WWW.HRGNJ.COM, V.856-404-0572, F.856-627-7886 CERTIFICATE OF AUTHORIZATION: #24GA28138200 MATTHEW DAVID WELLS, N.J.P.E. PROFESSIONAL ENGINEER, LIC. NO. 24GE04594000 |
| 8 | TRANSFER DUCT DETAIL | | SIGNATURE NOT VALID DATE WITHOUT RAISED SEAL |
| UCT SUPPORT DETAIL | AIR-COOLED CONDENSING UNIT (HEAT | | PROPOSED RENOVATIONS TO STOCKTON UNIVERSITY TOWNSEND RESIDENTIA LIFE CENTER 101 VERA KING FARRIS DR. GALLOWAY ATLANTIC COUNTY NEW JERSE |
| Tag Manufacturer | Model Total Capacity (MBH) SEER EER COP AT 47°F | Elec. Char. (V/Ph/Hz)MCAMOPDDimensions (WxLxH)Application(V/Ph/Hz)MCAMOPDDimensions (WxLxH)Notes | s o p |
| | TWR5024H1 23.8 15.0 12.5 3.6 apressor. 2. Two stage, scroll compressor. 3. Provide seacost kit. 4. Listed states | 208/1/60 14 25 30" x 32.5" x 32.75" 1,3,4 SEER, EER, and COP are at AHRI rating conditions, and with scheduled air | |
| handling unit. | | | Proj |
| | HOT WATER HEATING COIL SCHEDULE PERFORMANCE | (in) MIDD (ft. 1120) DOM(S FIN SPACING SIZE | March 12, 2021 |
| AG SERVICE MFGR. MODEL CFM MBH EAT °F | LAT °F EWT °F LWT °F GPM VELOCITY (ft/min) | (in. wc) WPD (ft. H2O) ROWS (fpf) W X H | TES Revisions By Date |
| /C-6AHU-6TRANED5WB12018G0AA80022.5655ES: 1. Provide 1/2" modulating 3-way control valve with 24V Belimo actuator. | 81.0 180 160 2.25 533 0 | 0.098 0.07 1 113 18" x 12" | |
| | AIR HANDLING UNIT SCHEDULE | | si ons |
| FagManufacturerModelEAT (db/wb)LAT (db/wb)Sensible Capacity (MBHHU-6TraneTEM4A0B24S2180/6759/57.317.9 | Total Capacity (MBH)Installed ConfigurationAirflow (cfm)ESP (in. wc.)Elec. C (V/Ph/23.8Horizontal8000.50208/1 | Hz) MCA MOPD (WxLxH) (lbs.) Notes | S DETAILS & EQUIPMENT |
| es: 1. Secondary, auxilliary overflow drain pan required. 2. TXV and filter rack (for 2" de | | | rovide ਤੋਂ ¹³ |
| (10" return air damper, and 18" x 10" outdoor intake damper with 24V motorized actuato | HYDRONIC CABINET UNIT HEATER SCHEDULE | | б Сһк'd Ву Сһ і 21 |
| (°F) (°F) (°F) (°F) (°F) (°F) (°F) (°F) | Flow flow (fm)WaterCoil FinsCoil FaceBlower Dia. X W (in.)Motor Type3353.00.55121.55.75 x 7ECM | Motor Hp Electrical (V/Ph/Hz) MCA MOPD Dimensions (WxLxH) Application 1/15 120/1/60 0.6 15 26" x 43" x 9.5" 1,2,3 | S D D |
| | 335 3.0 0.55 12 1.5 5.75 x 7 ECM d is for high around Medium around sinflow is 240 sfm Low around sinflow is 150 sfm Low around sinflow is 150 sfm Low around sinflow is 150 sfm | 1/15 120/1/60 0.6 15 26" x 43" x 9.5" 1,2,3 2 Upit is provided with a 27 75" x 9" x 1/2" thick permanent filter 4 Provide 40 V | <u>з</u> ў М—.З |

| /GRINNEL #94 WITH / 89X RETAINING CLIP | TYPICAL RECTANGULAR DUCT JOINTS | | | | | | |
|--|--|---|--|--|--|--|--|
| | | VEZZI ASSOCIATES ARCHITECTURE PLANNING ENGINEERING INTERIORS MANAGEMENT 18 Washing Street P.O. Box 1638 Toms River, N.J. 08754 Tel: 732–240–3433 Fox: 732–240–3433 E-mail: info@yezziossociates.com | | | | | |
| 3 DUCT HAINGER ROD ATTH SUPPORT | (4) NO SCALE (5) AIRFLOW | Massimo Francis Yezzi, Jr. Architect No. C 7475 -NJ Planner No. 2368 -NJ Architect No. 39914 -NCARB Architect No. 30262377 -AIA Daniel M. Sernotti Architect No. 21Al01897900 – NJ Architect No. 21Al01897900 – NJ Architect No. S5–0008349 – DE Architect No. 73872 –NCARB Architect No. 73872 –NCARB Methods Robol Martine Normal -GA Methods Robol Martine Normal -GA Methods Robol Martine Normal -GA Marthew David Wells, N.J.P.E. Normal POFESSIONAL ENGINEER, LIC. NO. 24GE045940002 SIGNATURE NOT VALID Date MUNNARSE Seal NUNNARSE Architect No. Architect No. Architect Seal NUNNARSE | | | | | |
| AIR FLOW Tag Manufacturer ACCU-6 Trane Notes: 1. Single stage, scroll of handling unit. | (MBH) SEER EER 47°F (V/Ph/Hz) MICA MOPD Dimensions (WXLXH) N | uction. Project Project Proposed RenovaTion STOCKTON UNIV TOWNSEND RESIL LIFE CENTE atLantic county atLantic county | | | | | |
| | HOT WATER HEATING COIL SCHEDULE PERFORMANCE | Issued for Bid March 12, 2021 | | | | | |
| G SERVICE MFGR. MODEL CFM MBH EAT C-6 AHU-6 TRANE D5WB12018G0AA 800 22.56 55 | APD (in, wc) WPD (ft, H2O) ROWS | NOTES Revisions By Date | | | | | |
| S: 1. Provide 1/2" modulating 3-way control valve with 24V Belimo actuate | tor. | st prior | | | | | |
| All Handling Unit Schedules All (db/wb) An (db/wb) Sensible (apacity (MBH)) Installed (MBH) Airflow (cfm) ESP (in. wc.) MCA MOPD Dimensions (WxLxH) Applicable (lbs.) Applicable (lbs.) Method (lbs.) Motes Method (lbs.) Method | | | | | | | |
| | etuators. 5. Provide duct-mounted return air, mixed air, and supply air temperature sensors. 6. Provide Trane Tracer SC System UC400 controller. | Chk'd By OF | | | | | |
| ManufacturerModelSizeEAT (°F)LAT (°F)Capacity (MBH)EWT (°F)LWT (°F)1Beacon MorrisRC - 1200036012623.82001842Beacon MorrisRC - 1200036012623.8200184 | (cfm) OP (Ft.) per Inch Area (sq. ft.) X W (in.) Motor Type Motor Hp (V/Ph/Hz) MCA MOPD (WxLxH) 335 3.0 0.55 12 1.5 5.75 x 7 ECM 1/15 120/1/60 0.6 15 26" x 43" x 9.5" | Sheet No. Sheet No. Notes 1,2,3 | | | | | |
| 2Beacon MorrisRC - 1200036012623.8200184: 1. Model specified is recessed-ceiling, with bottom face supply and return air .2. Airflow | 335 3.0 0.55 12 1.5 5.75 x 7 ECM 1/15 120/1/60 0.6 15 26" x 43" x 9.5" v listed is for high speed. Medium speed airflow is 240 cfm. Low speed airflow is 150 cfm. 3. Unit is provided with a 27.75" x 9" x 1/2" thick permanent filter. 4. Provide | 1,2,3 ° 9 40 VA, 120 ថ្ ខ M−3 | | | | | |

Notes: 1. Model specified is recessed-ceiling, with bottom face supply and return air. 2. Airflow listed is for high speed. Medium speed airflow is 240 cfm. Low speed airflow is 150 cfm. 3. Unit is provided with a 27.75" x 9" x 1/2" thick permanent filter. 4. Provide 40 VA, 120 V primary / 24 V secondary control transformer (with secondary circuit breaker); pilot duty relay with 10 amp contact rating, 24 volt holding coil, and HOA switch (RIBU1S or equiv.); and 24 volt, programmable thermostat. OWNERSHIP OF DOCUMENTS: This document, ideas and designs incorporated herein, are instruments of professional service and are the property of Yezzi Associates. These documents have been reviewed with the client prior to being signed and sealed by Yezzi Associates to insure conformance with clients scope of work

ELECTRICAL GENERAL NOTES & SPECIFICATIONS

| 1. UNLESS ITEMS OF MATERIAL, EQUIPMENT OR WORK ARE SPECIFICALLY NOTED TO BE PROVIDED OR FURNISHED BY OTHERS, THEY SHALL BE PROVIDED BY THIS CONTRACTOR TO PERFORM THE WORK AS SHOWN AND DESCRIBED ON THE DRAWINGS. ITEMS NOTED "FURNISHED BY OWNER" SHALL BE INSTALLED BY THIS CONTRACTOR. | |
|--|-------------------|
| 2. WORK SHALL BE IN STRICT ACCORDANCE WITH THE LATEST EDITION OF THE NATIONAL ELECTRICAL CODE (NFPA 70), UNIFORM CONSTRUCTION CODE, INTERNATIONAL BUILDING CODE AND ALL APPLICABLE STATE AND LOCAL CODES. | c |
| 3. WORK SHALL BE INSTALLED AND PERFORMED IN A WORKMAN LIKE MANNER CONSISTENT WITH APPLICABLE INDUSTRY STANDARDS. | |
| 4. EQUIPMENT INSTALLATIONS SHALL CONFORM TO THE EQUIPMENT MANUFACTURER'S WRITTEN INSTRUCTIONS AND ALL APPLICABLE INDUSTRY STANDARDS. INSTALL EQUIPMENT IN STRICT COMPLIANCE WITH THE MANUFACTURER'S WRITTEN INSTRUCTIONS. | |
| 5. BY SUBMITTING THEIR BID, THIS CONTRACTOR WARRANTS THAT HE HAS VISITED THE PROJECT SITE, VIEWED CONDITIONS, MATERIAI AND EQUIPMENT THAT EXIST AND WARRANTS THAT HE IS THOROUGHLY FAMILIAR WITH THE SCOPE OF WORK REQUIRED TO PROVIDE COMPLETE, FULLY FUNCTIONAL, CODE ACCEPTABLE SYSTEM. | |
| 6. COORDINATE INSTALLATION OF WORK WITH EXISTING CONDITIONS AND ALL OTHER SYSTEMS BEING INSTALLED PRIOR TO START OF WORK. ALL SYSTEMS REQUIRED TO BE REMOVED AND REINSTALLED DUE TO THE LACK OF COORDINATION BY THIS CONTRACTOR SH BE DONE AT THIS CONTRACTOR'S EXPENSE. WHERE SYSTEMS OR ITEMS ARE INDICATED ON THE DRAWINGS, OR DURING THE COURS OF CONSTRUCTION ARE FOUND NECESSARY TO BE RELOCATED, REROUTED OR REMOVED AND REINSTALLED, CONTRACTOR SHALL PROVIDE NEW MATERIALS TO MATCH EXISTING MATERIALS, EQUIPMENT, ETC. AS REQUIRED TO PERFORM TASKS INDICATED. | HALL HALL |
| 7. WORK REQUIRING THE SHUTDOWN OF ANY EXISTING SYSTEMS SHALL BE COORDINATED SO LENGTH OF DOWN TIME IS MINIMIZED. ALL SYSTEM SHUTDOWNS SHALL BE COORDINATED WITH OWNER PRIOR TO START OF CONSTRUCTION. | И |
| 8. SYSTEMS SHALL BE LEFT IN PROPER WORKING ORDER. WORK, MATERIALS OR EQUIPMENT FURNISHED AND INSTALLED BY THIS CONTRACTOR UNDER THIS CONTRACT THAT DEVELOPS DEFECTS WITHIN ONE (1) YEAR FROM THE DATE OF FINAL ACCEPTANCE OF TH WORK BY THE OWNER, OTHER THAN NORMAL WEAR AND TEAR, SHALL BE REPLACED WITHOUT ADDITIONAL CHARGE. | HE S |
| 9. IN FINISHED AREAS, CONCEAL RACEWAYS AND WIRING IN WALLS, PIPE CHASES, ABOVE CEILINGS OR UTILITY SPACES, UNLESS INSTALLATION OF SURFACE MOUNTED RACEWAYS HAS THE PRIOR APPROVAL OF THE OWNER. | Œ |
| 10. INSTALL RACEWAYS TIGHT TO SLABS, BEAMS, JOISTS, COLUMNS, WALLS, AND OTHER PERMANENT ELEMENTS OF THE BUILDING. ALLOW SUFFICIENT SPACE ABOVE REMOVABLE CEILING PANELS TO ALLOW FOR PANEL REMOVAL. | D - |
| 11. PROVIDE GROUNDING FOR ALL ELECTRICAL ENCLOSURES AND EQUIPMENT AND FOR ALL METAL PIPING IN THE BUILDING (ELECTRICAL CONDUIT, WATER PIPING, SPRINKLER PIPING, ETC.) IN ACCORDANCE WITH THE LATEST EDITION OF THE NATIONAL ELECTRICAL CODE (NFPA 70). CONNECT THE GROUNDING FOR THIS EQUIPMENT TO THE BUILDING'S EXISTING GROUND SYSTEM. | F |
| 12. PROVIDE LATERAL SEISMIC RESTRAINTS AS REQUIRED IN ACCORDANCE WITH THE LATEST EDITION OF APPLICABLE BUILDING CODE FOR ALL EQUIPMENT AND RACEWAYS AS DESCRIBED WITHIN THE CODE. | ∎ ● # |
| 13. PROVIDE ALL MISCELLANEOUS STEEL SHAPES, HANGERS, RODS, STRAPS, ETC. REQUIRED FOR THE INSTALLATION OF EQUIPMENT UNDER THIS CONTRACT. | @ # |
| 14. PROVIDE APPLICABLE PLUGS OR COVERS FOR ALL OPENINGS IN CONDUIT FITTINGS, J-BOXES, ETC. | |
| 15. PROVIDE TEMPORARY LIGHTING AND POWER, AS REQUIRED, DURING CONSTRUCTION. REMOVE WIRING AND DEVICES AT END OF CONSTRUCTION. | -0 |
| 16. PROVIDE FIRE RATED SLEEVES AT ALL FIREWALL PENETRATIONS AND SEAL AROUND SLEEVES AND PIPES WITH FIRE STOP SEALAI THIS CONTRACTOR SHALL HIRE INDIVIDUALS SKILLED IN SUCH WORK TO DO THE SEALING AND FIREPROOFING. THESE INDIVIDUALS H SHALL NORMALLY AND ROUTINELY BE EMPLOYED IN THE SEALING AND FIREPROOFING OCCUPATION. | |
| 17. UNLESS DIRECTED OTHERWISE, ALL CUTTING AND PATCHING OF NEW AND EXISTING WALLS, CEILINGS OR FLOORS FOR REMOVALS OR INSTALLATION OF EQUIPMENT, IS THE RESPONSIBILITY OF THE CONTRACTOR WHOSE WORK PENETRATES THE OPENING. THE CONTRACTOR RESPONSIBLE SHALL HIRE INDIVIDUALS SKILLED IN SUCH WORK TO DO THE PATCHING AND PAINTING. THESE INDIVIDU HIRED SHALL NORMALLY AND ROUTINELY BE EMPLOYED IN THE PATCHING AND PAINTING OCCUPATION. THIS CONTRACTOR SHALL BE RESPONSIBLE FOR REPAIRING OR REPLACING, WITHOUT ADDITIONAL CHARGE, ANY EXISTING WORK DAMAGED BY HIM DURING THE COURSE OF THIS CONSTRUCTION. | JALS _ |
| 18. VERIFY AFTER ALL WORK IS COMPLETED THAT ALL OPENINGS IN WALLS AND CEILINGS ARE PATCHED AND PAINTED TO MATCH EXISTING SURFACES. | |
| 19. APPLY FOR AND PROCURE ALL REQUIRED PERMITS, CERTIFICATES, AND AGENCY APPROVALS REQUIRED FOR THE LAWFUL PROSECUTION OF THE WORK UNLESS OTHERWISE DIRECTED. PROVIDE THE OWNER WITH COPIES OF ALL REQUIRED CERTIFICATIONS A APPROVALS. | |
| 20. PROVIDE THE OWNER WITH COMPLETE AND ACCURATE "AS INSTALLED DOCUMENTATION" AT THE COMPLETION OF THE PROJECT. | A |
| 21. PROVIDE TESTS AS REQUIRED BY THE OWNER OR ANY INSPECTION DEPARTMENT. TESTS SHALL VERIFY WHETHER THE EQUIPME AND SYSTEMS INSTALLED COMPLY WITH THE SPECIFICATIONS AND ARE IN PROPER WORKING ORDER. PROVIDE TEST RESULTS TO THE OWNER. | |
| 22. EQUIPMENT LISTED IN THESE DOCUMENTS BY MANUFACTURE AND MODEL NUMBER ESTABLISHES A STANDARD OF QUALITY FOR T EQUIPMENT. EQUAL SUBSTITUTES MAY BE ACCEPTABLE. WRITTEN APPROVAL OF THE PROPOSED SUBSTITUTION IS REQUIRED PRIOR TO PURCHASE OR INSTALLATION. | THE O |
| 23. SUBMIT SHOP DRAWINGS FOR ALL MAJOR MANUFACTURED ITEMS REQUIRED ON THIS PROJECT. A MINIMUM OF 4 COPIES SHALL SUBMITTED. EQUIPMENT OR SYSTEM COMPONENTS SHALL NOT BE PURCHASED OR INSTALLED PRIOR TO CONTRACTORS RECEIPT OF REVIEWED SHOP DRAWINGS. REVIEW OF SHOP OR INSTALLATION DRAWINGS SHALL ONLY BE CONSTRUED TO APPLY TO GENERAL LAYO AND CONFORMANCE OF THE EQUIPMENT TO THE DESIGN CONCEPT OF THE PROJECT AND FOR CONFORMANCE WITH THE GENERAL REQUIREMENTS OF THE CONTRACT DOCUMENTS. THE RESPONSIBILITY FOR DEVIATIONS FROM THE CONTRACT DOCUMENTS SHALL BE 1 CONTRACTOR'S UNLESS THE CONTRACTOR HAS, IN WRITING, SPECIFICALLY CALLED ATTENTION TO SUCH DEVIATIONS AT THE TIME OF SUBMISSION AND HAS RECEIVED WRITTEN APPROVAL OF SUCH DEVIATIONS FROM THE OWNER. | |
| 24. PROVIDE PRODUCT DATA INCLUDING INSTALLATION AND STARTUP INSTRUCTIONS FOR ALL EQUIPMENT SUPPLIED UNDER THIS CONTRACT PRIOR TO PURCHASE. SUBMITTALS SHALL INCLUDE PERFORMANCE DATA, WIRING DIAGRAMS. AND MAINTENANCE INSTRUCTIO | |
| 25. ALL WIRING SHALL BE COPPER TYPE THHN (INTERIOR) AND THWN (EXTERIOR). | |
| 26. ALL LIGHTING CIRCUIT HOMERUNS SHALL BE MINIMUM #10 AWG. | S ^a 3 |
| 26. WIRING AND ASSOCIATED RACEWAYS NOT SHOWN ON THE DRAWINGS SHALL BE SIZED PER THE LATEST EDITION OF THE NATIONA ELECTRICAL CODE (NFPA 70) UNLESS NOTED OTHERWISE. 27. RACEWAYS: | AL O |
| - EXPOSED INDOOR: ELECTRICAL METALLIC TUBING (EMT) OR AS INDICATED | |
| CONCEALED INDOOR: EMT, FLEXIBLE METAL CONDUIT OR AS INDICATED IN CONCRETE SLAB: GALVANIZED RIGID STEEL, PVC, OR AS INDICATED FINAL CONNECTIONS TO EQUIPMENT SUBJECT TO VIBRATION, MOVEMENT, OR ADJUSTMENT: 3'-0" MINIMUM LENGTH OF LIQUID | MD |
| TIGHT FLEXIBLE METAL CONDUIT. – CONNECTION TO LIGHT FIXTURES: 6'-0" MAXIMUM LENGTH OF FLEXIBLE ARMOR CLAD CABLE, TYPE AC OR MC. – MINIMUM RACEWAY SIZE IS: 3/4" FOR POWER WIRING. | |
| 1/2" FOR SIGNAL & CONTROL CABLING 28. ALL SIZING OF EQUIPMENT FOR CONNECTION TO MECHANICAL EQUIPMENT IS BASED ON MECHANICAL EQUIPMENT THAT IS SPECIFIED. THIS CONTRACTOR SHALL VERIFY ALL POWER REQUIREMENTS FOR ACTUAL EQUIPMENT INSTALLED. COORDINATE ANY MODIFICATIONS WITH THE ENGINEER PRIOR TO INSTALLATION. | <u>≁</u> _≁ ⊦⊽ |
| 29. ALL CUTTING AND PATCHING OF ROOF SHALL BE PROVIDED BY THE GENERAL CONTRACTOR UNLESS DIRECTED OTHERWISE. | КР |
| RESPONSIBLE CONTRACTOR SHALL SECURE THE SERVICES OF THE INSTALLED ROOFING MANUFACTURER'S CERTIFIED ROOFING TECHNICIAN PRIOR TO ANY PENETRATIONS OF EXISTING ROOFING ARE MADE TO MAINTAIN ANY WARRANTIES OF NEW OR EXISTING RC SYSTEM. ALL PENETRATIONS SHALL BE SEALED WATER—TIGHT | DOF 🗲 |
| 30. ALL ELECTRICAL PANELS WITHIN CONTRACT AREA SHALL BE PROVIDED WITH UP-TO-DATE, TYPED INDEX CARDS MOUNTED IN PLASTIC HOLDERS ON THE INSIDE OF EACH ENCLOSURE DOOR. | |
| 32. THE FACILITY OPERATIONS SHALL REMAIN FUNCTIONAL DURING CONSTRUCTION. THIS CONTRACTOR SHALL PROVIDE FULL DUST BARRIER ENCLOSURES AROUND ALL CONSTRUCTION, AND KEEP ALL AREAS CLEAR OF ALL DIRT AND DEBRIS. THIS CONTRACTOR SHA | |

THOROUGHLY COORDINATE, AND SCHEDULE CONSTRUCTION WITH GENERAL CONTRACTOR AND THE OWNER PRIOR TO COMMENCING

CONSTRUCTION.

ELECTRICAL SYMBOLS LEGEND

| | | ABBREVIA | <u>IIUNS LEGEND</u> |
|-----------------|--|------------------------------|--|
| | | ABBREVIATION | DESCRIPTION |
| XX-X | CONDUIT AND/OR WIRING HOMERUN TO PANELBOARD. TEXT INDICATES PANEL DESIGNATION AND CIRCUIT NUMBER. | A AC | AMPERES AIR CONDITIONING |
| o | CONDUIT TURNING UP | ACC ACCU | AIR COOLED CONDENSER AIR COOLED CONDENSING UNIT |
| > | CONDUIT TURNING DOWN | AHU AFF | AIR HANDLING UNIT ABOVE FINISHED FLOOR |
| | CONDUIT WITH CAP UNLESS OTHERWISE NOTED) | ARCH AWG | ARCHITECT AMERICAN WIRE GAUGE |
| | DEMOLITION OR NEW WORK | ATS | AUTOMATIC TRANSFER SWITCH |
| | EXISTING TO REMAIN | C CB | CONDUIT – RACEWAY CIRCUIT BREAKER |
| \Box | UNFUSED DISCONNECT SWITCH | CD CKT | CONTRACT DOCUMENTS CIRCUIT |
| \bigcirc | FLUSH WALL MOUNTED JUNCTION BOX OR JUNCTION BOX ABOVE CEILING | CLG CM | CEILING CONSTRUCTION MANAGER |
| | WALL OUTLET BOX FOR TELEPHONE W/ 1"C (W/ PULL CORD) TO ABOVE ACCESSIBLE FINISHED CEILING MOUNTED AT 18" AFF UNLESS OTHERWISE NOTED | CU DWG | COPPER |
| Ы | WALL OUTLET BOX FOR DATA W/ 1"C (W/ PULL CORD) TO ABOVE ACCESSIBLE FINISHED CEILING MOUNTED AT 18" AFF UNLESS OTHERWISE NOTED | em EC EF EOL EWH | EMERGENCY ELECTRICAL CONTRACTOR EXHAUST FAN END OF LINE ELECTRIC WATER HEATER |
| S | FIRE ALARM SYSTEM SMOKE DETECTOR — SIMPLEX MODEL #4098—9757 SUPPLIED W/ 4098—9788 2—WIRE BASE W/ REMOTE L.E.D. OUTPUT | EWC E/R | ELECTRIC WATER COOLER EXISTING TO REMAIN |
| (H) | FIRE ALARM SYSTEM HEAT DETECTOR — SIMPLEX MODEL #4098—9733 SUPPLIED W/ 4098—9792 TRUEALARM BASE FIRE ALARM | F FIXT FLA | FAHRENHEIT FIXTURE FULL LOAD AMPS |
| D - | SYSTEM DUCT DETECTOR – SIMPLEX MODEL #4098–9756 W/ 4098–9843 PROGRAMMABLE RELAY, TYPE 2098–9797 SAMPLING TUBES & 2098–9806 REMOTE TEST STATION, RED LED, KEY SWITCH | G GC GEN | GROUND OR GROUNDING GENERAL CONTRACTOR GENERATOR |
| F | FIRE ALARM SYSTEM ADDRESSABLE MANUAL PULL STATION — SIMPLEX MODEL #4099—9001 | GFI | GROUND FAULT INTERRUPT |
| ⊕ # ⊟ | FIRE ALARM SYSTEM AUDIO/VISUAL UNIT – SIMPLEX MODEL 4903–9426 ("#" INDICATES CANDELLA LEVEL) | HP ISCA | HORSE POWER SHORT CIRCUIT CURRENT RATING |
| <u>n</u> # | FIRE ALARM SYSTEM VISUAL UNIT — SIMPLEX MODEL #4904—9169 ("#" INDICATES CANDELLA LEVEL) | KVA KW | KILOVOLT AMPERES KILOWATTS |
| | 208/120V BRANCH CIRCUIT PANELBOARD - FLUSH MOUNTED | KWH | KILOWATT HOUR |
| Ð | WALL OUTLET BOX AND 120V, 20 AMP DUPLEX CONVENIENCE RECEPTACLE MOUNTED 18" ABOVE FINISHED UNLESS OTHERWISE NOTED. (+ INDICATES MOUNTED AT COUNTERTOP HEIGHT) COORDINATE LOCATION WITH ARCHITECTURAL PLANS | LSG MC MCB MCC | LONG TIME, SHORT TIME, GROUND FAULT MECHANICAL CONTRACTOR MAIN CIRCUIT BREAKER MOTOR CONTROL CENTER |
| - | WALL OUTLET BOX AND 120V, 20 AMP G.F.I. RECEPTACLE (+ INDICATES MOUNTED AT COUNTERTOP HEIGHT. COORDINATE LOCATION WITH ARCHITECTURAL PLANS | MH MISC MLO | MOUNTING HEIGHT MISCELLANEOUS MAIN LUGS ONLY |
| # | WALL OUTLET BOX AND 120V, 20 AMP QUADRAPLEX RECEPTACLE MOUNTED 18" AFF UNLESS OTHERWISE NOTED. (+ INDICATES MOUNTED AT COUNTERTOP HEIGHT. COORDINATE LOCATION WITH ARCHITECTURAL PLANS | N NEC NL NIC NTS | NEUTRAL NATIONAL ELECTRICAL CODE NIGHT LIGHT NOT IN CONTRACT NOT TO SCALE |
| | 2X4 FLUORESCENT LIGHTING FIXTURE - LETTER "A" INDICATES TYPE | PNL | PANEL OR PANELBOARD |
| | 2X4 FLUORESCENT LIGHTING FIXTURE ON UNSWITCHED CIRCUIT FOR NIGHT LIGHTING – LETTER INDICATES TYPE | ø, PH RTU | Phase Roof top unit |
| | 1X4 FLUORESCENT LIGHTING FIXTURE - LETTER "A" INDICATES TYPE | SP | SPARE |
| Ю | WALL MOUNTED LIGHT - LETTER "A" INDICATES TYPE | tbd Tel Tw/Sh | to be decided Telephone Twisted/shiedled |
| | CEILING OUTLET BOX AND ILLUMINATED EXIT SIGN (SHADED QUADRANT INDICATES FACE). DIRECTIONAL ARROWS AS INDICATED ON PLANS. LETTER "A" INDICATES TYPE | UH UON | UNIT HEATER UNLESS OTHERWISE NOTED |
| ⊗ + | WALL OUTLET BOX AND ILLUMINATED EXIT SIGN (SHADED QUADRANT INDICATES FACE). DIRECTIONAL ARROWS AS INDICATED ON PLANS. LETTER "A" INDICATES TYPE. | V VAV VFD | VOLT VARIABLE AIR VOLUME VARIABLE FREQUENCY DRIVE |
| | BATTERY OPERATED EMERGENCY LIGHTING UNIT; NUMBER OF HEADS AS INDICATED ON PLANS | WP WH | WEATHERPROOF WATER HEATER |
| 4 | REMOTE HEAD FOR BATTERY OPERATED EMERGENCY LIGHTING UNIT. LETTER "A" INDICATES TYPE. | XFMR | TRANSFORMER |

| | LIGHTING FIXTURE SCHEDULE | | | | | | |
|------|---|-------------------------------------|--|--|--|--|--|
| TYPE | DESCRIPTION | ACCEPTABLE MFR & CAT# | | | | | |
| A | VOLUMETRIC LED TROFFER, 2' x 4', WITH PRISMATIC DIFFUSER | LITHONIA 2VTL4-48L-ADP-EZ1-LP35 | | | | | |
| В | 8" LED DOWNLIGHT - EXTERIOR | LITHONIA WF8-LED-35K-MVOLT-90CRI-MW | | | | | |
| С | LED EXIT SIGN/EMG LIGHT | LIGHTALARMS UQLXN500R-2LEDR | | | | | |

GRADE MOUNTED OUTLET BOX AND 120V, 20 AMP G.F.I. DUPLEX RECEPTACLE WITH WEATHER PROOF, LOCKING COVER. COORDINATE LOCATION WITH ARCHITECTURAL PLANS.

BREAKER CT DOCUMENTS

ABBREVIATIONS LEGEND

LINCI CONTRACTOR ST FAN F LINE RIC WATER HEATER WATER COOLER

WALL OUTLET BOX AND SINGLE POLE TOGGLE-TYPE SWITCH - 20 AMP, MOUNTED 54" AFF UNLESS OTHERWISE NOTED. (LOWER CASE LETTER INDICATES LIGHTS TO BE CONTROLLED. IF NO LETTER IS INDICATED, ALL LIGHTS IN ROOM SHALL BE CONTROLLED)

WALL OUTLET BOX AND THREE-WAY TOGGLE TYPE SWITCH - 20 AMP, MOUNTED 54" AFF UNLESS OTHERWISE NOTED. (LOWER CASE LETTER INDICATES LIGHTS TO BE CONTROLLED. IF NO LETTER IS INDICATED, ALL LIGHTS IN ROOM SHALL BE CONTROLLED)

4"SQ. OUTLET BOX AND OCCUPANCY SENSOR (DUAL TECHNOLOGY TYPE) MOUNTED ON CEILING UNLESS OTHERWISE NOTED.

SECURITY SYSTEM MOTION SENSOR

SECURITY SYSTEM DOOR CONTACTOR

SECURITY SYSTEM EXTERIOR WEATHERPROOF SPEAKER


EMERGENCY BATTERY PACK

EMERGENCY LIGHTING REMOTE HEAD

SECURITY SYSTEM KEY PAD

LICUTING EIVTUDE COUEDINE

| | YEZZI ASSOCIATES |
|--|---|
| | ARCHITECTURE PLANNING ENGINEERING INTERIORS MANAGEMENT 18 Washington Street P.O. Box 1638 Toms River, N.J. 08754 Tel: 732-240-3433 Fax: 732-240-3463 E-mail: info@yezziassociates.com Website: www.yezziassociates.com |
| | MassimoFrancisYezzi,Jr.ArchitectNo.C7475-NJPlannerNo.2368-NJArchitectNo.39914-NCARBArchitectNo.30262377-AIADanielM.SernottiArchitectNo.21AI01897900-NJArchitectNo.S5-0008349-DEArchitectNo.RA015346-GAArchitectNo.73872-NCARB |
| | HIGHLAND RESOURCE GROUP, LLC. 130 BORTONS ROAD, MARLTON, NJ 08053 WWW.HRGNJ.COM, V.856-404-0572, F.856-627-7886 CERTIFICATE OF AUTHORIZATION: #24GA28138200 |
| | MATTHEW DAVID WELLS, N.J.P.E. PROFESSIONAL ENGINEER, LIC. NO. 24GE04594000 |
| Dn. | Project Proposed Renovations to STOCKTON UNIVERSITY TOWNSEND RESIDENTIAL LIFE CENTER 101 VERA KING FARRIS DR. GALLOWAY ATLANTIC COUNTY NEW JERSEY |
| constructio | Issued for Bid March 12, 2021 |
| all dimensions prior to start of construction. | Revisions By Date |
| all dimen | Sheet Title ELECTRICAL COVERSHEET |
| | Drawn By 4 Chk'd By 21 |
| Do Not Scale Drawings - Field check | Sheet No. E-O Project No. YC20122 |

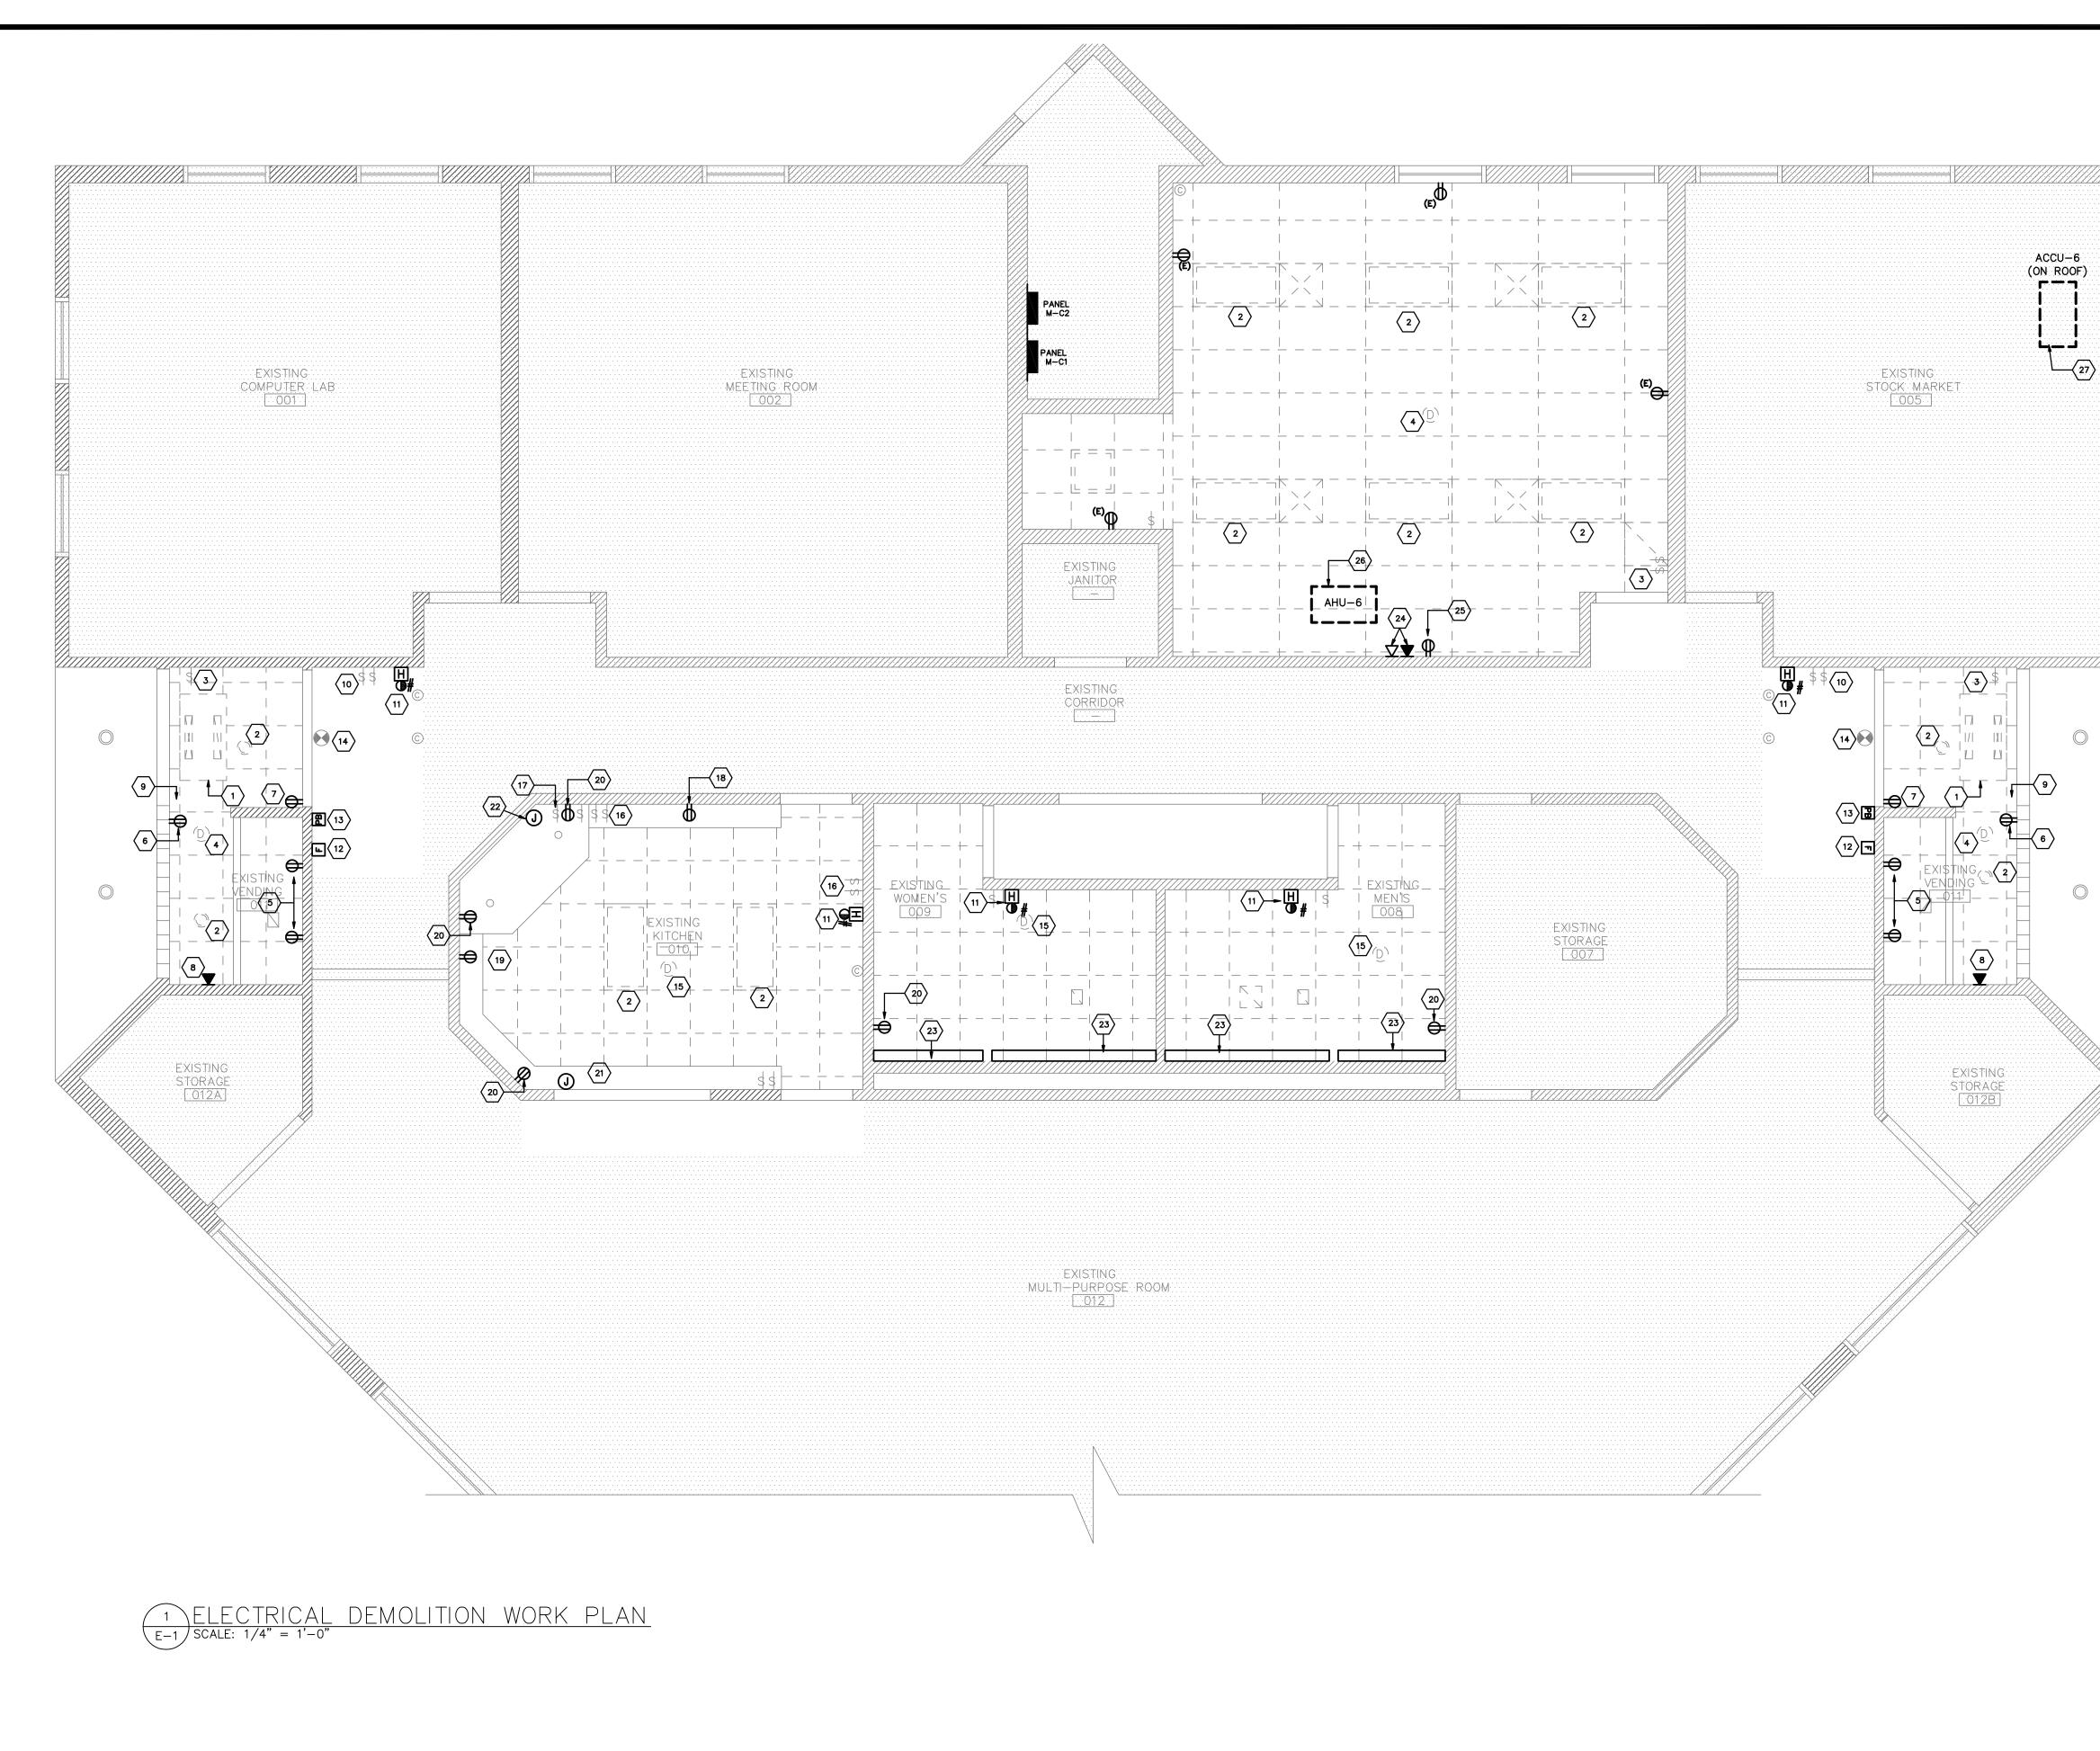

| 7772 | DISCONNECT ELECTRICAL POWER CIRCUIT FOR CEILING-MOUNTED CABINET UNIT HEATER. SAFE-OFF CIRCUIT AND PREPARE FOR EXTENSION TO NEW CABINET UNIT HEATER TO BE INSTALLED UNDER THE SCOPE OF THE PROPOSED WORK. | |
|-------|--|---|
| | 2 EXISTING CEILING RECESSED LIGHTING FIXTURE TO BE REMOVED. SAFE-OUT EXISTING CONDUCTORS AND PREPARE FOR RECONNECTION TO NEW LIGHTING FIXTURE TO BE INSTALLED UNDER THE SCOPE OF THE PROPOSED WORK. | |
| | 3 REMOVE EXISTING LIGHT SWITCH AND SWITCH LEG CONDUCTORS BACK TO ASSOCIATED LIGHT FIXTURES. INSTALL BLANK COVER PLATE OVER EXISTING RECESSED ELECTRICAL BOX. | |
| | A REMOVE EXISTING CEILING-MOUNTED SMOKE DETECTOR. REMOVE FIRE ALARM CONDUCTORS BACK TO NEXT FIRE ALARM DEVICE. REPROGRAM FIRE ALARM SYSTEM FOR REMOVAL OF EXISTING SMOKE DETECTORS. | |
| | 5 REMOVE EXISTING DUPLEX RECEPTACLES. SAFE-OFF CONDUCTORS AND PREPARE FOR RECONNECTION TO NEW RECEPTACLES UNDER THE SCOPE OF THE PROPOSED WORK. | |
| | 6 REMOVE EXISTING SURFACE-MOUNTED DUPLEX RECEPTACLE MOUNTED AT CEILING HEIGHT FOR AUTOMATIC DOOR ACTIVATOR. REMOVE CONDUCTORS AND SURFACE-MOUNTED CONDUIT BACK TO NEXT ELECTRICAL JUNCTION BOX. | |
| | 7 REMOVE EXISTING SURFACE-MOUNTED DUPLEX RECEPTACLE AT CEILING HEIGHT FOR AUTOMATIC DOOR ACTUATOR. SAFE-OFF CONDUCTORS AND PREPARE FOR EXTENSION AND RECONNECTION UNDER THE SCOPE OF PROPOSED WORK. | YEZZI ASSOCIATES |
| | 8 REMOVE EXISTING PHONE JACK. INSTALL BLANK PLATE OVER EXISTING RECESSED ELECTRICAL/DATA BOX. | ARCHITECTURE |
| | 9 REMOVE EXISTING AUTOMATIC DOOR ACTUATOR PUSH-BUTTON. TERMINATE CONDUCTORS WITHIN THE RECESSED ELECTRICAL BOX AND INSTALL A BLANK COVER PLATE. | ENGINEERING INTERIORS MANAGEMENT |
| | 10 EXISTING LIGHT SWITCHES TO REMAIN | 18 Washington Street P.O. Box 1638 Toms River, N.J. 08754 |
| | $\left< 11 \right>$ EXISTING FIRE ALARM HORN/STROBE ASSEMBLY TO REMAIN | Tel: 732-240-3433 Fax: 732-240-3463 E-mail: info@yezziassociates.com |
| 71//2 | $\left< 12 \right>$ EXISTING FIRE ALARM PULL STATION TO REMAIN | Website: www.yezziassociates.com Massimo Francis Yezzi, Jr. |
| | $\left< 13 \right>$ EXISTING AUTOMATIC DOOR ACTUATOR PUSH BUTTON TO REMAIN | Architect No. C 7475 — NJ Planner No. 2368 — NJ |
| | $\langle 14 \rangle$ EXISTING EXIT SIGNS TO REMAIN | Architect No. 39914 — NCARB Architect No. 30262377 — AIA |
| | (15) EXISTING SMOKE DETECTOR TO REMAIN EXISTING LIGHT SWITCHES AND HOOP EXHAUST FAN SWITCH TO (16) REMAIN IN THEIR CURRENT LOCATION. REMOVE EXISTING TOGGLE SWITCHES AND INSTALL NEW TOGGLE SWITCHES (COLOR SELECTION BY) | Daniel M. Sernotti Architect No. 21Al01897900–NJ Architect No. S5–0008349–DE Architect No. RA 015346–GA Architect No. 73872–NCARB |
| | OWNER) $\langle 17 \rangle$ EXISTING KEY-OPERATED SWITCH WITH PILOT LIGHT TO REMAIN | LIDC |
| | $\left< \frac{18}{18} \right>$ EXISTING DUPLEX RECEPTACLE FOR REFRIGERATOR TO REMAIN | IINU |
| | EXISTING DUPLEX RECEPTACLE FOR MICROWAVE OVEN TO BE REMOVED. SAFE-OFF EXISTING CONDUCTORS AND PREPARE FOR EXTENSION AND RECONNECTION FOR NEW MICROWAVE OVEN UNDER THE SCOPE OF THE PROPOSED WORK. | HIGHLAND RESOURCE GROUP, LLC. 130 BORTONS ROAD, MARLTON, NJ 08053 WWW.HRGNJ.COM, V.856-404-0572, F.856-627-7886 CERTIFICATE OF AUTHORIZATION: #24GA28138200 MATTHEW DAVID WELLS, N.J.P.E. |
| | 20 EXISTING DUPLEX RECEPTACLES AT COUNTER-HEIGHT TO REMAIN IN THEIR EXISTING LOCATIONS. REMOVE EXISTING RECEPTACLE AND PREPARE FOR THE INSTALLATION OF NEW GFCI DUPLEX RECEPTACLES. (COLOR SELECTED BY OWNER) UNDER THE SCOPE OF THE PROPOSED | PROFESSIONAL ENGINEER, LIC. NO. 24GE04594000 |
| | WORK. REMOVE EXISTING ELECTRICAL CONNECTION FOR DISHWASHER. SAFE-OFF CONDUCTORS AND PREPARE FOR RECONNECTION TO NEW DISHWASHER UNDER THE SCOPE OF THE PROPOSED WORK. | SIGNATURE NOT VALID DATE WITHOUT RAISED SEAL |
| , | 22 REMOVE EXISTING ELECTRICAL CONNECTION FOR ELECTRIC RANGE. SAFE-OFF CONDUCTORS AND PREPARE FOR RECONNECTION TO NEW ELECTRIC RANGE UNDER THE SCOPE OF THE PROPOSED WORK. | |
| | 23 REMOVE EXISTING WALL-MOUNTED LIGHT FIXTURES. SAFE-OFF EXISTING CONDUCTORS AND PREPARE FOR EXTENSION AND RECONNECTION TO NEW CEILING-MOUNTED LIGHT FIXTURES TO BE INSTALLED UNDER THE SCOPE OF THE PROPOSED WORK. | |
| | 24 REMOVE EXISTING DATA/PHONE JACKS AND CABLE BACK TO NETWORK HUB. REMOVE RECESSED ELECTRICAL BOX. | s to ERSIT ENTIA R Galloway New Jerse |
| | REMOVE EXISTING DUPLEX RECEPTACLES. REMOVE ELECTRICAL CONDUCTORS BACK TO NEXT DEVICE ON THE CIRCUIT. RECONNECT CONDUCTORS TO MAINTAIN THE CONTINUITY OF THE CIRCUIT. | ONS TO VER IDEN Rewe |
| | 26 TEMPORARILY DE-ENERGIZE AND DISCONNECT 208V, 1-PHASE, 15A CIRCUIT TO AHU-6 PENDING EXTENSION AND RECONNECTION TO NEW AHU-6 DURING PROPOSED WORK. | RENOVATIONS V UNIVE RESIDI CENTER FARRIS DR. 0 |
| | REMOVE JUNCTION BOX FOR ROOF-MOUNTED LIGHT FIXTURE (MOUNTED TO ACCU-6) AND PERMANENTLY RELOCATE TO NEW UNI-STRUT SUPPORT FRAMEWORK. TEMPORARILY DE-ENERGIZE AND DISCONNECT 208V, 1-PAHSE, 20 AMP CIRCUIT TO ACCU-6 PENDING EXTENSION AND RECONNECTION TO NEW ACCU-6 UNDER THE SCOPE OF THE PROPOSED WORK. | PROPOSED R STOCKTON OWNSEND LIFE Atlantic county |
| | | |
| | | Project |
| | | Issued for Bid March 12, 2021 |
| | | O Revisions By Date |
| | | to start |
| | | s prior |
| | | Sheet Title |
| | | ELECTRICAL DEMOLITION WORK PLAN |
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Chk'd By


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Project No.

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YC20122

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PROPOSED WORK NOTES

- INSTALL NEW LIGHTING FIXTURE. EXTEND AND CONNECT POWER CIRCUIT CONDUCTORS REMAINING FROM REMOVAL OF EXISTING LIGHT FIXTURE (UNDER THE SCOPE OF THE DEMOLITION WORK). INSTALL NEW LIGHT SWITCH AND SWITCH LEG CONDÚCTORS. INSTALL NEW DUAL TECHNOLOGY OCCUPANCY SENSOR AS SHOWN.
- INSTALL NEW SMOKE DETECTOR. EXTEND AND CONNECT FIRE ALARM CIRCUIT WIRING TO NEAREST SIGNALING LINE CIRCUIT. REPROGRAM EXISTING FIRE ALARM SYSTEM FOR THE NEW DEVICE INSTALLED.
- INSTALL NEW RECEPTACLE CIRCUIT AS SHOWN (2)#12&(1)#12G TYPE MC CABLE. INSTALL NEW 20AMP, SINGLE POLE CIRCUIT BREAKER IN PANEL M-C1.
- INSTALL NEW GFCI DUPLEX RECEPTACLE (COLOR SELECTION BY OWNER). RECONNECT TO EXISTING POWER CIRCUIT.
- S PROVIDE NEW ELECTRICAL SERVICE FOR DISHWASHER. EXTEND AND CONNECT EXISTING POWER CIRCUIT CONDUCTORS REMAINING FROM REMOVAL OF EXISTING DISHWASHER UNDER SCOPE OF DEMOLITION WORK.
- PROVIDE NEW ELECTRICAL SERVICE FOR ELECTRIC RANGE.
 EXTEND AND CONNECT EXISTING POWER CIRCUIT CONDUCTORS REMAINING FROM REMOVAL OF EXISTING RANGE UNDER THE SCOPE OF THE DEMOLITION WORK.
- INSTALL NEW RECESSED LIGHT FIXTURE. EXTEND AND RECONNECT EXISTING POWER WIRING TO NEW LIGHT FIXTURE. INTEGRATE SWITCHING OF NEW LIGHT FIXTURE WITH THE SWITCHING OF THE EXISTING, EXTERIOR LIGHT FIXTURES.
- INSTALL NEW DUPLEX RECEPTACLE FOR AUTOMATIC DOOR ACTUATOR. EXTEND AND RECONNECT EXISTING POWER CIRCUIT.
- EXTEND AND RECONNECT EXISTING POWER CIRCUIT FOR THE NEW HYDRONIC CABINET UNIT HEATER. INSTALL NEW SAFETY DISCONNECT SWITCH. INSTALL NEW PILOT DUTY RELAY AND 24V CONTROL TRANSFORMER (PROVIDED BY MECHANICAL CONTRACTOR).
- PROVIDE NEW 100VA, 208V PRI/24V SEC CONTROL TRANSFORMER (WITH SEC CIRCUIT BREAKER) FOR AHU-6. PROVIDE NEW SAFETY DISCONNECT SWITCH FOR AHU-6. EXTEND AND RECONNECT EXISTING 208V, 1-PHASE, 15AMP POWER CIRCUIT TO AHU-6.
- PROVIDE ROOF-MOUNTED UNI-STRUT FRAME FOR MOUNTING EQUIPMENT DISCONNECT SWITCH AND JUNCTION BOXES. DO NOT MOUNT ANY EQUIPMENT ON THE HOUSING OF THE NEW ACCU-6. PROVIDE WEATHERPROOF EXTERIOR JUNCTION BOX AND EXTEND AND RECONNECT CIRCUIT FOR ROOF-MOUNTED LIGHT FIXTURE. PROVIDE NEW EXTERIOR, WEATHERPROOF DISCONNECT SWITCH FOR ACCU-6 (2-POLE, 30AMP, WITH 20AMP FUSES). EXTEND AND RECONNECT EXISTING 208V, 1-PHASE, 20AMP POWER CIRCUIT FOR ACCU-6.
- PROVIDE JUNCTION BOX WITH 120 VOLT, SINGLE PHASE, 20 AMP CIRCUIT FOR AUTOMATIC DOOR ACTUATOR. (2) #12 & (1) #12 G - TYPE MC CABLE. INSTALL NEW 20 AMP , SINGLE POLE CIRCUIT BREAKER IN PANEL M-C1. CIRCUIT TOGETHER WITH OTHER AUTOMATIC DOOR ACTUATORS. EXTEND CIRCUIT AND CONNECT TO DOOR ACTUATOR.

| | YEZZI ASSOCIATES | | | | | |
|--|---|--|--|--|--|--|
| | ARCHITECTURE PLANNING ENGINEERING INTERIORS MANAGEMENT 18 Washington Street P.O. Box 1638 Toms River, N.J. 08754 Tel: 732-240-3433 Fax: 732-240-3463 E-mail: info@yezziassociates.com Website: www.yezziassociates.com | | | | | |
| | Architect No. C 7475 -NJ Planner No. 2368 -NJ Architect No. 39914 -NCARB Architect No. 30262377 -AIA Daniel M. Sernotti Architect No. 21AI01897900-NJ Architect No. S5-0008349 -DE Architect No. RA 015346 -GA Architect No. 73872 -NCARB | | | | | |
| | Architect No. 73872 –NCARB | | | | | |
| | MATTHEW DAVID WELLS, N.J.P.E. PROFESSIONAL ENGINEER, LIC. NO. 24GE04594000 | | | | | |
| ction. | Project Proposed Renovations to STOCKTON UNIVERSITY TOWNSEND RESIDENTIAL LIFE CENTER 101 VERA KING FARRIS DR. GALLOWAY ATLANTIC COUNTY NEW JERSEY | | | | | |
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| check all dimensions prior to start of construction. | Revisions By Date Sheet Title ELECTRICAL PROPOSED WORK PLANS Drawn By | | | | | |
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| . Do Not Scale Drawings — Field check | E-2 Project No. YC20122 | | | | | |

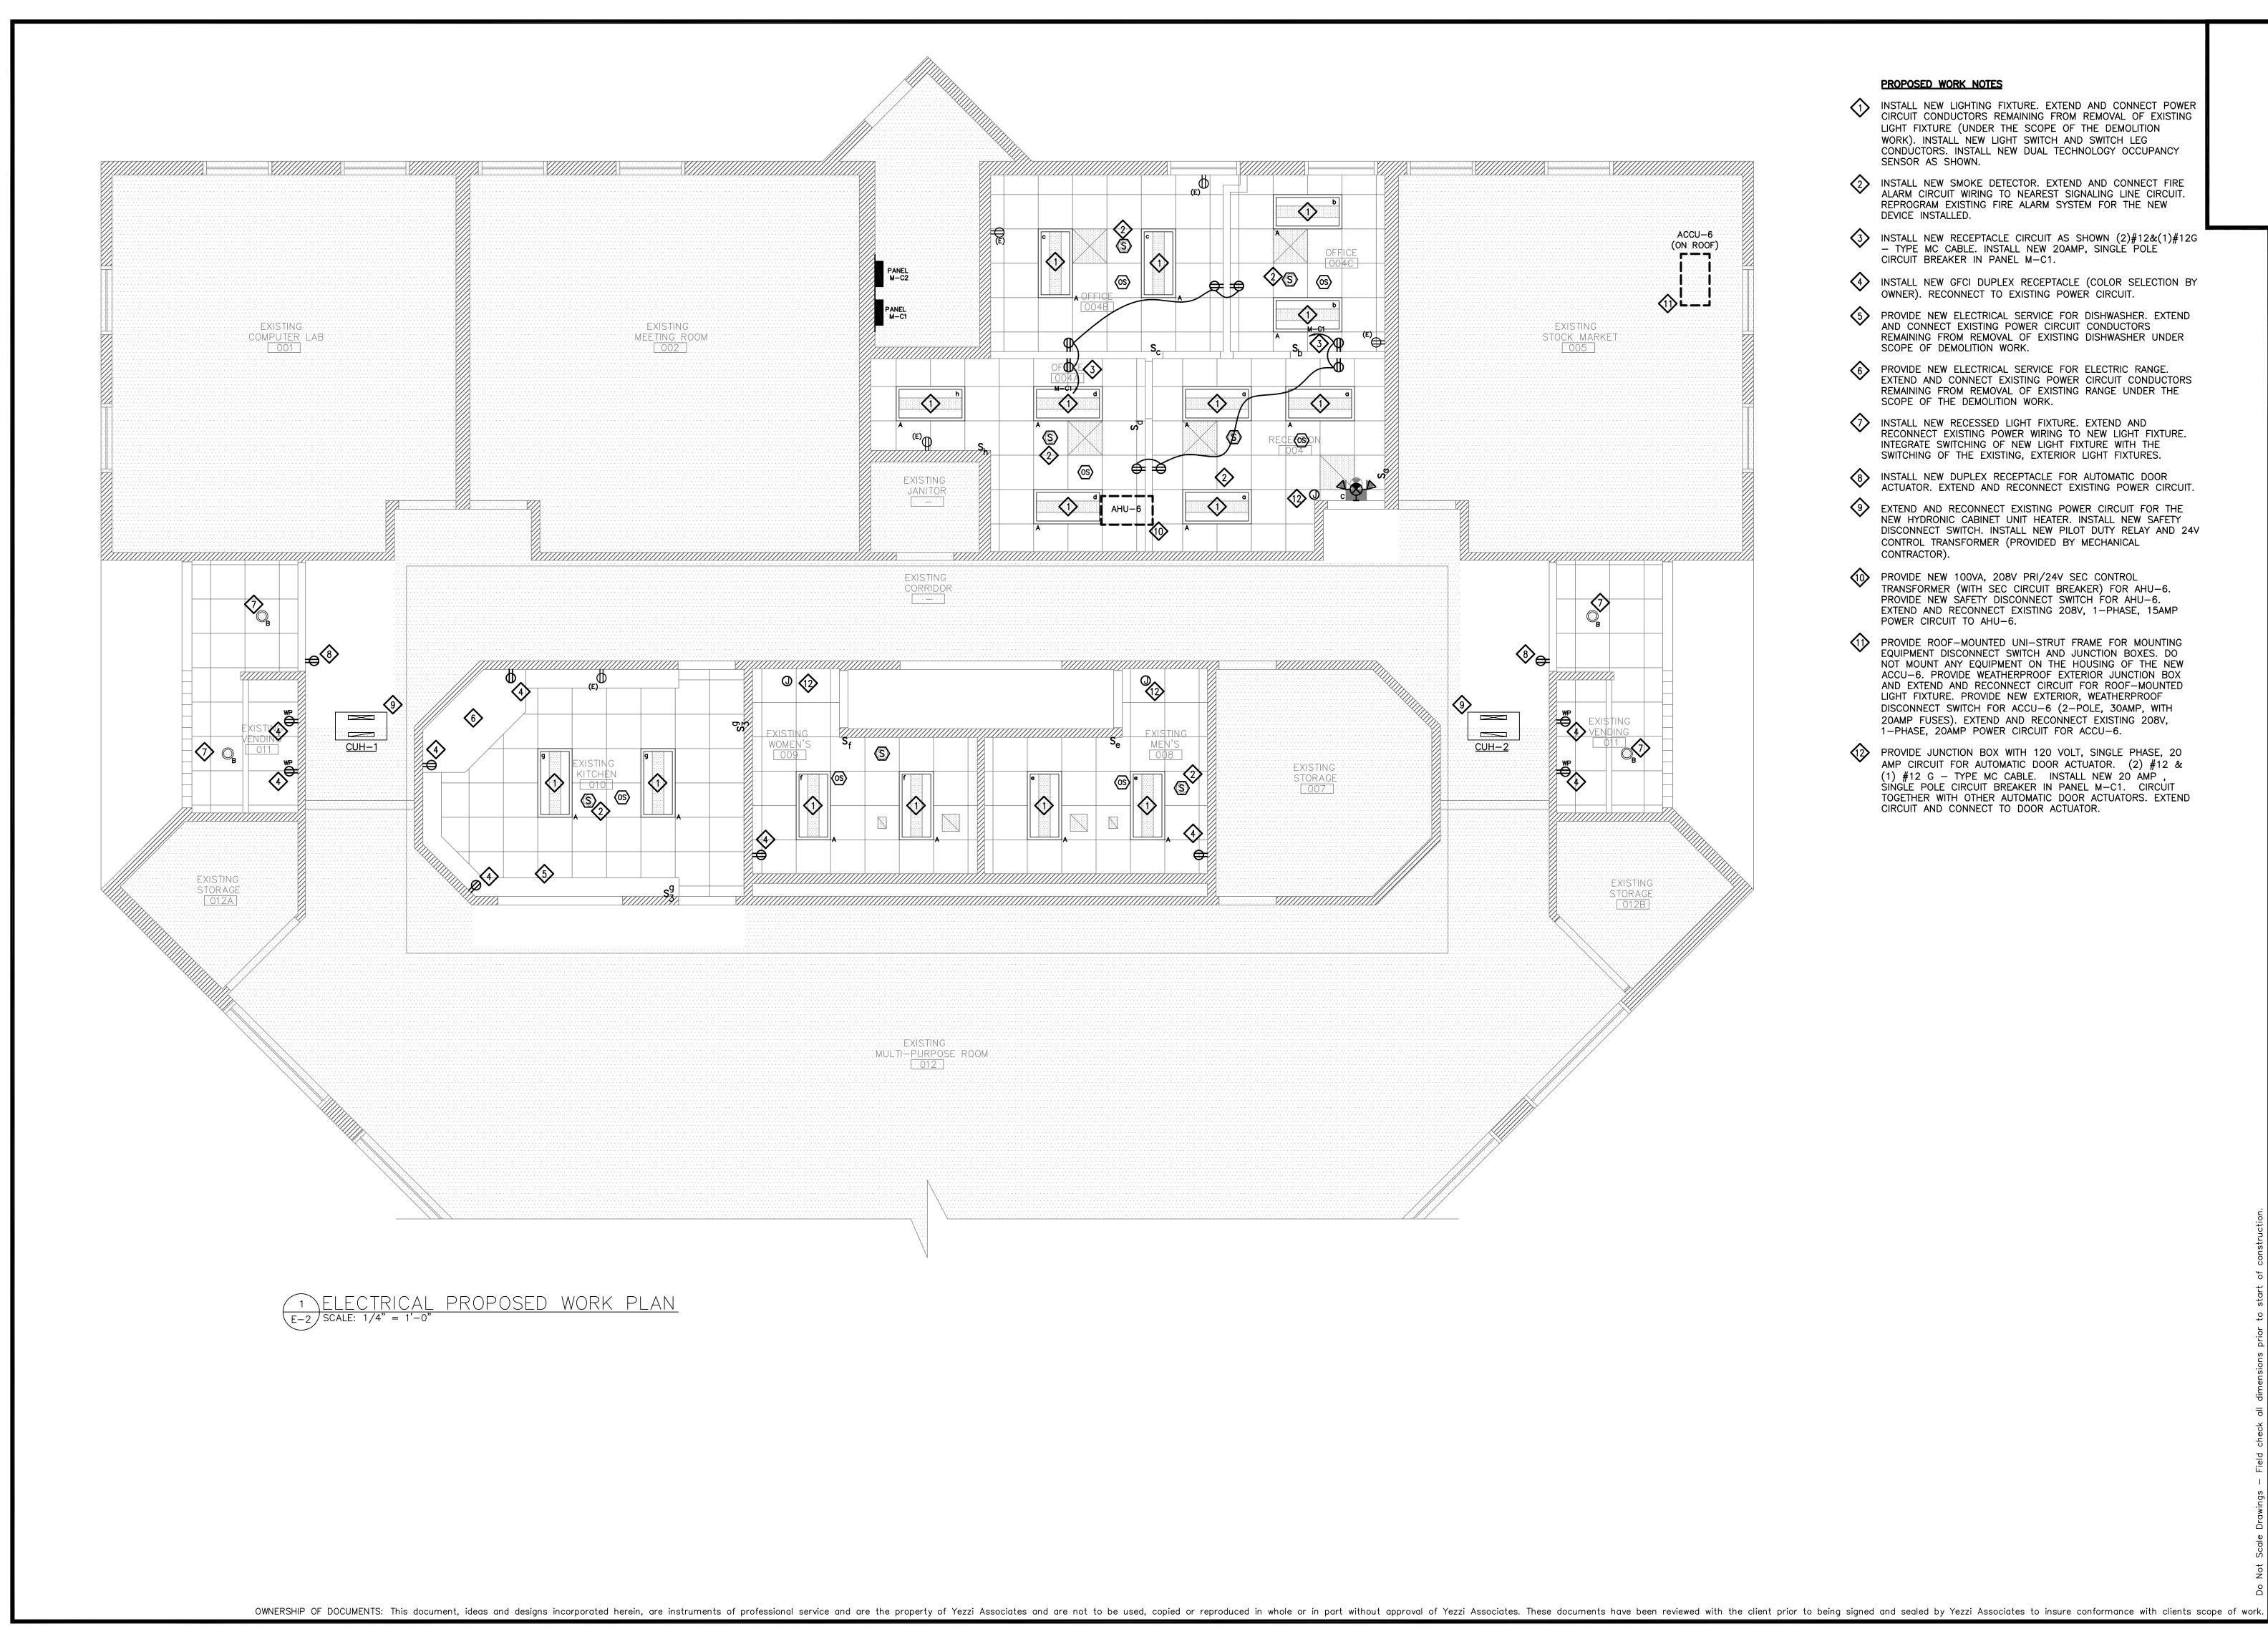PLUMBING NOTES

1. WORK IN THIS SECTION INCLUDES THE PROVIDING OF LABOR, MATERIALS, EQUIPMENT AND SERVICES NECESSARY FOR COMPLETE AND SAFE INSTALLATION IN ACCORDANCE WITH THE CONTRACT DOCUMENTS AND AUTHORITIES HAVING JURISDICTION.

2. DRAWINGS ARE DIAGRAMMATIC AND INDICATE GENERAL ARRANGEMENT OF SYSTEMS AND WORK. FOLLOW DRAWINGS IN LAYING OUT WORK AND CHECK DRAWINGS OF OTHER TRADES TO VERIFY SPACE CONDITIONS. MAINTAIN HEADROOM AND SPACE CONDITIONS.

3. SCALED AND FIGURED DIMENSIONS ARE APPROXIMATE AND ARE FOR ESTIMATING PURPOSES ONLY. BEFORE PROCEEDING WITH WORK, CHECK AND VERIFY ALL DIMENSIONS.

4. MAKE ADJUSTMENTS THAT MAY BE NECESSARY OR REQUIRED IN ORDER TO RESOLVE SPACE PROBLEMS.

5. ALL WORK SHALL BE PERFORMED IN ACCORDANCE WITH THE REQUIREMENTS OF THE NEW JERSEY UNIFORM CONSTRUCTION CODE AND ADOPTED (AS AMENDED) SUB CODES STANDARDS INCLUDING BUT NOT LIMITED TO THE FOLLOWING:

- INTERNATIONAL BUILDING CODE NEW JERSEY EDITION/ 2018;

- NAPHCC NATIONAL STANDARD PLUMBING CODE / 2018; - NFPA 70 NATIONAL ELECTRIC CODE / 2017;

- ASHRAE 90.1-2016 ENERGY CODE

- INTERNATIONAL MECHANICAL CODE / 2018; - INTERNATIONAL FUEL GAS CODE / 2018;

6. FURNISH ALL MATERIALS AND EQUIPMENT NEW, FREE FROM DEFECTS AND WITH MANUFACTURER'S WARRANTY.

7. ALL MATERIAL AND EQUIPMENT SHALL BE THE PRODUCT OF COMPANIES REGULARLY ENGAGED IN MANUFACTURING.

8. BEFORE SUBMITTING PROPOSAL THE CONTRACTOR SHALL VISIT AND CAREFULLY EXAMINE THOSE PORTIONS OF THE SITE AFFECTED BY THIS WORK SO AS TO FAMILIARIZE THEMSELVES WITH EXISTING CONDITIONS AND THE DIFFICULTIES ASSOCIATED WITH THE EXECUTION OF THE WORK. THESE DIFFICULTIES INCLUDE AVAILABILITY OF THE EQUIPMENT AND MATERIALS. REPORT IN WRITING ANY CONDITIONS WHICH MIGHT ADVERSELY AFFECT THEIR WORK.

9. NO CONSIDERATION OR ADDITIONAL PAYMENTS WILL BE GRANTED FOR ANY ALLEGED MISUNDERSTANDING OF THE MATERIALS TO BE FURNISHED OR WORK TO BE DONE, IT BEING UNDERSTOOD THAT THE SUBMISSION OF A PROPOSAL IS AN AGREEMENT TO ALL CONDITIONS REFERRED TO HEREIN OR INDICATED ON THE PLANS.

10. COORDINATE WITH OWNER AND GENERAL CONTRACTOR SCHEDULING OF ALL WORK SUCH THAT ANY REQUIRED OVERTIME IS INCLUDED AT NO ADDITIONAL COST.

11. PROVIDE THREE SETS OF OPERATION AND MAINTENANCE MANUALS COVERING ALL INSTALLED EQUIPMENT ITEMS TO THE OWNER. THE O&M MANUALS SHALL ALSO INCLUDE AS-BUILT DRAWINGS AND TESTING DATA.

12. THE CONTRACTOR SHALL LABEL ALL PIPING AND EQUIPMENT.

13. AS A PART OF THIS CONTRACT, ALL WORK AND EQUIPMENT FURNISHED AND INSTALLED SHALL BE COVERED UNDER A FULL ONE YEAR GUARANTEE. THE WARRANTY SHALL COMMENCE ON THE DATE OF THE OWNER'S FINAL ACCEPTANCE.

14. IT IS NOT INTENDED THAT THE PLANS OR SPECIFICATIONS SHOW OR STATE EVERY DETAILED REQUIREMENT OF THE WORK, BUT RATHER THAT THEY FURNISH ADEQUATE INFORMATION FOR THE CONTRACTOR TO MAKE COMPLETELY APPROVED INSTALLATION.

15. CONTRACTOR SHALL BE RESPONSIBLE FOR REPAIRING OR REPLACING, WITHOUT ADDITIONAL CHARGE, ANY EXISTING WORK DAMAGED BY HIM DURING THE COURSE OF THIS CONSTRUCTION.

16. CONTRACTOR SHALL LEAVE ALL SYSTEMS IN PROPER WORKING ORDER AND SHALL, WITHOUT ADDITIONAL CHARGE, REPLACE ANY WORK, MATERIALS, OR EQUIPMENT FURNISHED AND INSTALLED BY HIM UNDER HIS CONTRACT WHICH DEVELOPS DEFECTS, EXCEPT FROM ORDINARY WEAR AND TEAR, WITHIN ONE (1) YEAR FROM THE DATE OF FINAL ACCEPTANCE BY THE OWNER.

17. THE CONTRACTOR SHALL DETERMINE THE TYPE, SIZE AND QUANTITY OF SEISMIC PROTECTION DEVICES, HANGERS AND BRACING NECESSARY TO MEET THE CODE REQUIRED SEISMIC REQUIREMENTS FOR ALL MECHANICAL, ELECTRICAL AND PLUMBING SYSTEM/COMPONENTS. WHERE MORE THAN ONE REGULATION APPLIES, THE STRICTER ONE SHALL GOVERN.

18. THE CONTRACTOR SHALL SUBMIT SHOP DRAWINGS FOR ALL MAJOR MANUFACTURED ITEMS REQUIRED ON THIS PROJECT. A MINIMUM OF (6) COPIES SHALL BE SUBMITTED. PURCHASE OR INSTALLATION OF EQUIPMENT OR SYSTEM COMPONENTS PRIOR TO APPROVAL OF SHOP DRAWINGS IS FORBIDDEN. APPROVAL OF SHOP OR SETTING DRAWINGS SHALL ONLY BE CONSTRUED TO APPLY TO GENERAL LAYOUT AND CONFORMANCE TO THE DESIGN CONCEPT OF THE PROJECT AND FOR COMPLIANCE WITH THE GENERAL REQUIREMENTS OF THE CONTRACT DOCUMENTS. THE RESPONSIBILITY FOR ANY DEVIATION FROM THE REQUIREMENTS OF THE CONTRACT DOCUMENTS SHALL REMAIN THE CONTRACTOR'S UNLESS HE HAS, IN WRITING, SPECIFICALLY CALLED ATTENTION TO SUCH DEVIATIONS AT THE TIME OF SUBMISSION AND HAS RECEIVED WRITTEN APPROVAL OF SUCH DEVIATIONS FROM THE OWNER.

19. ALL EQUIPMENT SHALL BE INSTALLED IN STRICT COMPLIANCE WITH MANUFACTURERS WRITTEN INSTALLATION INSTRUCTIONS.

20. CONTRACTOR SHALL PROVIDE ALL MISCELLANEOUS STEEL SHAPES, HANGER RODS, STRAPS, ETC. REQUIRED FOR ALL SYSTEM INSTALLATIONS. PROVIDE ALL SEISMIC RESTRAINTS AS REQUIRED BY THE INTERNATIONAL BUILDING CODE.

21. PROVIDE ALL CUTTING AND PATCHING AS REQUIRED. COORDINATE THIS WORK WITH THE GENERAL CONTRACTOR.

22. SEAL ALL EXTERIOR WALL PENETRATIONS WEATHER TIGHT. PROVIDE FIRE RATED SLEEVES AT ALL FIRE WALL PENETRATIONS AND SEAL AROUND ALL PIPE WITH FIRE STOP SEALANT. COORDINATE PENETRATIONS AND FIRE STOPPING WITH THE GENERAL CONTRACTOR AND/OR CONSTRUCTION MANAGER.

23. AT THE COMPLETION OF CONSTRUCTION, THE CONTRACTOR SHALL PROVIDE TO THE OWNER COMPLETE AND ACCURATE "AS CONSTRUCTED DOCUMENTATION" FOR ALL SYSTEMS INSTALLED OR ALTERED UNDER THIS CONTRACT.

24. CONTRACTOR SHALL BE RESPONSIBLE TO APPLY FOR AND PROCURE ALL REQUIRED PERMITS, CERTIFICATES AND AGENCY APPROVALS. ALL DOCUMENTS REQUIRED IN ADDITION TO THE CONTRACT DOCUMENTS SHALL BE PROVIDED BY THE CONTRACTOR. PROVIDE COPIES OF ALL REQUIRED CERTIFICATIONS AND APPROVALS TO THE OWNER.

25. ALL WORK SHALL BE PERFORMED IN A WORKMANLIKE AND PROFESSIONAL MANNER CONSISTENT WITH ALL APPLICABLE INDUSTRY STANDARDS. SYSTEM INSTALLATIONS SHALL CONFORM WITH ALL APPLICABLE INDUSTRY STANDARDS.

26. CONTRACTOR SHALL MAKE TESTS AT HIS OWN EXPENSE, AS REQUIRED BY OWNER AND/OR ANY INSPECTION DEPARTMENT. TEST SHALL BE MADE TO VERIFY WHETHER THE SYSTEM AND EQUIPMENT INSTALLED COMPLY WITH THE SPECIFICATIONS AND ARE IN PROPER WORKING ORDER.

27. ALL PIPING SHALL BE PROTECTED FROM FREEZING.

28. THE CONTRACTOR SHALL PROVIDE PRESSURE REDUCING VALVES AS REQUIRED PER THE 2006 NATIONAL STANDARD PLUMBING CODE.

29. THE COLOR OF ALL PLUMBING FIXTURES SHALL BE SELECTED BY THE ARCHITECT.

30. THIS CONTRACTOR SHALL PROVIDE AND INSTALL ALL GAS PIPING.

31. ALL HOT AND COLD WATER PIPING SHALL BE TYPE "L" HARD DRAWN COPPER. (CUL)

32. ALL EXPOSED COLD AND HOT WATER PIPING AND WASTE PIPING INCLUDING THE "P" TRAP LOCATED UNDER HANDICAPPED LAVATORIES SHALL BE INSULATED WITH TRUEBRO "HANDI-GUARD" PIPE INSULATION KIT MODEL 102.

33. ALL CEILING HEIGHTS TO BE MAINTAINED (NO EXCEPTIONS). REFER TO ARCHITECTURAL DRAWINGS FOR CEILING HEIGHTS.

34. ALL PLUMBING COMPONENTS, SYSTEMS AND THEIR ATTACHMENTS SHALL BE INSTALLED AND CONSTRUCTED TO RESIST THE ULTIMATE STRENGTH LOADS AND STORY DRIFT EFFECTS OF EARTHQUAKE MOTION IN ACCORDANCE WITH THE INTERNATIONAL BUILDING CODE 2018.

| PLUMBING | FIX |
|----------|-----|
| MARK | |

| MANUFACTURER |
|-----------------------------|
| MODEL NUMBER |
| WASTE SIZE (IN.) |
| VENT SIZE (IN.) |
| COLD WATER SIZE (IN.) |
| HOT WATER SIZE (IN.) |
| DRAINAGE FIXTURE UNIT (DFU) |
| SUPPLY FIXTURE UNIT (WSFU) |
| ACCESSORIES AND REMARKS |
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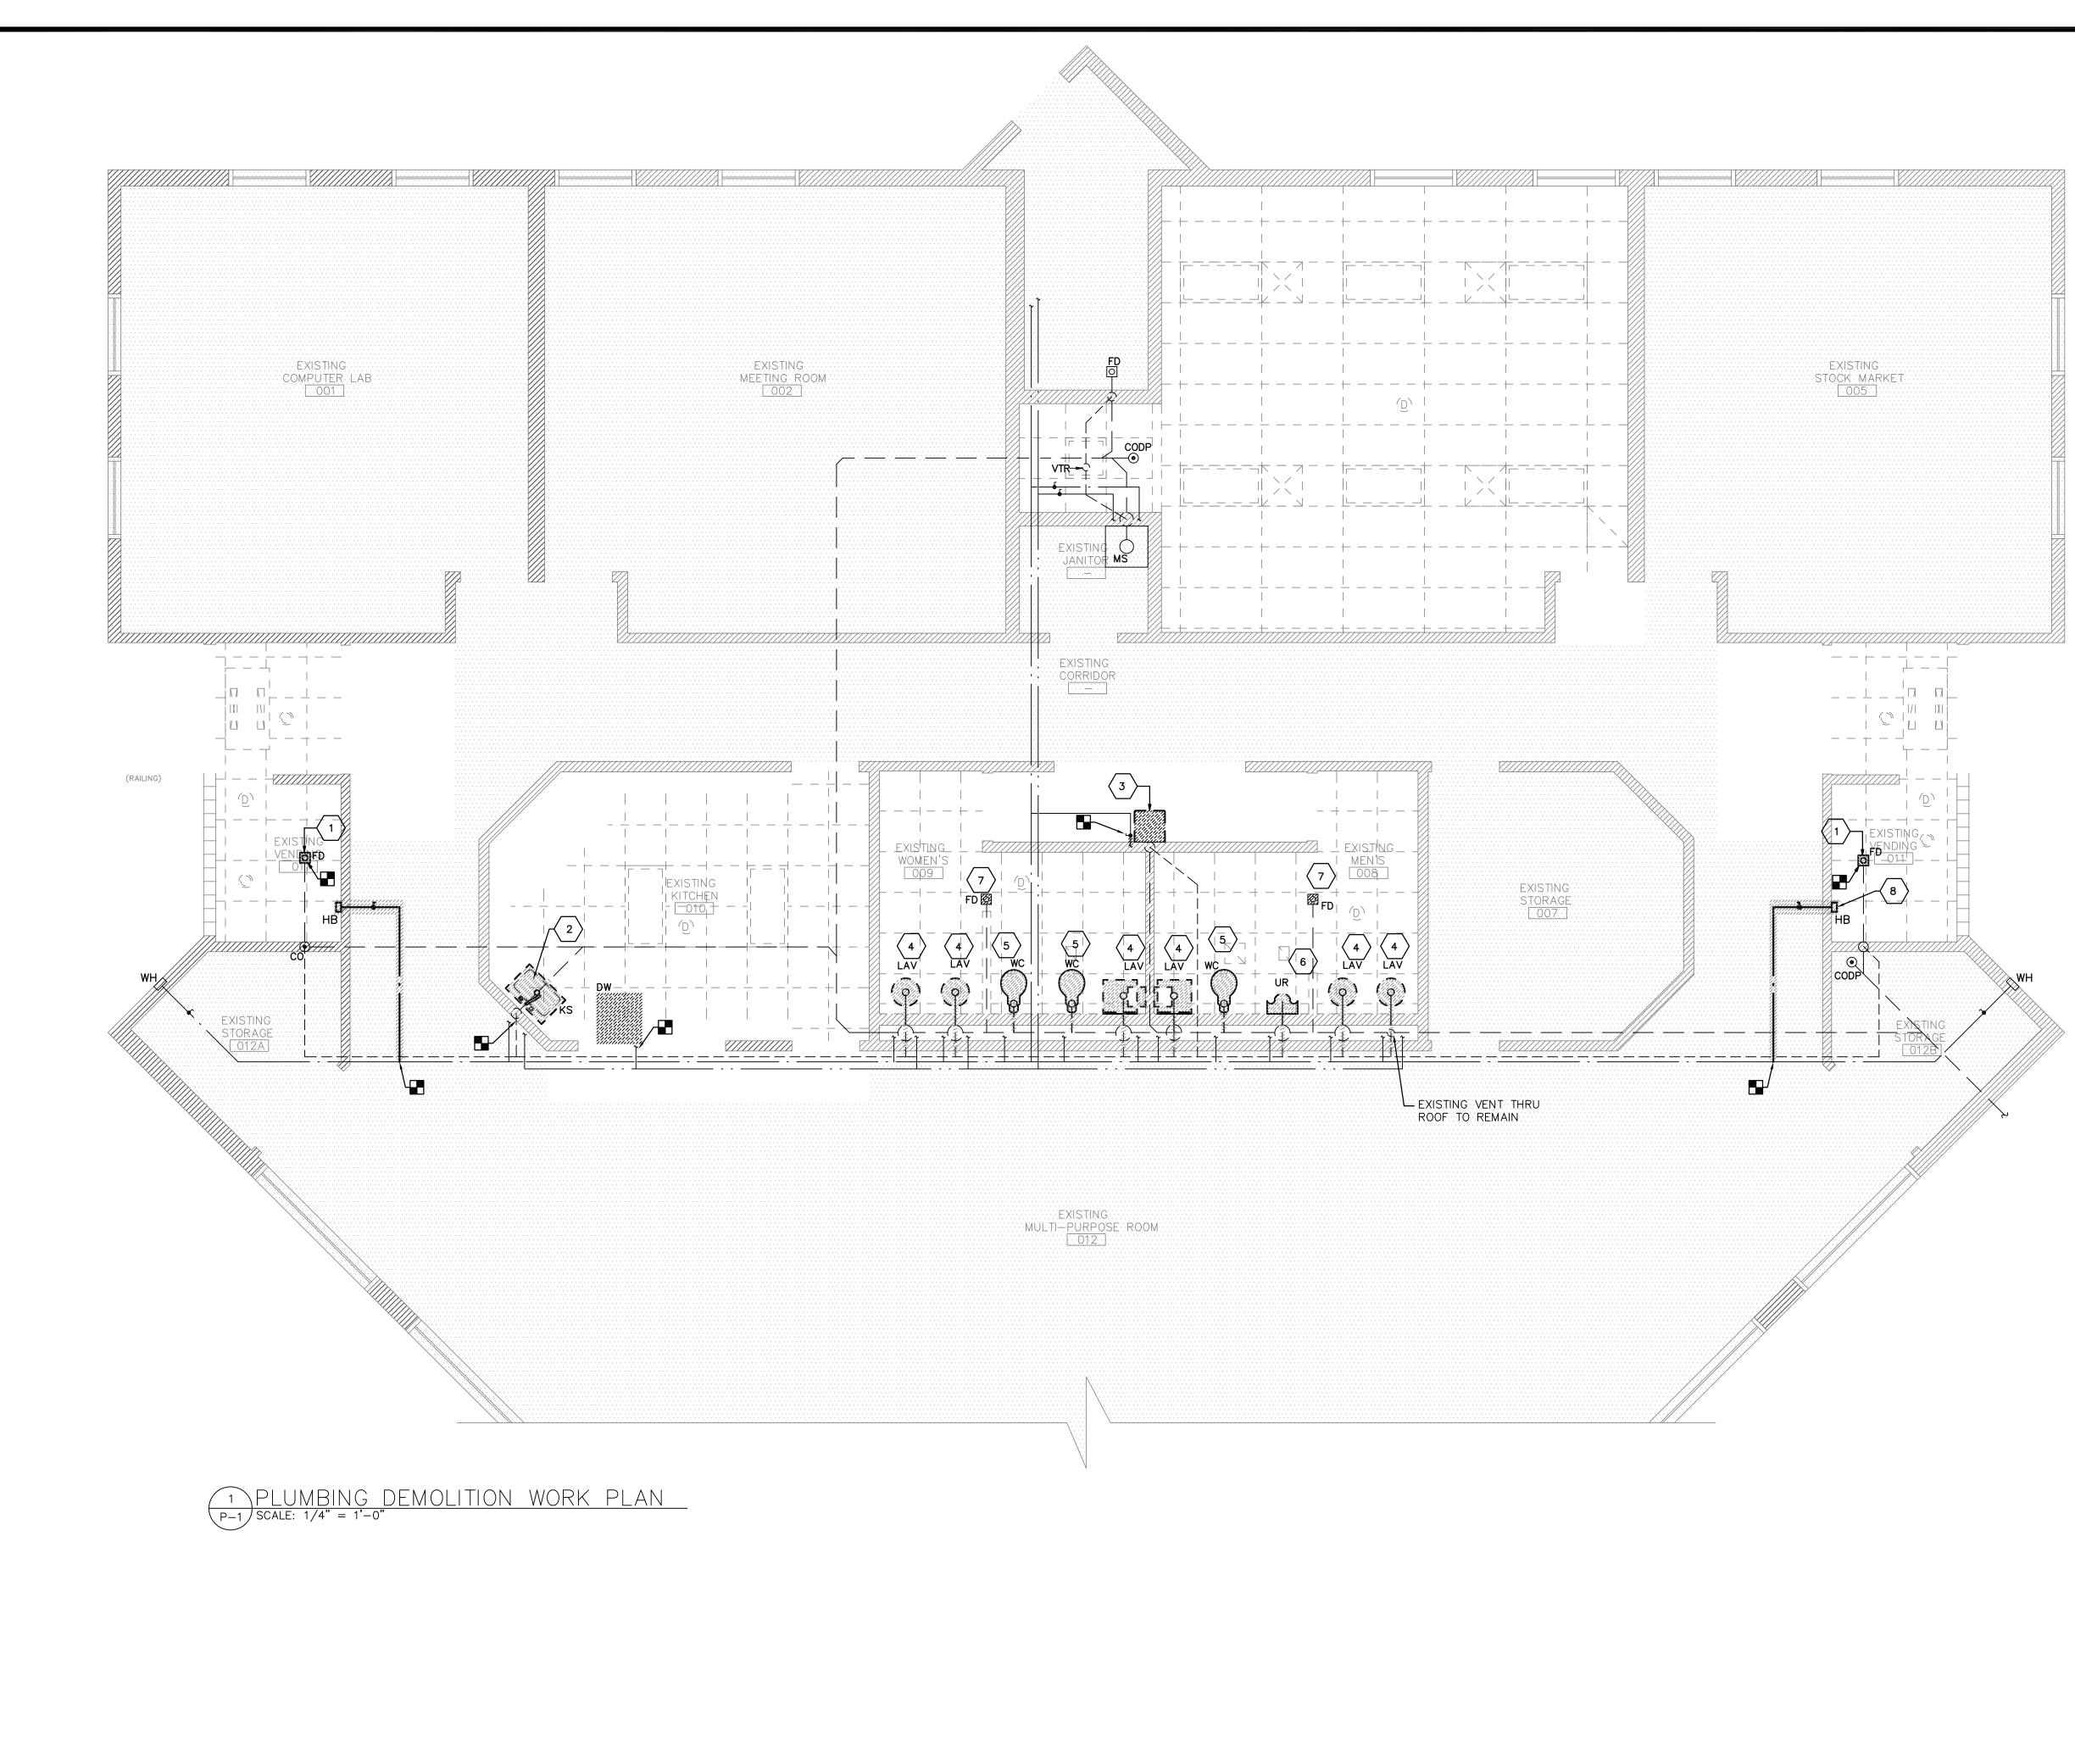
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|----|---|--|--|---|--|---|---|--|
| | WATER CLOSET | LAVATORY | DRINKING FOUNTAIN | URINAL | FLOOR DRAIN | WALL CLEANOUT | WATER HAMMER ARRESTER | SINK |
| | AMERICAN STANDARD | AMERICAN STANDARD | ELKAY | AMERICAN STANDARD | ZURN | ZURN | ZURN WILKENS | ELKAY |
| | 2257.101 | 9482.00 | EMABFT8WSLK | 6590.001 | Z415S | Z1445-NH | 1260XL | LR1919 |
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| | FLOOR-MOUNTED, ADA HEIGHT ELONGATED, TOP SPUD. PROVIDE BEMIS #1055 SEAT AND SLOAN FLUSH VALVE #111-1.28 ES-5,1.28 GAL/FLUSH,SWEAT SOLDER KIT,CAST WALL FLANGED, BUMPER ON ANGLE STOP. | PROVIDE SLOAN FAUCET ETF-600-B-BDT | BOTTLE FILLING STATION WITH BI-LEVEL ADA COOLER | TOP SPUD, 0.5 GPF. PROVIDE SLOAN FLUSH VALVE #186-0.5 ESS | ROUND TOP FLOOR DRAIN WITH ADJUSTABLE STRAINER HEAD, NICKEL BRONZE TOP. | PROVIDE ZURN Z51468-VP ACCESS COVER AND PLUG. | INSTALL IN ACCORDANCE WITH MANUFACTURER'S RECOMMENDATIONS. | STAINLESS STEEL COUNTER-MOUNT SINK. PROVIDE ZURN MODEL Z831C4-XL WITH SWING GOOSENEC SPOUTM WRIST BALDE HANDLES AND OFFSET (AD. COMPLIANT) GRID DRAIN. |

BING SYMBOL LIST

| COLD WATER PIPING |
|--|
| HEAT TRACE DOMESTIC WATER PIPING |
| HEAT TRACE DOMESTIC WATER PIPING HOT WATER PIPING |
| HOT WATER RETURN PIPING |
| |
| EXISTING SANITARY SEWER & WASTE PIPING BELOW GRADE |
| NATURAL GAS PIPING |
| |
| SANITARY LINE ABOVE GRADE/FLOOR |
| SANITARY LINE BELOW GRADE/FLOOR |
| RAIN WATER/STORM PIPING BELOW GRADE/FLOOR |
| RAIN WATER/STORM PIPING ABOVE GRADE/FLOOR |
| CONTINUATION |
| PIPE DOWN |
| PIPE UP |
| PIPE CAPPED |
| PIPE, TOP CONNECTION |
| PIPE, BOTTOM CONNECTION |
| BALL VALVE |
| CHECK VALVE |
| GATE VALVE |
| TWO WAY CONTROL VALVE |
| DIRECTION OF FLOW |
| PLUG VALVE |
| SANITARY TRAP |
| FLOOR DRAIN (AS SPECIFIED) |
| CLEAN OUT |
| CLEAN OUT |
| HOSE BIBB, WALL HYDRANT (AS SPECIFIED) |
| RAIN WATER LEADER NUMBER |
| VENT STACK NUMBER |
| SAN STACK NUMBER |
| SHOCK ABSORBER |
| TEMPERATURE MIXING VALVE |
| NEW TO EXISTING |
| POINT OF DEMOLITION OF EXISTING |
| |

ABBREVIATIONS


| | YEZZI ASSOCIATES |
|---|---|
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| | Massimo Francis Yezzi, Jr.Architect No. C 7475-NJPlanner No. 2368-NJArchitect No. 39914-NCARBArchitect No. 30262377-AIADaniel M. SernottiArchitect No. 21AI01897900-NJArchitect No. S5-0008349-DEArchitect No. RA 015346-GAArchitect No. 73872-NCARB |
| | HIGHLAND RESOURCE GROUP, LLC. 130 BORTONS ROAD, MARLTON, NU 08053 WWW.HRGNJ.COM, V.856-404-0572, F.856-627-7886 CERTIFICATE OF AUTHORIZATION: #24GA28138200 MATTHEW DAVID WELLS, N.J.P.E. |
| | PROFESSIONAL ENGINEER, LIC. NO. 24GE04594000 SIGNATURE NOT VALID DATE WITHOUT RAISED SEAL |
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DEMOLITION WORK NOTES

- 1 REMOVE EXISTING FLOOR DRAIN, INCLUDING TRAP. TEMPORARILY CAP PIPING, IN PREPARATION FOR THE INSTALLATION OF A NEW CLEAN-OUT UNDER THE SCOPE OF THE PROPOSED WORK.
- 2 REMOVE KITCHEN SINK, FAUCET, DISHWASHER DRAIN LINE, AND PORTIONS OF SANITARY AND VENT PIPING SHOWN. TEMPORARILY CAP SANITARY AND VENT PIPING, IN PREPARATION FOR NEW CONNECTIONS UNDER THE SCOPE OF THE PROPOSED WORK. TEMPORARILY CAP DOMESTIC HOT AND COLD WATER PIPING IN PREPARATION FOR RECONNECTION UNDER THE SCOPE OF PROPOSED WORK.
- 3 REMOVE EXISTING DRINKING FOUNTAIN. CAP EXISTING DRAIN AND VENT LINES IN PREPARATION FOR CONNECTION TO NEW DRINKING FOUNTAIN UNDER THE SCOPE OF THE PROPOSED WORK. TEMPORARILY CAP DOMESTIC COLD WATER PIPING IN PREPARATION FOR RECONNECTION UNDER THE SCOPE OF PROPOSED WORK.
- 4 REMOVE EXISTING COUNTER-MOUNTED LAVATORY OR WALL MOUNTED LAVATORY AND FAUCET, INCLUDING PORTIONS OF SANITARY DRAIN AND VENT PIPING SHOWN. CAP VENT PIPING AT EXISTING VENT MANIFOLD. CAP UNDERFLOOR SANITARY LATERAL AT CONNECTION TO SANITARY MAIN. TEMPORARILY CAP DOMESTIC HOT AND COLD WATER PIPING IN PREPARATION FOR RECONNECTION UNDER THE SCOPE OF PROPOSED WORK.
- 5 REMOVE EXISTING FLOOR-MOUNTED WATER CLOSET AND FLUSH VALVE, INCLUDING PORTIONS OF SANITARY PIPING SHOWN. CAP UNDERFLOOR SANITARY LATERAL AT CONNECTION TO SANITARY MAIN. TEMPORARILY CAP DOMESTIC COLD WATER PIPING IN PREPARATION FOR RECONNECTION UNDER THE SCOPE OF THE PROPOSED WORK.
- 6 REMOVE EXISTING WALL MOUNTED URINAL AND FLUSH VALVE, INCLUDING PORTIONS OF SANITARY VENT PIPING SHOWN. CAP UNDERFLOOR SANITARY LATERAL AT CONNECTION TO SANITARY MAIN. TEMPORARILY CAP DOMESTIC COLD WATER PIPING IN PREPARATION FOR RECONNECTION UNDER THE SCOPE OF THE PROPOSED WORK.
- 7 REMOVE EXISTING FLOOR DRAIN. TEMPORARILY CAP UNDERFLOOR SANITARY LATERAL IN PREPARATION FOR INSTALLATION OF NEW FLOOR DRAIN AND RECONNECTION UNDER THE SCOPE OF THE PROPOSED WORK.
- 8 REMOVE EXISTING HOSE BIB AND EXISTING DOMESTIC COLD WATER PIPING BACK TO THE COLD WATER MAIN. PERMANENTLY CAP BRANCH PIPING.

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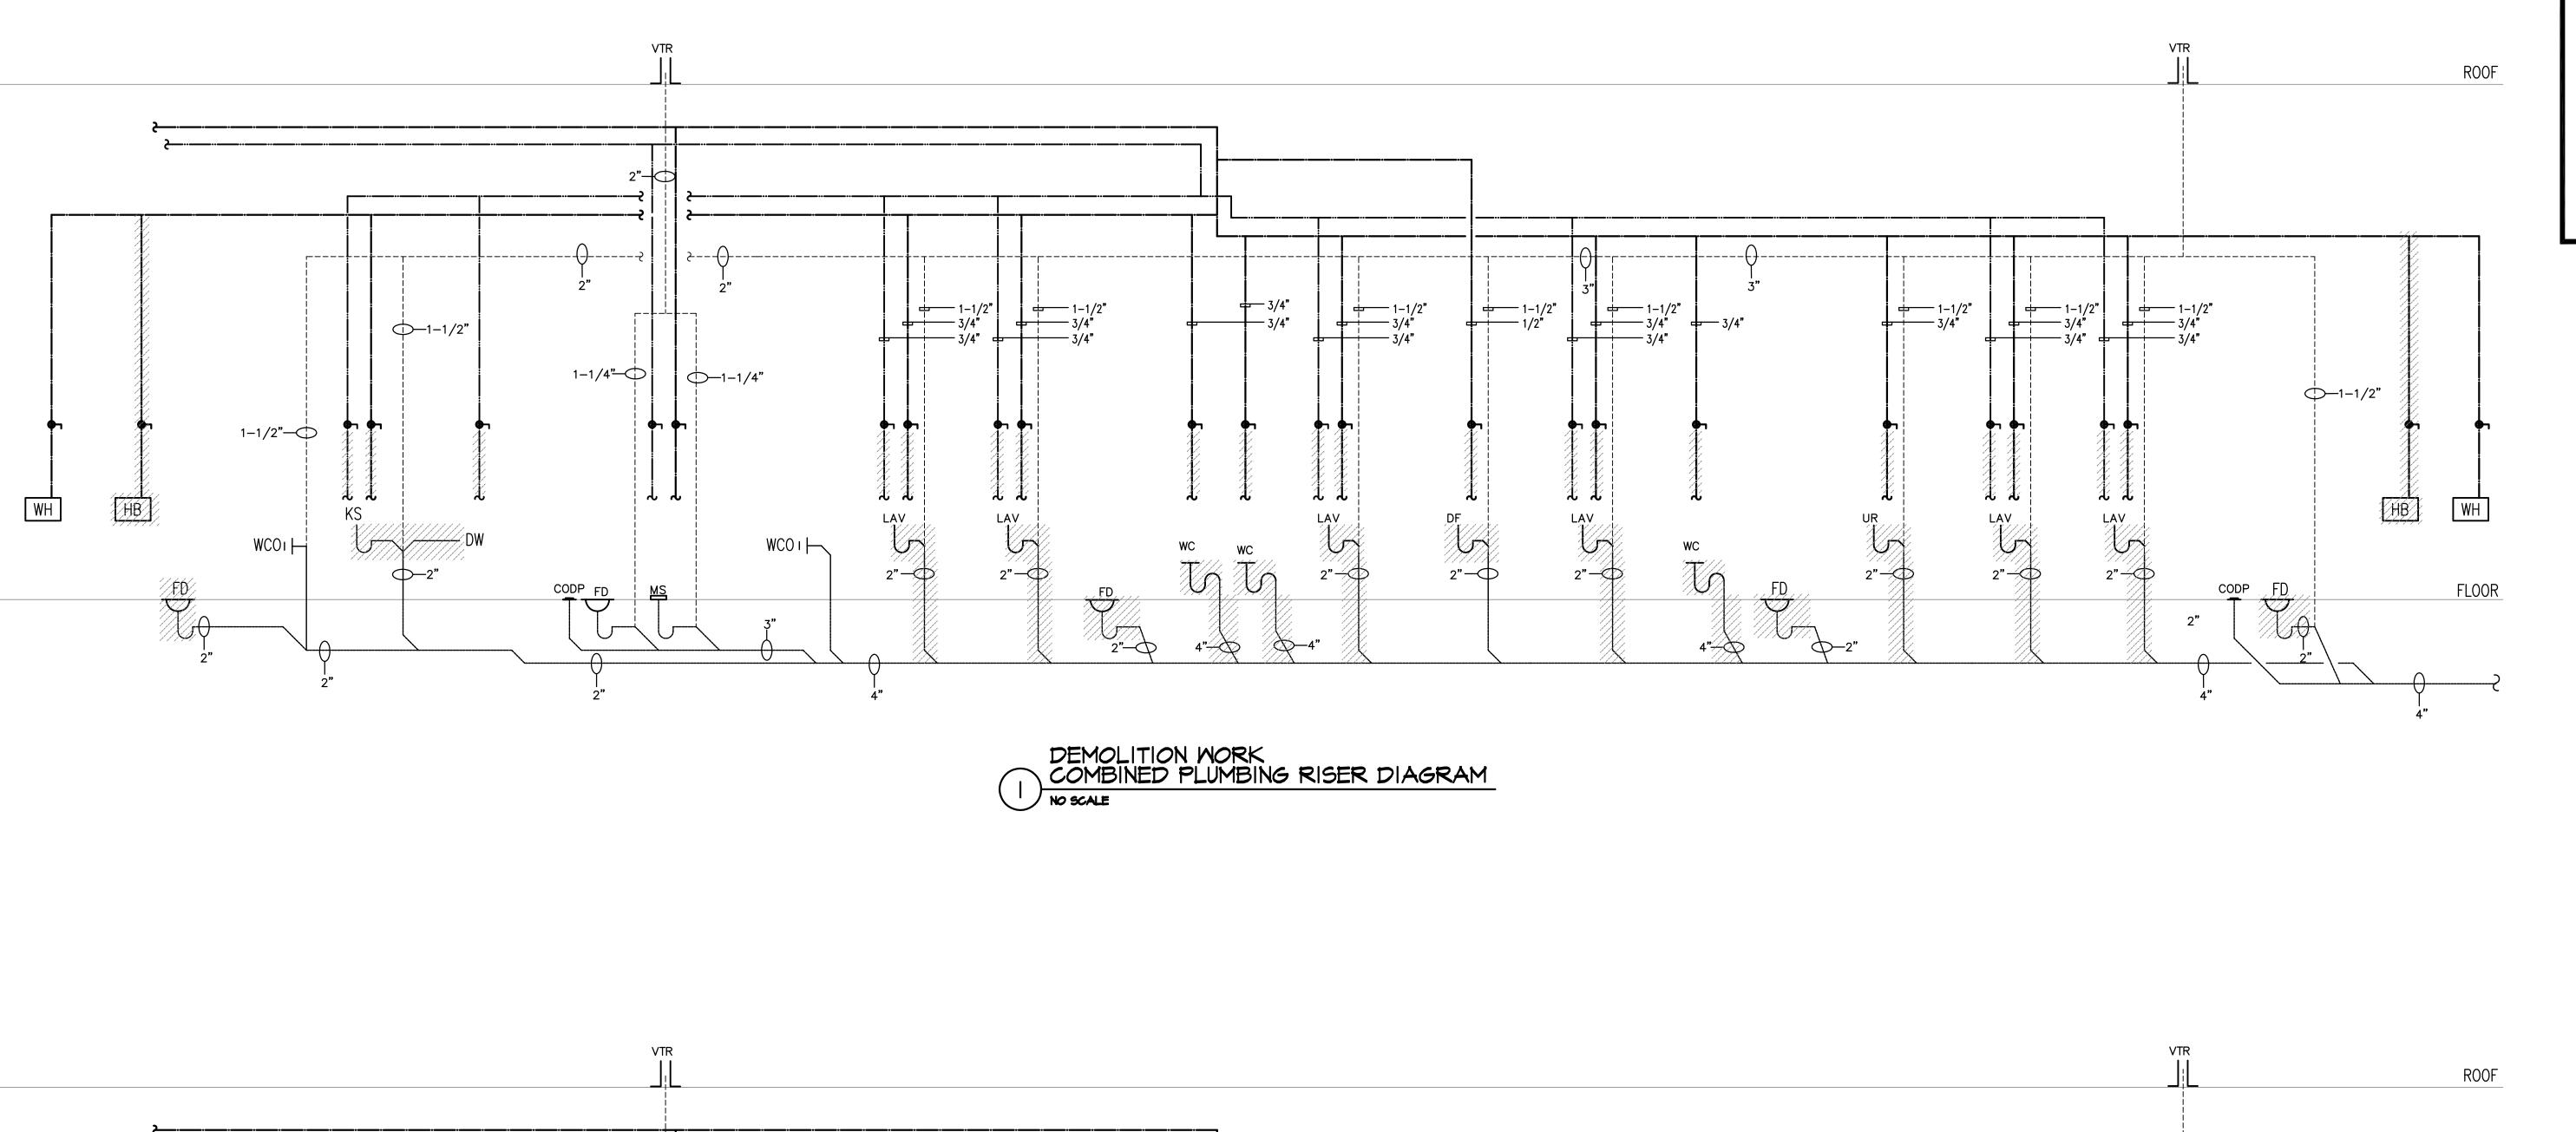



PROPOSED WORK NOTES

- INSTALL NEW CLEAN OUT DECK PLATE. EXTEND EXISTING UNDER-FLOOR SANITARY PIPING AND CONNECT TO NEW CLEAN-OUT $\langle 1 \rangle$
- 2 EXTEND EXISTING 1/2" DOMESTIC HOT WATER LINE AND CONNECT TO NEW DISHWASHER. INSTALL NEW BALL VALVE FOR ISOLATION DUTY.
- 3 INSTALL NEW DRINKING FOUNTAIN. EXTEND AND RECONNECT EXISTING 1/2" DOMESTIC COLD WATER LINE, 1–1/2" VENT LINE AND 2" DRAIN LINE.
- 4 INSTALL NEW LAVATORY AND FAUCET. EXTEND AND RECONNECT EXISTING 1/2" DOMESTIC COLD AND HOT WATER LINE, 1-1/2" VENT LINE, AND 2" DRAIN LINE.
- INSTALL NEW FLOOR-MOUNTED WATER CLOSET AND FLUSH VALVE. EXTEND AND RECONNECT EXISTING 1" DOMESTIC COLD WATER LINE AND 4" UNDER FLOOR SANITARY LATERAL.
- 6 INSTALL NEW WALL-MOUNTED URINAL. EXTEND AND RECONNECT EXISTING 3/4" DOMESTIC COLD WATER LINE AND 2" DRAIN LINE.
- (7) INSTALL NEW FLOOR DRAIN. EXTEND AND RECONNECT 2" UNDER FLOOR SANITARY DRAIN LINE.
- 8 EXTEND AND RECONNECT EXISTING 1/2" DOMESTIC HOT AND COLD WATER LINES TO NEW KITCHEN SINK.
- 9 EXTEND AND RECONNECT EXISTING 1-1/2" VENT LINE AND 2" SANITARY DRAIN LINE TO NEW KITCHEN SINK

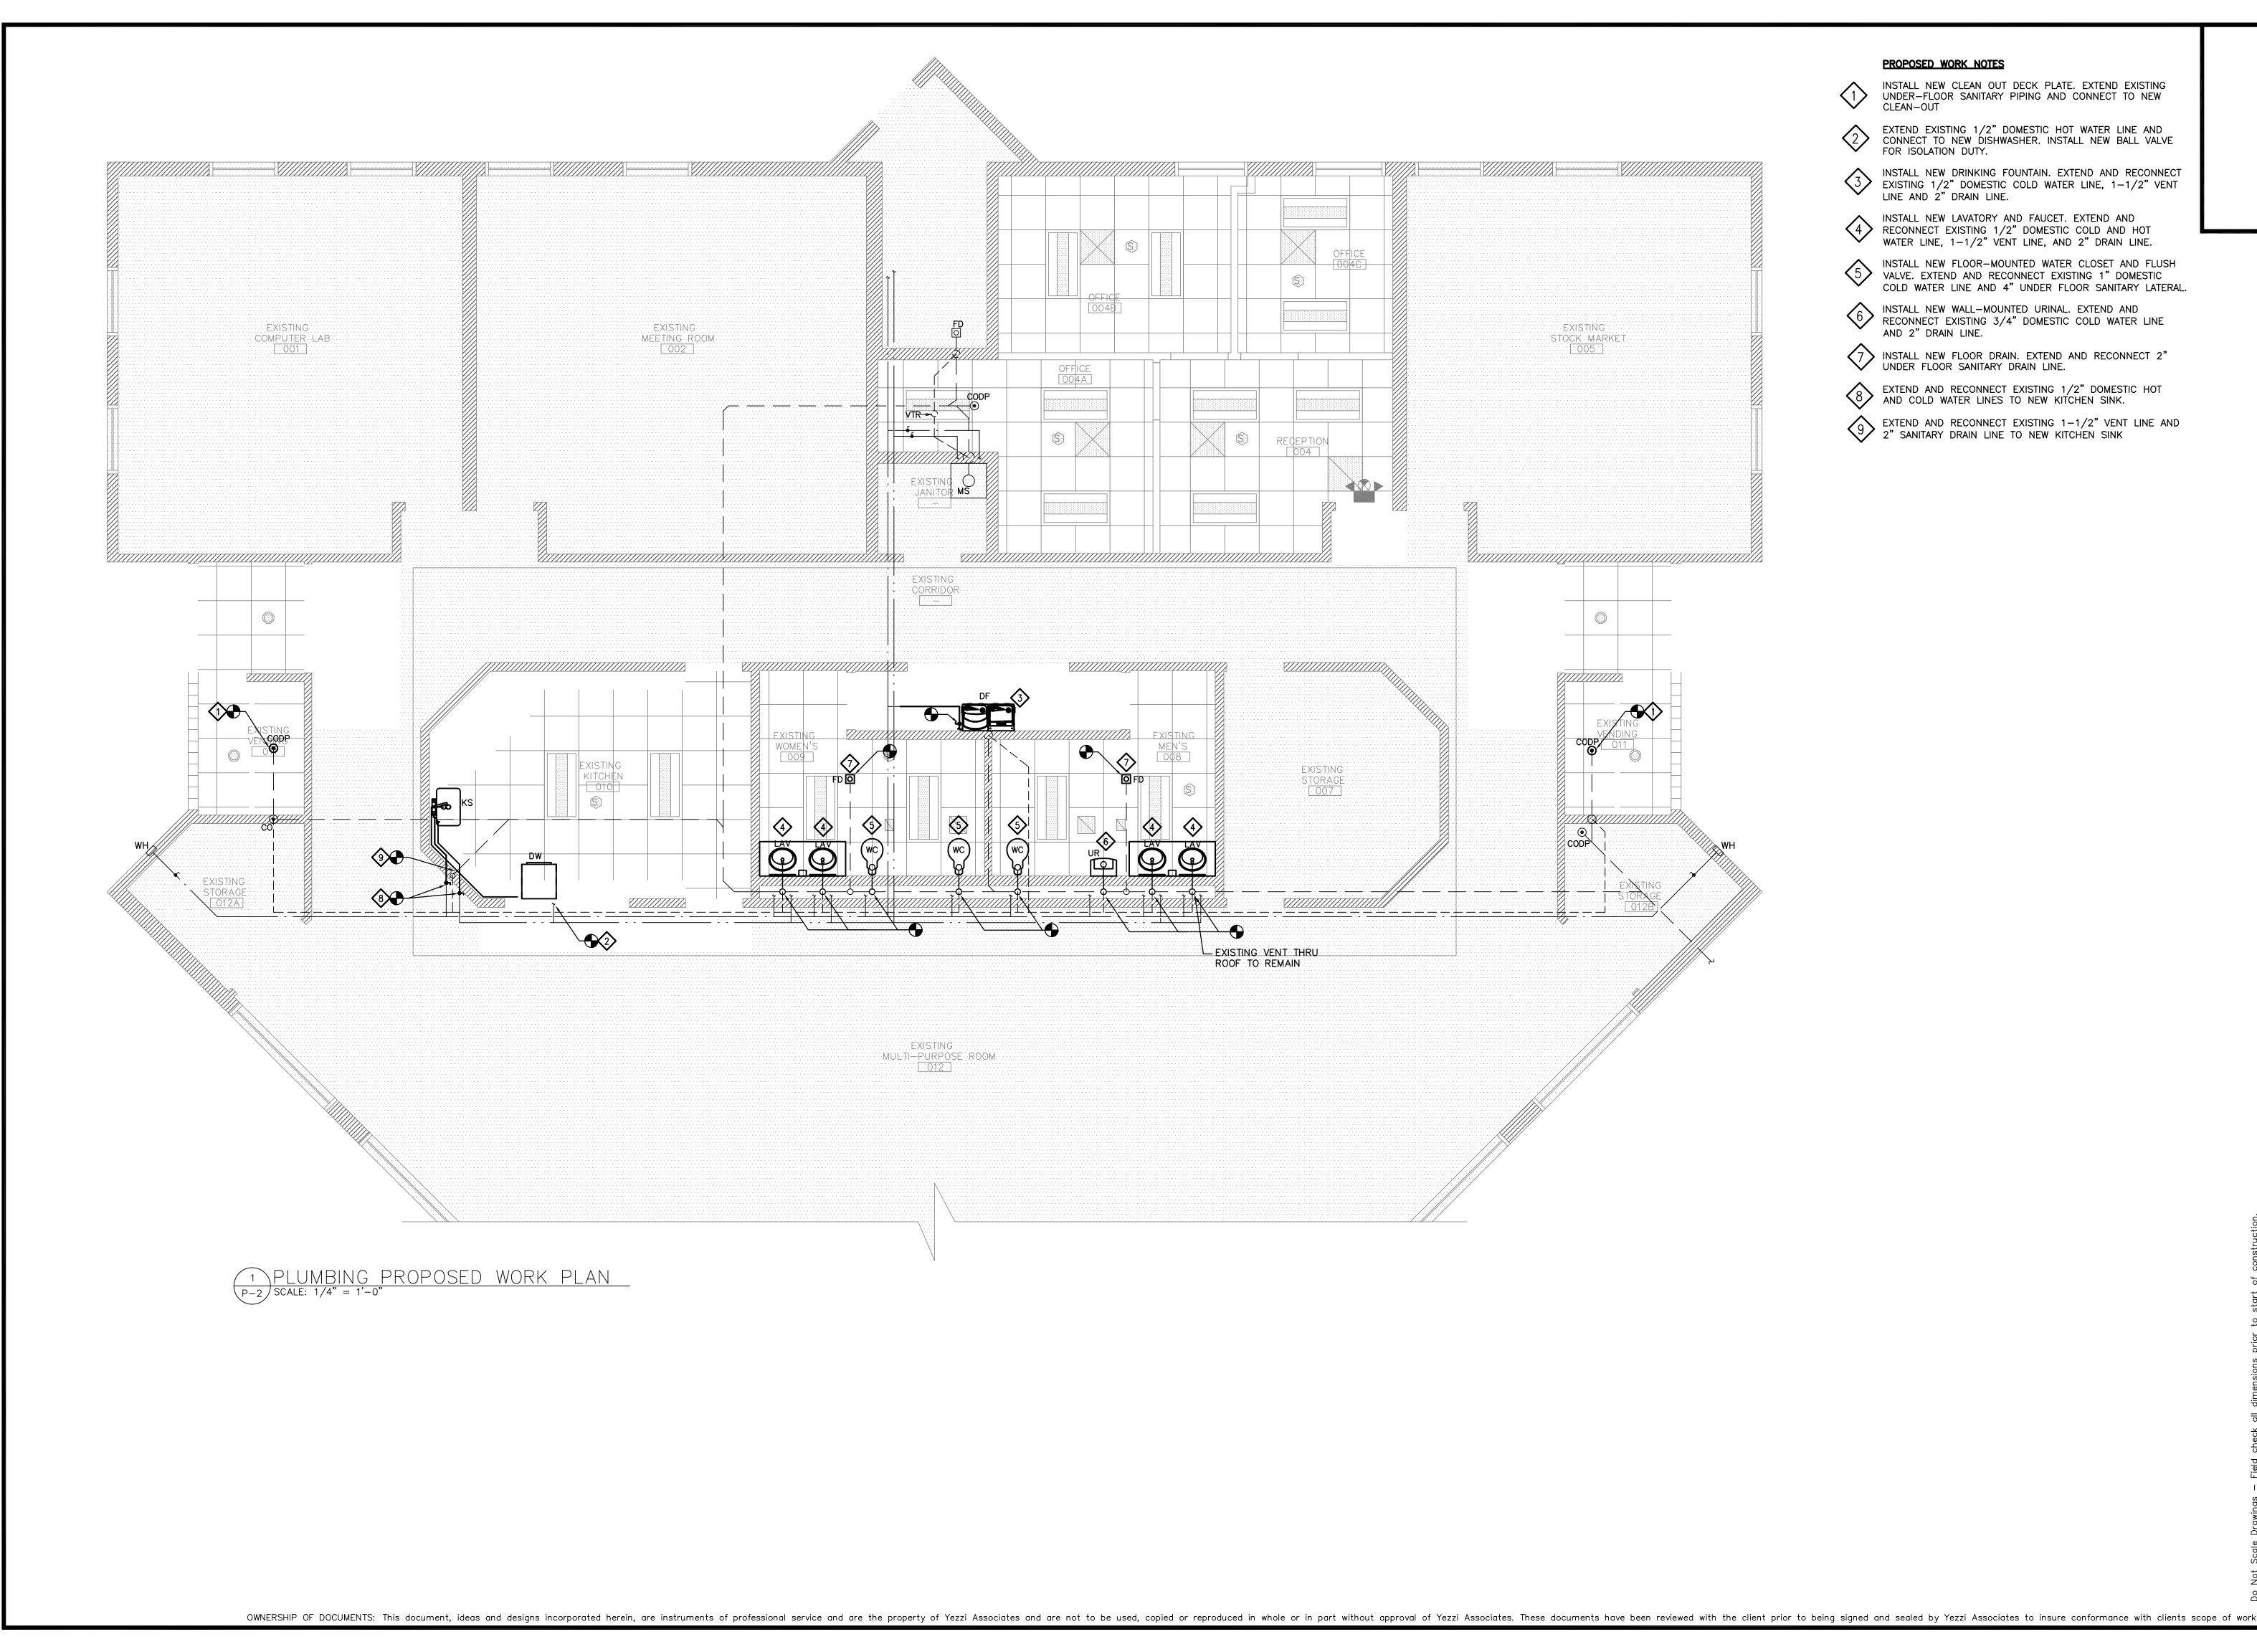
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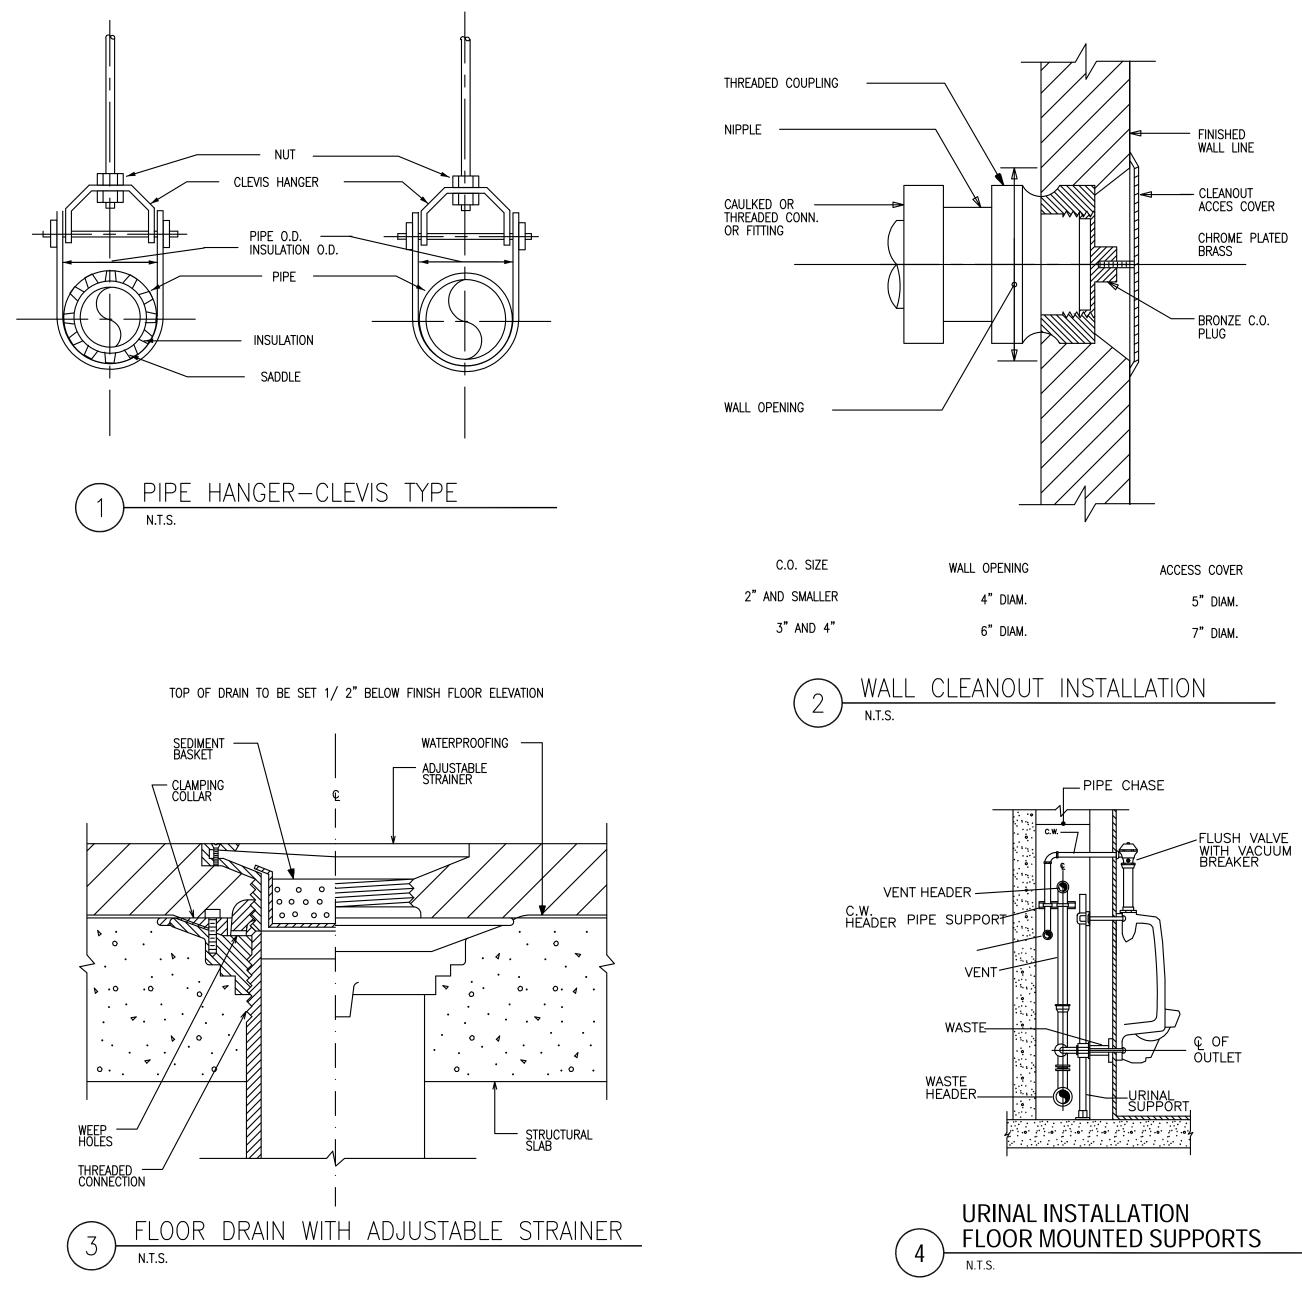
YC20122





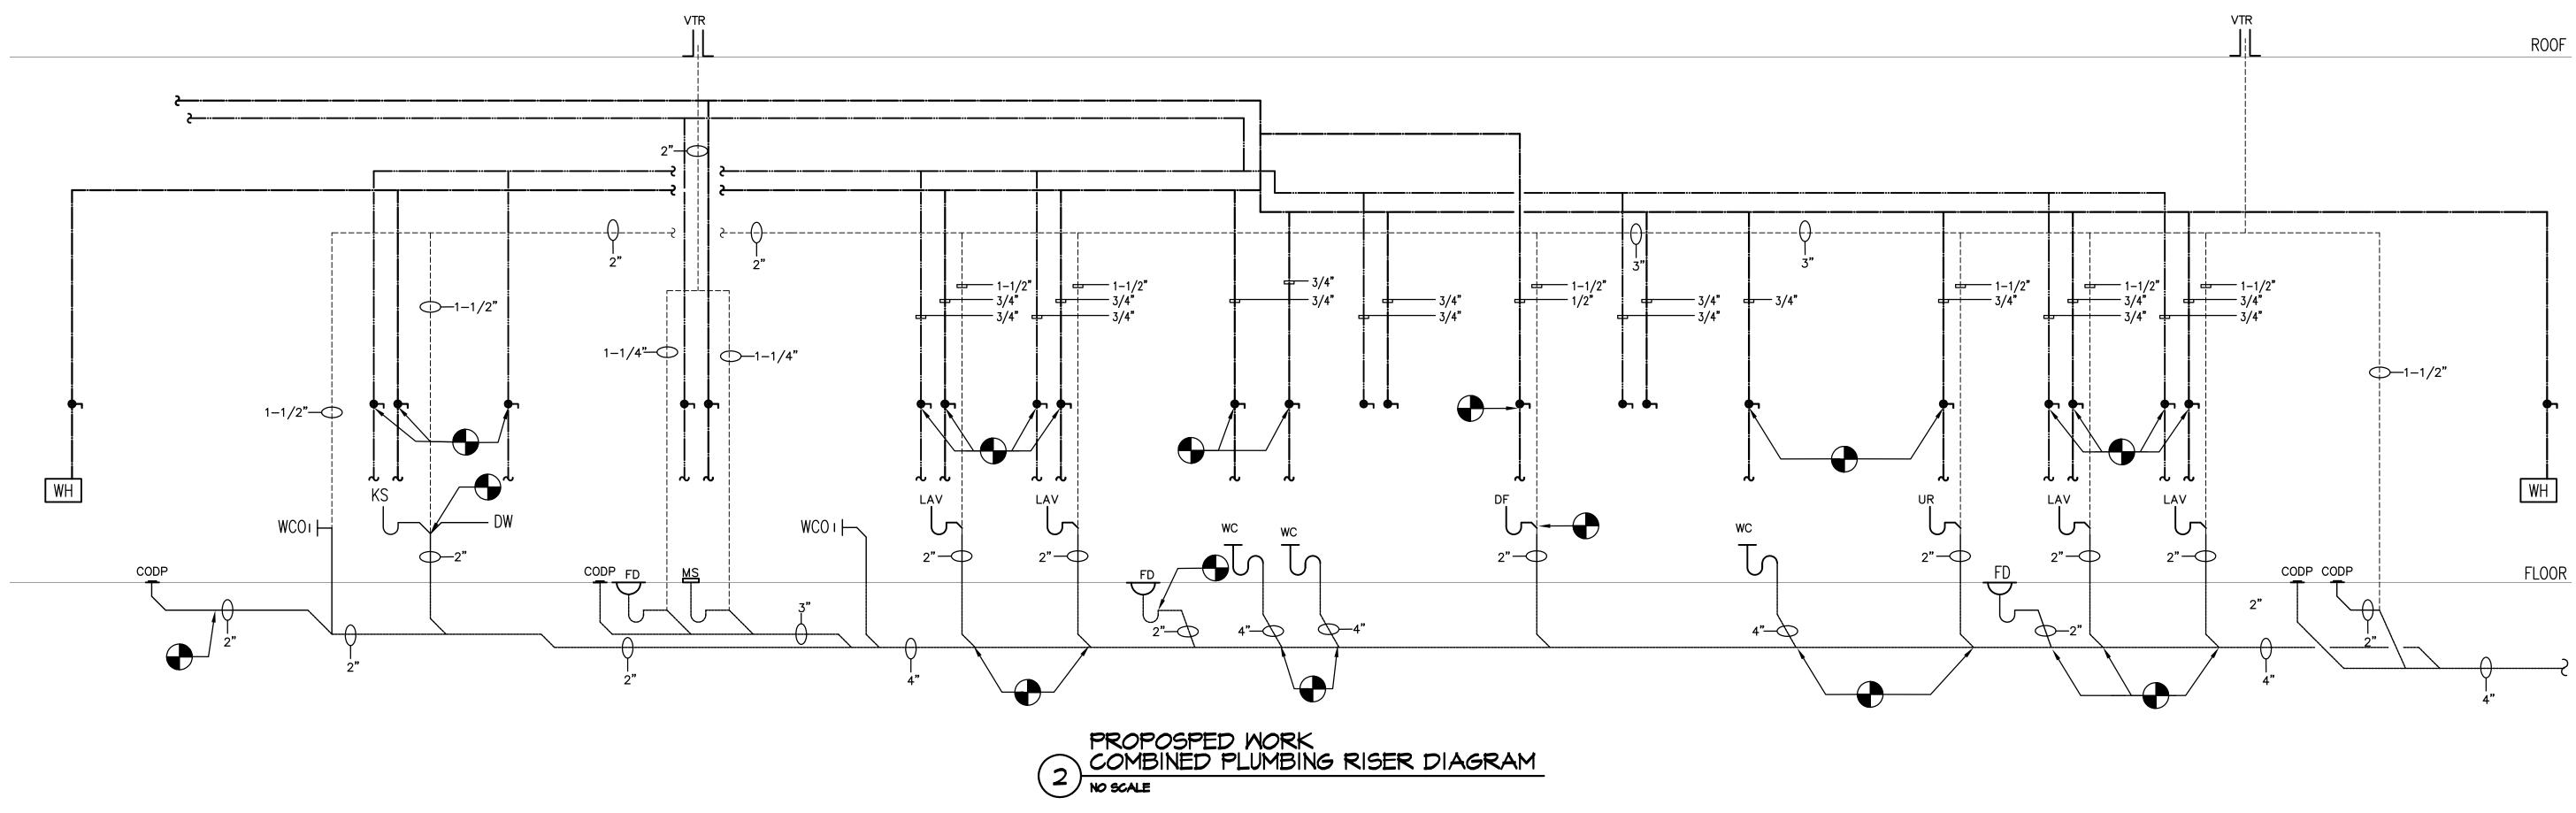



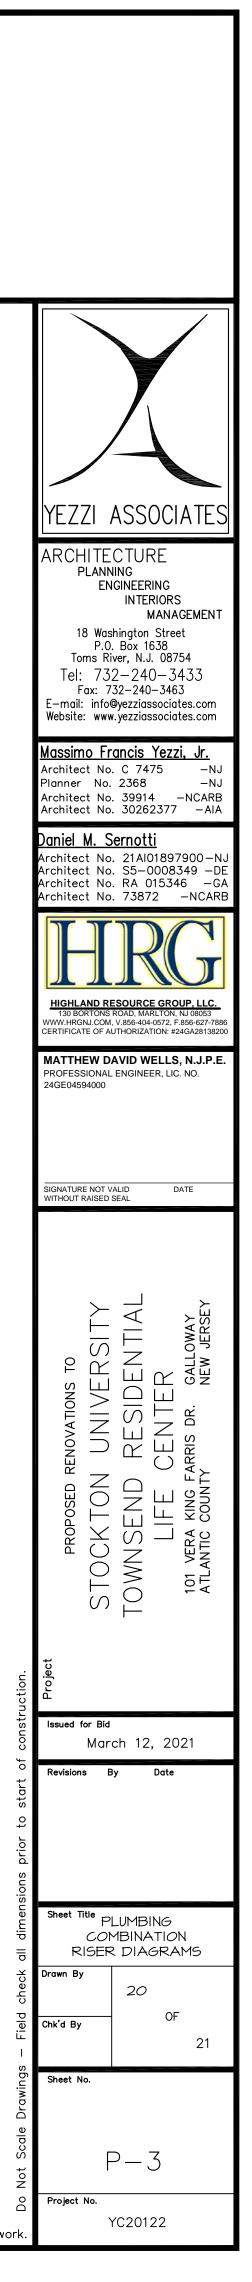

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| | Website: www.yezziassociates.com <u>Massimo Francis Yezzi, Jr.</u> Architect No. C 7475 -NJ |
| | Planner No. 2368 —NJ Architect No. 39914 —NCARB Architect No. 30262377 —AIA |
| | Daniel M. Sernotti Architect No. 21Al01897900-NJ Architect No. S5-0008349 -DE Architect No. RA 015346 -GA Architect No. 73872 -NCARB |
| | HIGHLAND RESOURCE GROUP, LLC. 130 BORTONS ROAD, MARITON, NJ 08053 |
| | WWW.HRGNJ.COM, V.856-404-0572, F.856-627-7886 CERTIFICATE OF AUTHORIZATION: #24GA28138200 MATTHEW DAVID WELLS, N.J.P.E. PROFESSIONAL ENGINEER, LIC. NO. |
| | 24GE04594000 |
| | SIGNATURE NOT VALID DATE WITHOUT RAISED SEAL |
| | PROPOSED RENOVATIONS TO STOCKTON UNIVERSITY TOWNSEND RESIDENTIAL LIFE CENTER 101 VERA KING FARRIS DR. CALLOWAY ATLANTIC COUNTY NEW JERSEY |
| struction. | L C L Issued for Bid |
| to start of construction. | March 12, 2021 Revisions By Date |
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